CB ANDERSON ARCHITECTS PLLC



Date: February 18th, 2020

To: **SDCI**

Re: Pre-approved Accessory Dwelling Unit Submittal URBAN STACK DADU

CATEGORY:

Family Friendly DADU

PROJECT DESCRIPTION

Compact two-story DADU with relatively small foot print of 454 SF. The L-shaped contemporary design features a single slope roof, a covered entry and the possibility of a patio. The DADU with a width of 20' and a 16' base height allows for placement on a lot as narrow as 30'.

The First Floor contains an open Living/Dining/Kitchen area with a small Kitchen pantry, Coat Closet and a Powder Room. The Second Floor has two Bedrooms and a Bathroom with stacked washer/dryer unit. The Second Floor layout of the DADU is well suited for residents with varying needs such as a single-parent with one or two children or a couple using the Second Bedroom as a Study, Guest Room or Home Office.

DESIGN CRITERIA NARRATIVE

- Low Cost: Design keeps building shape and roof simple. One area for gutter minimizes trenching. Use of affordable and readily available finishes such as cement board siding. Plumbing needs are localized to one part of the building.
- Green Building: This DADU shows 2x6 walls furred-out to 2x8 to accommodate R-30 wall insulation, windows with a U-Value of 0.25 and full R-10 insulation under the slab on grade. This efficient building envelope will reduce the energy consumption for heating and cooling. The single shed roof allows for the largest square footing for solar panels
- Privacy: Bedrooms are on the second floor. Two sides of the structure have limited openings to allow for the rotation of the structure for privacy needs.
- Context: The exterior finishes can be adjusted to fit with the prevailing style of the neighborhood.
- Culturally Responsive Design: The layout is responsive to a variety of needs such as separating kitchen from living space, providing a place for shoes, and separating the toilet from the washing sink. Furthermore, because of the small footprint, it is possible to rotate the house so that toilets do not face the direction of holy sites, and to alternatively rotate the building so that the entrance does face a desirable direction.
- Constructability: The simple exterior, roof shape, and finishes allow homeowners to do a substantial amount of the construction themselves.

206 782-2911

7209 Greenwood Ave N Seattle WA 98103

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ESTIMATE OF CONSTRUCTION COSTS

This DADU has been permitted and is currently under construction. The contractor estimates costs at approximately \$250 per square foot.

MAJOR MATERIALS:

The major materials needed for this project are dimensional lumber, wood sheathing, and concrete foundations, all of which can be locally sourced. The affordable siding material is cement board panel and lap siding.

MECHANICAL SYSTEMS:

Heating of DADU with a mini-split heat pumps for the main Living area, supplemental electric heat in all other rooms

Water heating with a tankless gas water heater mounted on exterior of DADU

Whole house ventilation and fresh air intake through window trickle vents


House Design Reuse Cost:

Price for the plans: \$1,000 Hourly rate for further work: \$125 / hr

CONTACT INFORMATION:


CB Anderson Architects PLLC Att: Gabi Muller 7209 Greenwood Ave N Seattle, WA 98103 Phone: 206-782-2911 e-mail: gabi@cba-arch.com

25'-0" $5'-7\frac{1}{2}''$ 10'-5|" 7'-2" BATHRM. BEDROOM CANOPY BELOW **BEDROOM** 9'-11"

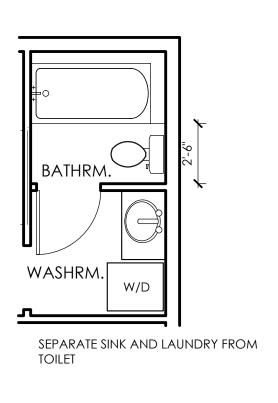


CULTURALLY RESPONSIVE PLAN VERSION

SCALE: 1/4" = 1'-0"

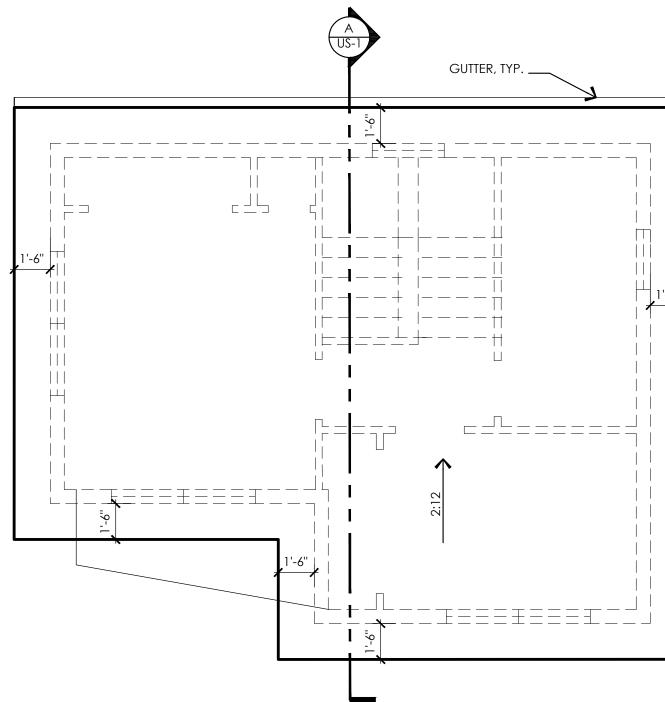


SECOND FLOOR PLAN

SCALE: 1/4" = 1'-0"

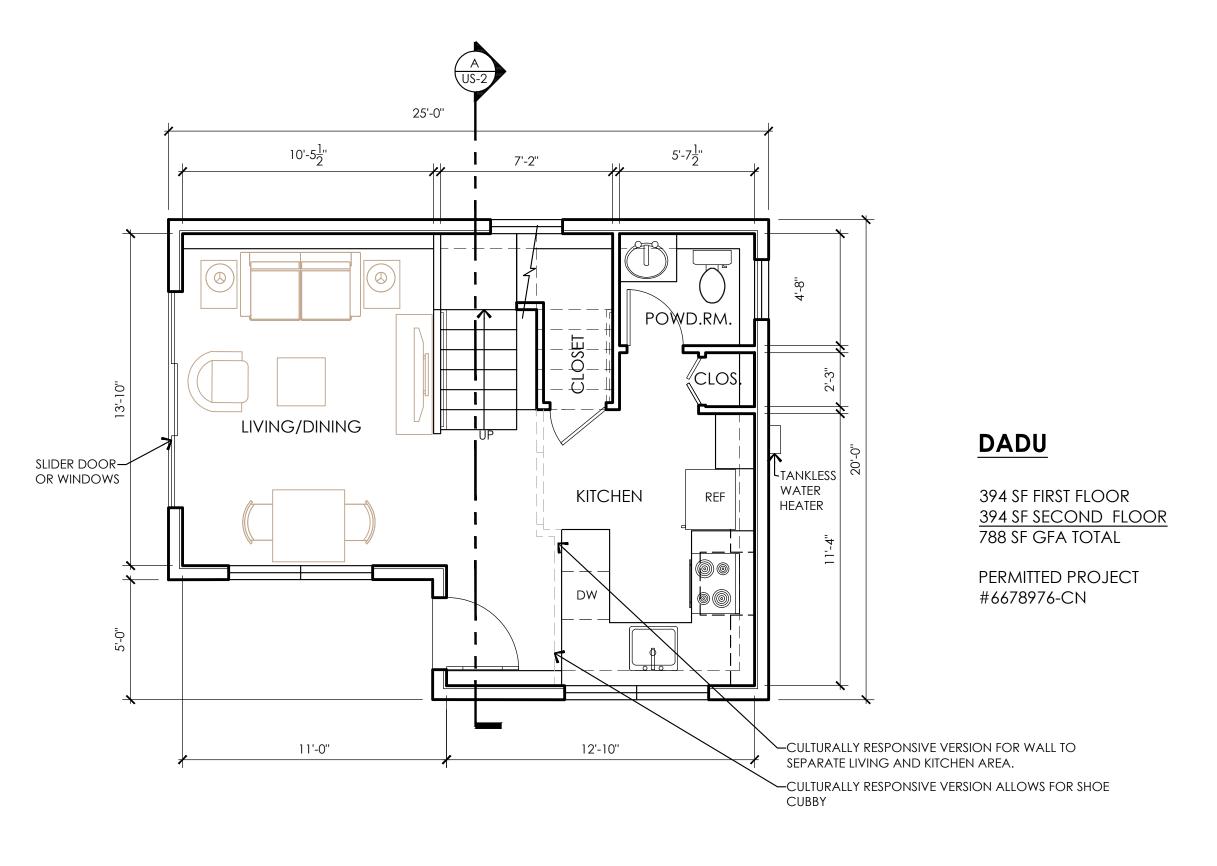


FIRST FLOOR PLAN

SCALE: 1/4" = 1'-0"

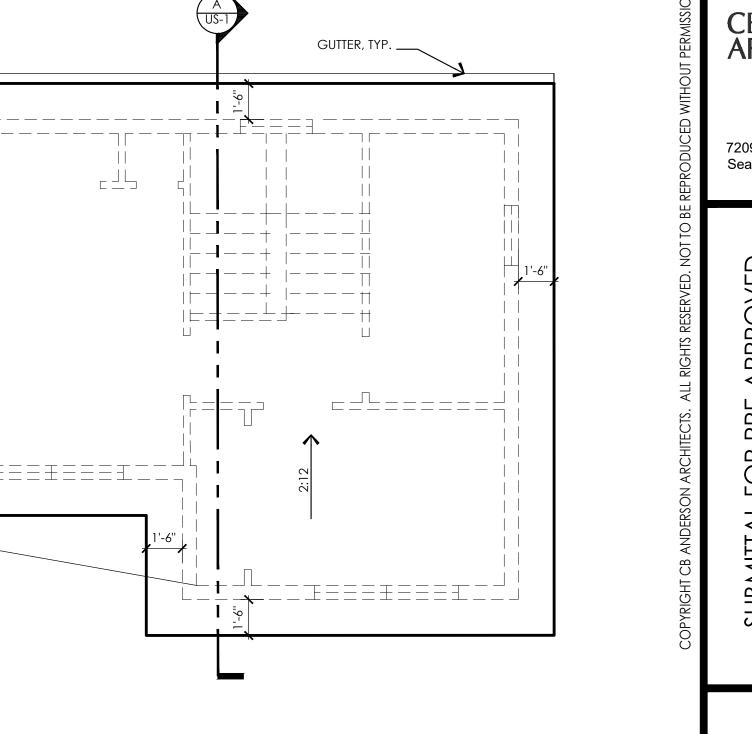


ROOF PLAN

SCALE: 1/4" = 1'-0"

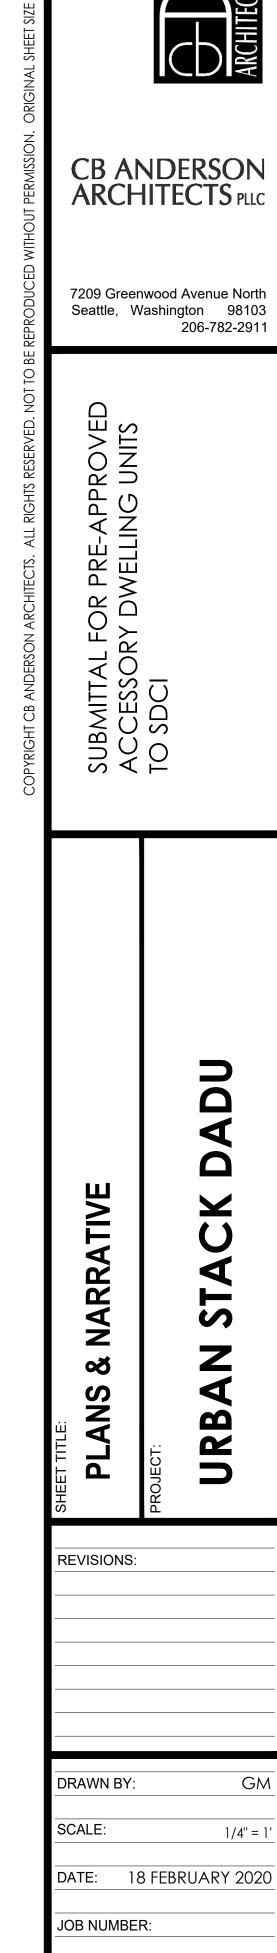


SHEET NUMBER:

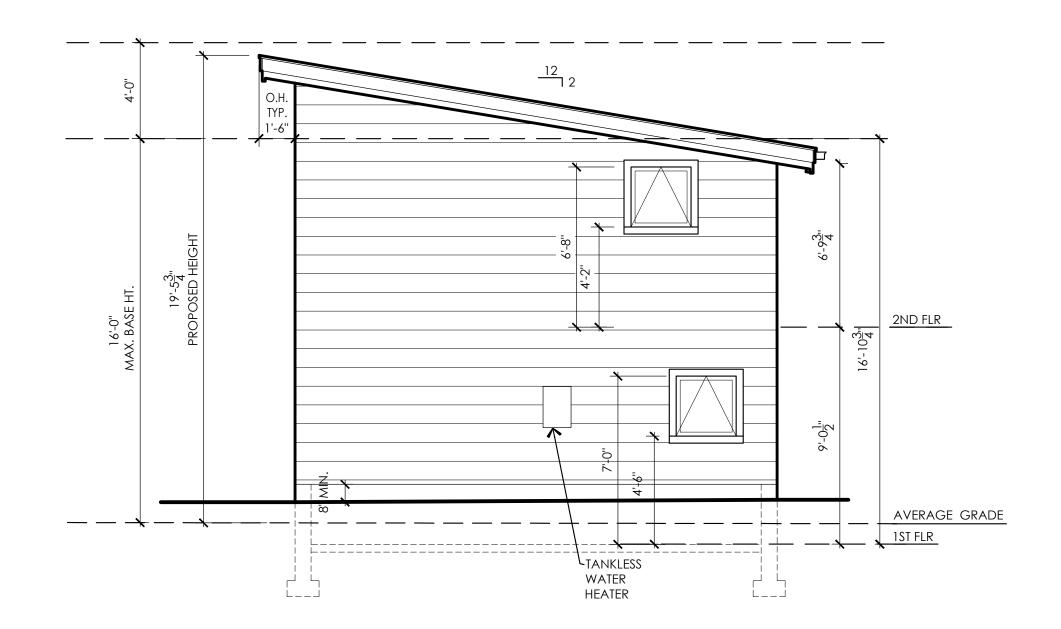


EAST ELEVATION


SCALE: 1/4" = 1'-0"

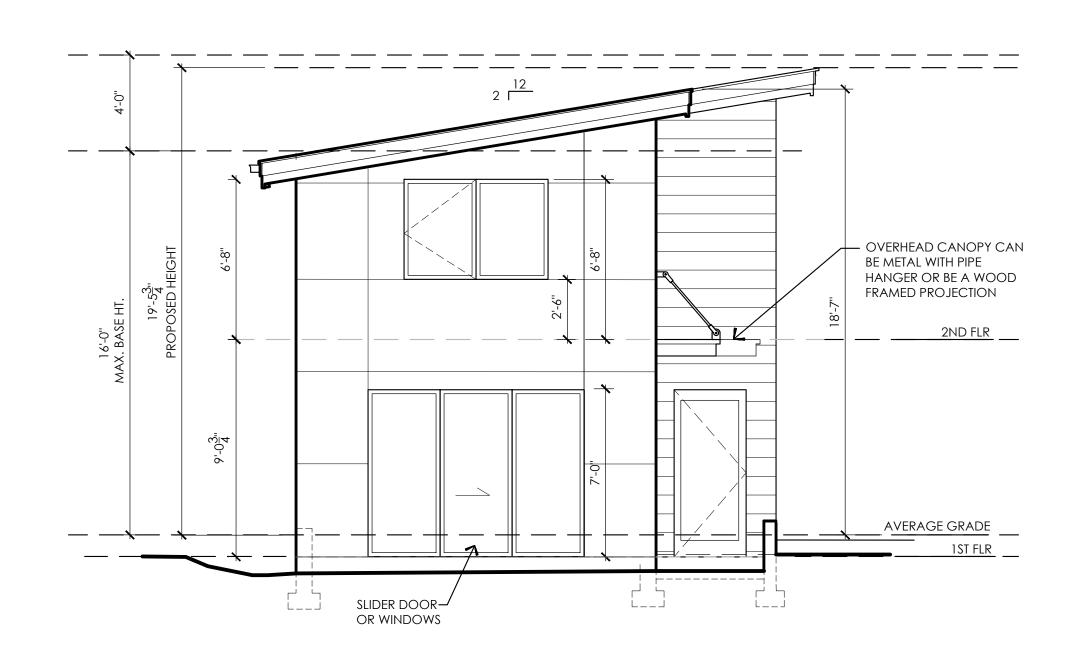

WEST ELEVATION


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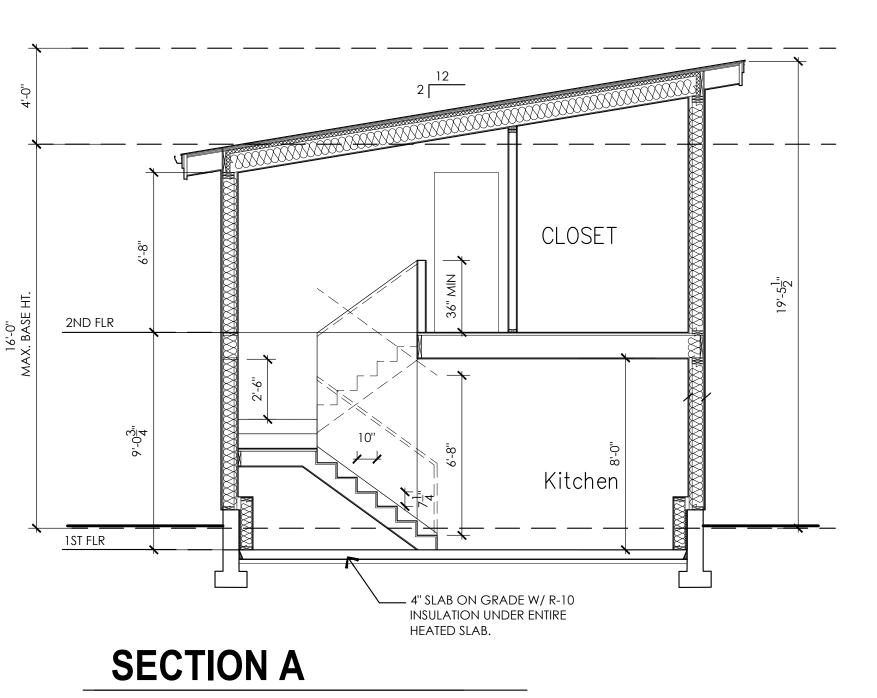
SOUTH ELEVATION

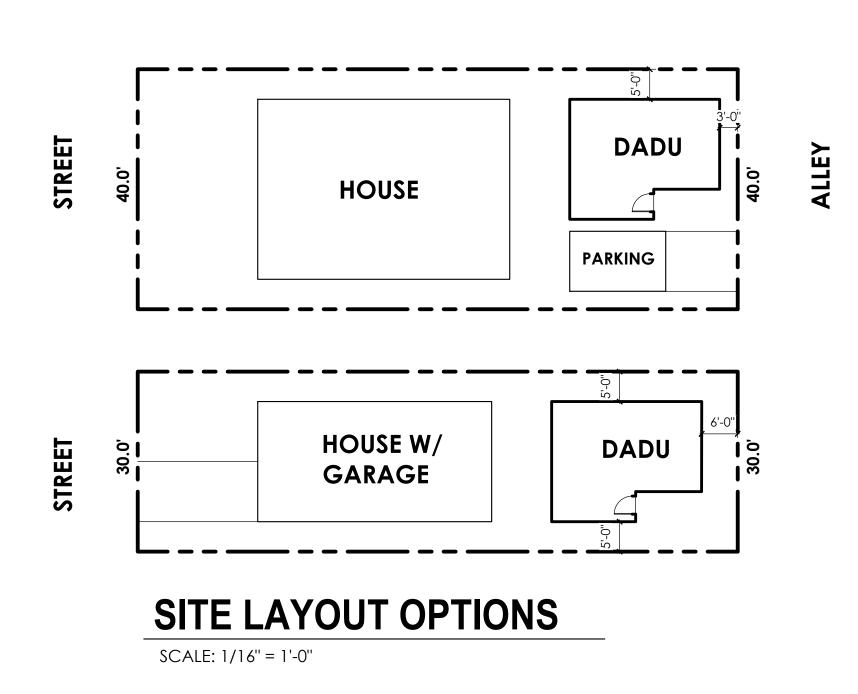SCALE: 1/4" = 1'-0"

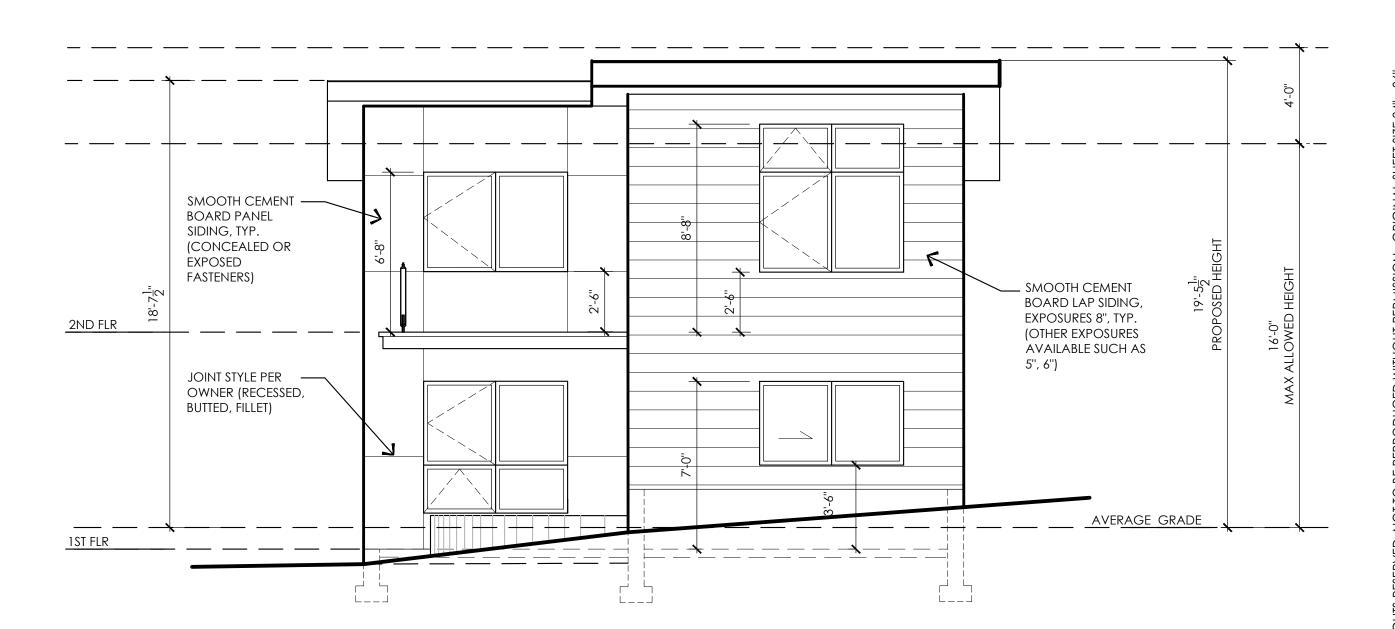

NORTH ELEVATION

SCALE: 1/4" = 1'-0"

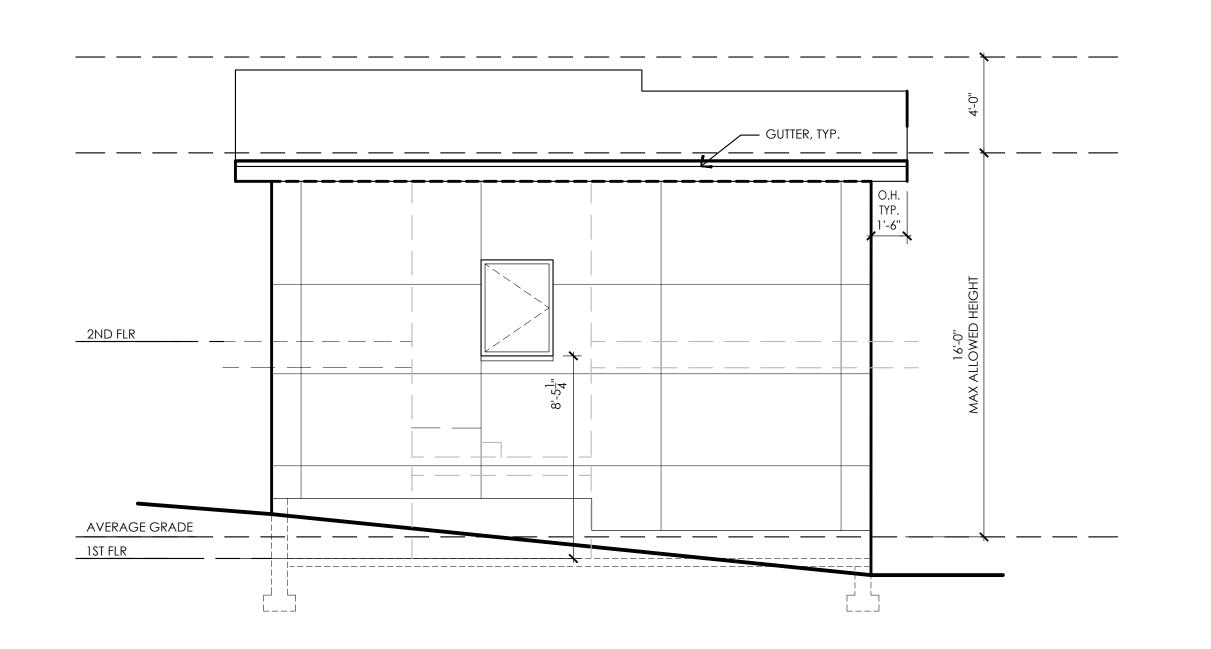

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CB ANDERSON ARCHITECTS PLLC

7209 Greenwood Avenue North Seattle, Washington 98103 206-782-2911

SUBMITTAL FOR PRE-APPROVED ACCESSORY DWELLING UNITS TO SDCI

OPTIONS ADL SITE **∞**ŏ SECTION ELEVATIONS, URBAN

REVISIONS:

DRAWN BY: SCALE: AS SHOWN DATE: 18 FEBRUARY 2020 JOB NUMBER:

SHEET NUMBER:


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3D VIEW 1



3D VIEW 3



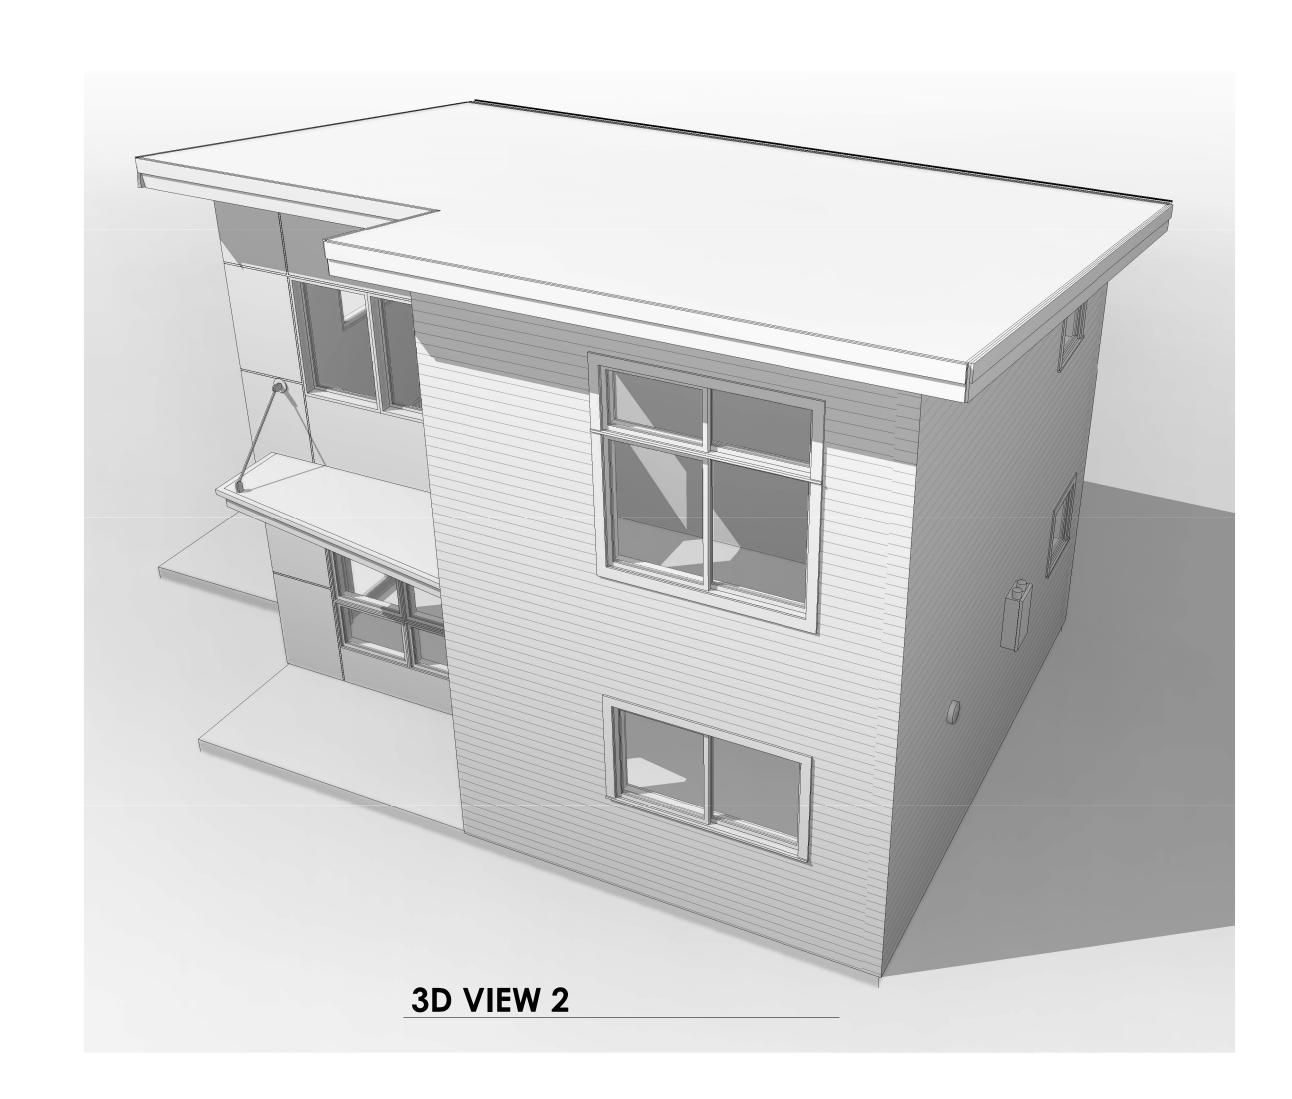

3D VIEW 4

NAL SHEET SIZE 24" X 36".		
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