
SDCI PRE APPROVED DADU

ORIGINALLY DESIGNED (UNDER PERMIT # 6588433-CN) TO FIT TIGHT LOT CONSTRAINTS, THE PROPOSED DADU ALLOWS FOR A COMPLETE YET COMPACT DWELLING UNIT THAT HAS THE ABILITY TO EASILY ADAPT TO SITE AND ZONING CONSTRAINTS. THE DADU'S MODEST FOOTPRINT WAS ESTABLISHED TO ALLOW FOR THE CONVERSION OF DATED SINGLE CAR GARAGES WITHIN PROPERTY SETBACKS, WHICH HAS BECOME A COMMON LIFELINE FOR PROPERTIES WITH LIMITED SITE AVAILABILITY. THE EXPANSION OF THE FOOTPRINT IN THE ENTRANCE ATTACHMENT ALLOWS FOR THE CONSIDERATION OF YARD SETBACKS AS WELL AS PROXIMITY TO THE PRIMARY DWELLING UNIT. AND ITS PROJECTED FORM ALLOWS FOR OPPORTUNITIES TO GATHER LIGHT AND CONNECT TO THE PRIMARY RESIDENCE. THE UNITS SIMPLIFIED FORM ALLOWS THE STRUCTURE TO MAINTAIN THE VERNACULAR OF THE NORTHWEST REGION WHILE STAYING BENIGN ENOUGH TO FIT WITHIN MOST CONTEXTS.

THE PROPOSED PLAN STRIVES FOR A MANAGEABLE AND EFFICIENT DESIGN THAT CAN BE BUILT AFFORDABLY AND REQUIRES A MINIMAL NUMBER OF SPECIALIZED TRADES. FOR THE MOST PART THE DWELLING CAN BE BUILT BY A COMPETENT HOMEOWNER DUE TO SIMPLIFIED FOUNDATIONS, FRAMING, AND INSULATION WITH ONLY MINOR WORK NEEDED FROM ELECTRICAL AND PLUMBING TRADES. THE TRADITIONAL AND SUBDUED CONSTRUCTION INHERENT IN THE DESIGN ALLOWS THE DADU TO SIT WITHIN OLDER SEATTLE NEIGHBORHOODS WITHOUT DIMINISHING THE CHARACTER OF THE SURROUNDING STRUCTURES. IN DOING SO THIS RESIDENCE WOULD EASILY FUNCTION IN MOST BACK YARDS, EITHER MATCHING OR STANDING OUT FROM THE PRIMARY RESIDENCE WITH CAREFUL CONSIDERATION TO FINISHES. THE PROPOSED SPACE PLAN PROVIDES AN EFFICIENT LAYOUT THAT ALLOWS FOR ALL MAJOR FUNCTIONS OF A RESIDENCE WHILE STILL MAINTAINING A MINIMAL FOOTPRINT. THE NORTH AND WEST WALLS ARE PROPOSED WITH BLANK FACADES TO ALLOW FOR FIREPROOFING IF LOCATED ADJACENT TO PROPERTY LINES AND TO ALLOW FOR PRIVACY FROM NEIGHBORING RESIDENCES. THE OPEN NATURE OF THE CENTRAL STUDIO SPACE ALLOWS FOR A GREATER CONNECTION TO THE EXPECTED AMENITY OF THE LOTS YARD, WHILE ALSO ALLOWING FOR THE SPACE TO OPEN UP TO THE EXTERIOR FOR A MUCH MORE GENEROUS SPACE. THE SINGLE-STORY NATURE OF THE RESIDENCE, AS WELL AS THE MINIMAL NUMBER OF EGRESS PATHWAYS THROUGH THE SPACE MAKE THE DWELLING APT FOR PROPERTIES THAT NEED ACCESSIBLE FUNCTIONS. MINOR ADJUSTMENTS TO CASEWORK AND THE ADDITION OF RAMPS PER THE SITE'S CONDITIONS WOULD EASILY ALLOW FOR THIS DADU TO FUNCTION AS AN ACCESSIBLE RESIDENCE.

PROPOSED DADU HAS A FOOTPRINT OF 265 SQFT

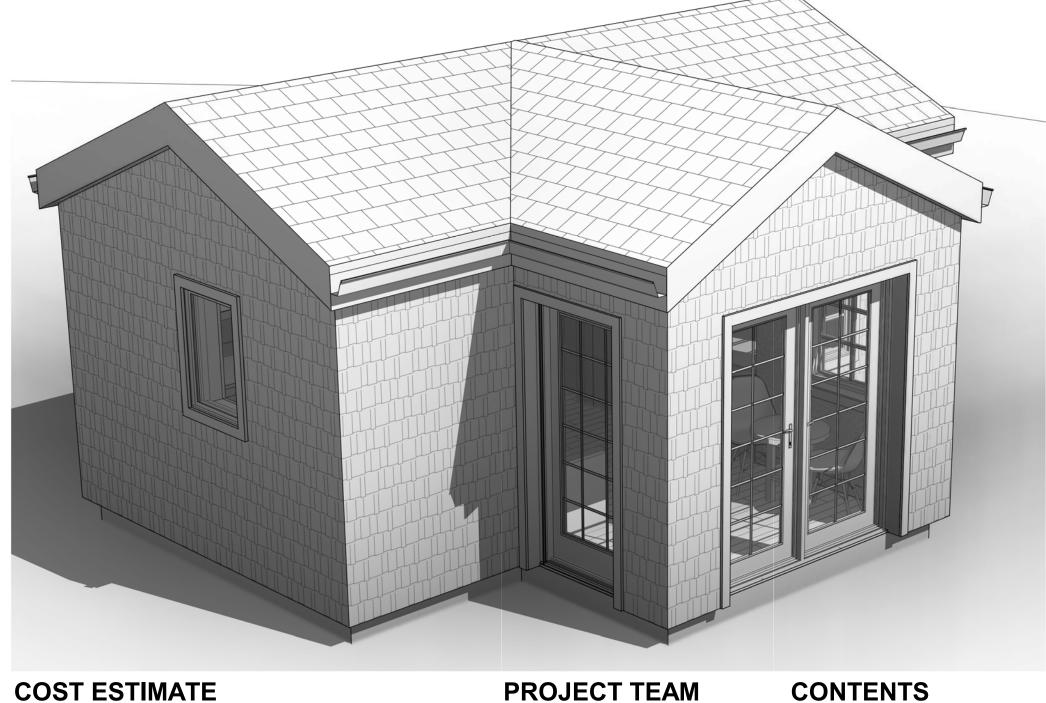

COST ESTIMATE

COST ESTIMATE: \$135K-\$200K BASED ON SITE CONDITIONS AND ENLISTMENT OF GENERAL CONTRACTOR. ESTIMATE BASED ON CONSTRUCTION OF PERMIT #6588433-CN IN SUMMER - EARLY FALL OF 2019 WHICH RESULTED IN A CONSTRUCTION COST OF ABOUT \$135K. COSTS INCLUDE DEMOLITION OF EXISTING GARAGE AND TIE IN TO EXISTING SIDE SEWER. MAJORITY OF WORK COMPLETED BY LABOR ORGANIZED BY THE HOMEOWNER, SPECIFIC TRADES COMPLETED BY LICENSED ELECTRICAL AND PLUMBING SUBCONTRACTORS. ALL WORK OVERSEEN BY HOMEOWNER, NO GENERAL CONTRACTOR WAS HIRED.

PROJECT TEAM

STOCK & ASSOCIATES, INC 99 BLANCHARD

SEATTLE. WA 98121

T 206.443.0494

BSTOCK@STOCKANDASSOCIATES.COM ZBRUHN@STOCKANDASSOCIATES.COM

\$1,000

\$100/HR

PRICE PER PLAN **HOURLY RATE**


SHEET NO. SHEET NAME

ARCHITECTURAL Α0 **COVER SHEET** Α1 **PLANS** A2 **SECTIONS** A3 **ELEVATIONS**


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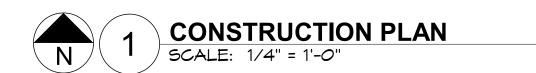


A4



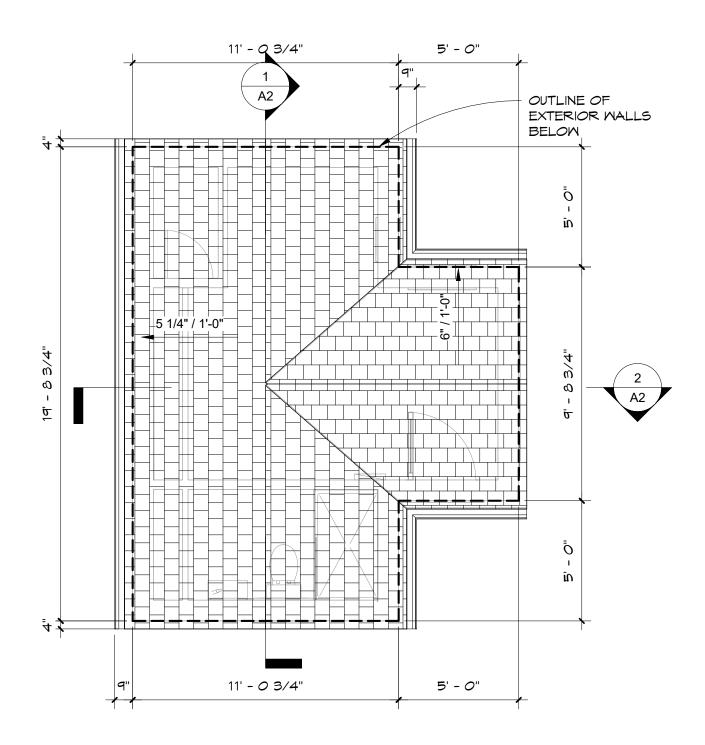




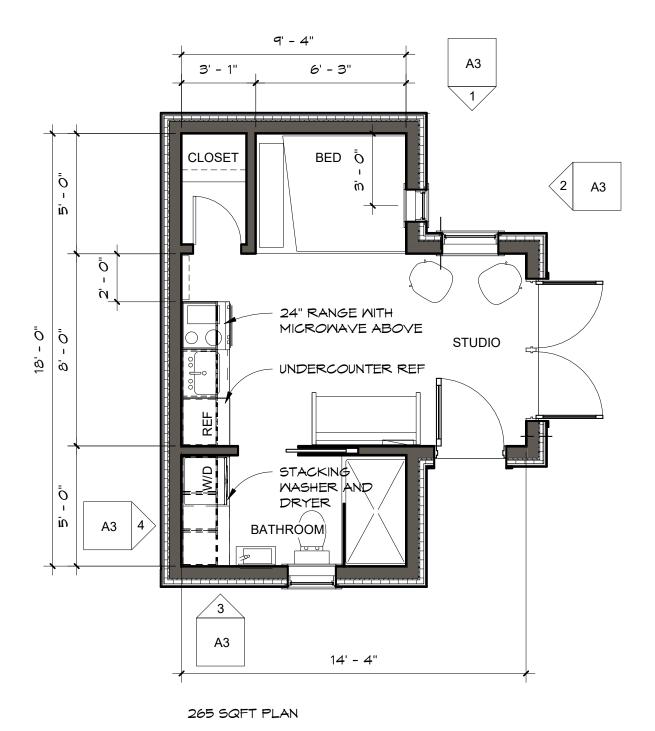

SITE ADDRESS TBD 02/17/20

A1|

PLANS

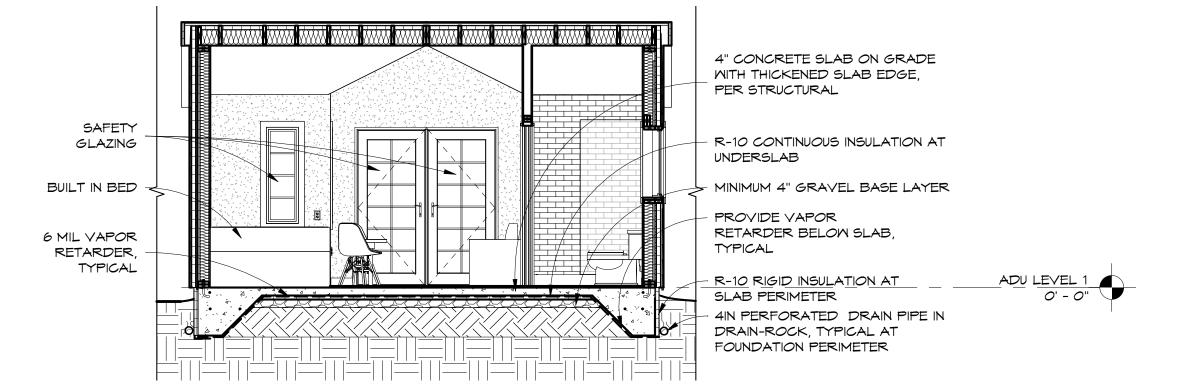

EAST BUILDING SECTION

SCALE: 1/4" = 1'-0" ROOF ASSEMBLY <u>0</u> ō Ī Ī-

3 TAB SHINGLE ROOF 2 LAYERS OF 15# FELT PLYMOOD SHEATHING 2X10 FRAMING 2" MINIMUM SPRAY FOAM INSULATION

7.25" BATT INSULATION 5/8" TYPE "X" GYPSUM DRYWALL

MALL ASSEMBLY CEDAR SHINGLE SIDING 2" EXTERIOR RIGID INSULATION PLYWOOD SHEATHING 1" MINIMUM SPRAY FOAM INSULATION

4.5" BATT INSULATION 5/8" TYPE "X" GYPSUM DRYWALL

CONSTRUCTION DETAILS

MAJOR MATERIALS: WOOD FRAME CONSTRUCTION POURED CONCRETE FOUNDATION GYPSUM WALLBOARD BATT INSULATION BAYSEAL SPRAY FOAM INSULATION CONTINUOUS EXTERIOR RIGID INSULATION CEDAR SHINGLE SIDING THREE TAB SHINGLE ROOFING


MAJOR MECHANICAL SYSTEMS INCLUDE ELECTRIC WALL HEATERS AND ELECTRIC IN FLOOR HEATING (AT BATHROOM). AIR INTAKE THROUGH PASSIVE AIR SYSTEMS AND WHOLE HOUSE FAN. INSTANT WATER HEATER TO SERVICE ALL PLUMBING.

ADU LEVEL 1 0' - 0"


SOUTH BUILDING SECTION SCALE: 1/4" = 1'-0"

STOCK&ASSOCIATES

DADU **SECTIONS** SITE ADDRESS TBD 02/17/20

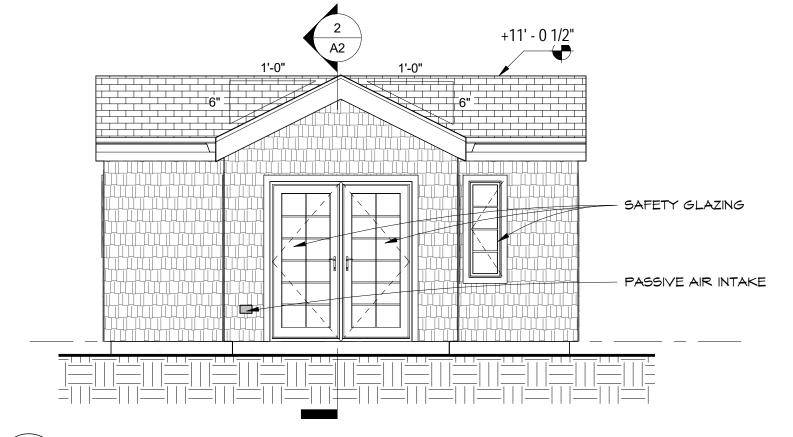




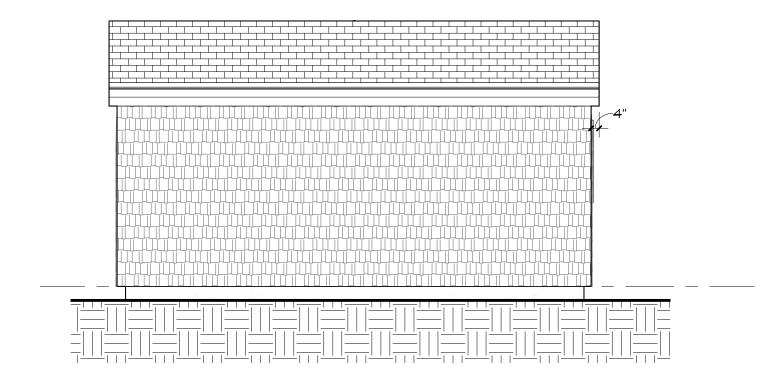

EXTERIOR WEST ELEVATION




SCALE: 1/4" = 1'-0"

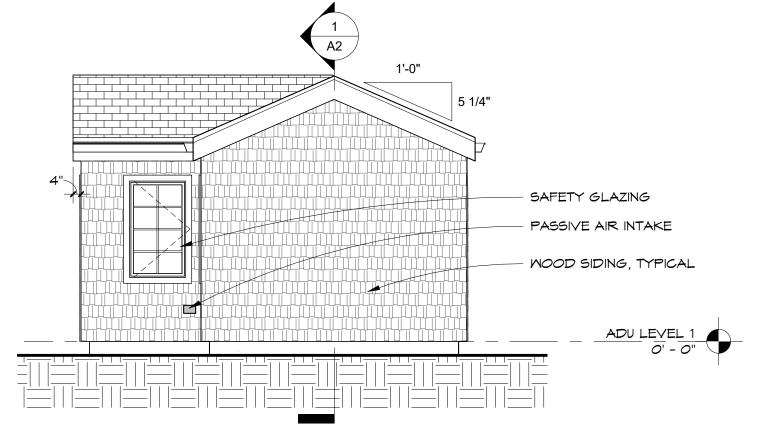

EXTERIOR NORTH ELEVATION

SCALE: 1/4" = 1'-0"

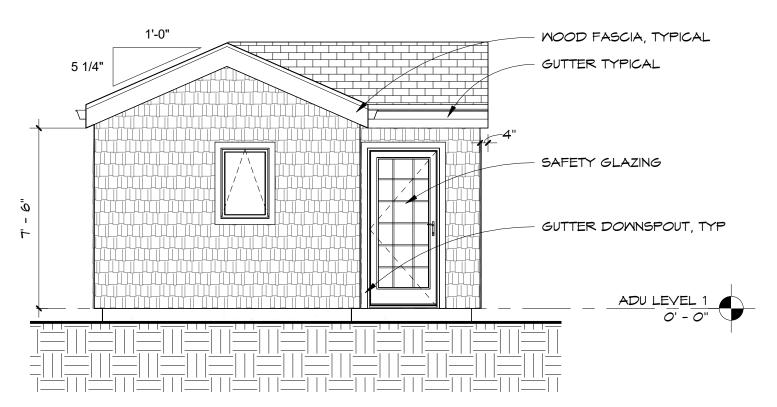

EXTERIOR SOUTH ELEVATION SCALE: 1/4" = 1'-0"

DADU

ELEVATIONS SITE ADDRESS TBD A3|

02/17/20







