September 6, 2022

Permit No. 6868236-CN

Project Address 812 23rd Ave Seattle, WA 98122

Landmarks Designation Twenty-Third Avenue Rowhouses Group

Ordinance No. 106348 // 108732

CERTIFICATE OF APPROVAL

Application for Certificate of Approval from Landmarks Preservation Board for a proposed addition to an existing single family residence located at 812 23rd Ave which is part of the "23rd Ave Rowhouses Group".

PROJECT DESCRIPTION:

Abbreviated Site History (post-1978)

In 1978 the Seattle Historic Preservation Office conducted a city-wide survey to document structures of significance. The survey listed a row of six contiguous residences on 23rd Ave known as the "23rd Avenue Rowhouse Group". Originally built in 1893 the group of homes was identified as the last intact example inside the city of working-class housing built in the Victorian vernacular. In 1979 Ordinance #108732 was passed to define the "23rd Avenue Rowhouses Group" as a designated as a landmark. The group included six single family residences addressed at 812 - 828 23rd Ave. The ordinance imposed controls which stated that a Certificate of Approval must be obtained to "make alterations to the exteriors of all buildings and the entire site." Approximately tens years later, based on available aerial photographic records, the original "rowhouse" structure located at 812 23rd Ave was demolished. The removal of the home appears to have occurred without proper approval and the lot sat vacant for 30+ years.

Proposal for New SFR (2007)

Submitted as the "Marion Residence" in 2007 a new home by Pb Elemental proposed a reinterpretation of the original historic form in a contemporary manner. The massing strategy for the new structure was to emulate the scale and setbacks of the northern neighbors and mimic the familiar glazing strategy seen on the front façades of all the rowhouses. There were two exterior materials proposed in the application – cedar siding and fiber cement panels.

The dominant exterior material on the street façade is 4" cedar boards stained in a natural tone which pairs with the narrow wood siding on the existing rowhouse group but with a modern the application of an open-joint rainscreen. The smooth fiber cement panels were also applied in an open-joint rainscreen fashion and arranged in a 2' stacked pattern. The panel break lines are aligned with black framed windows. The front awning was a simple steel c-channel supported with a tie back rod. The upper attachment plate for the tie rod was held high on the cedar façade to create an exaggerated slope which matches the steep pitched roofs on the existing rowhouses.

Approved Materials from 2007 Certificate of Approval

The Landmarks Preservation Board issued an approval letter (*dated 9/24/2007*) for the construction of the new residence. The Certificate of Approval stated that the proposed new residence did not adversely affect the features or characteristics specified in Ordinance #108732 and that the proposed new construction would not destroy historic materials that characterize the property. The Certificate of Approval also confirmed that the proposed design was compatible with the massing, size, scale and architectural features of the 23rd Ave Houses Group.

Proposed Project – SFR Addition Summary // 2022

The current proposed project [6868263-CN] proposes a rear addition to the existing home with a small expansion on the first floor and a larger expansion on the second floor which extends over the existing rear surface parking. The addition is compliant with the underlying zoning – Residential Small Lot – and extends from portions of the existing east façade. The height of the rear addition is aligned with the lower parapet of the existing house and is approximately 7' below the allowable height limit. All exterior siding materials on the proposed addition are to match the exterior materials that were previously approved by the Landmarks Preservation Board in 2007.

New & Existing Exterior Materials

The proposed exterior materials for the addition will match those of the existing home which were given approval by the Landmarks Preservation Board in 2007 and constructed in 2009. The full scope of this project includes re-painting and re-staining the existing siding materials of the whole house adding life and longevity to the exteriors. The controls listed under Ordinance #108732 would apply to both existing and proposed siding materials and finishes.

Full Plan Set Submittal and Supportive Documentation

This submittal to the Landmarks Preservation Board includes a plan set which identifies existing conditions, specifies proposed exterior assemblies, provides visualization of the proposed addition, and rendered building elevations for both existing and proposed conditions. Some of these plan sheets have been included in the Building Permit submittal under record number 6868263-CN. The plan sheets labeled as "CA" are unique to this application for a Certificate of Approval. Along with the full plan set, the upload of this application also includes:

- National Register of Historic Places Inventory Nomination Forms
- Ordinance 108732
- Certificate of Approval issued for the construction of new residence in 2007

This application is being submitted as the final design and is intended to be thorough and complete. I trust the board will agree with a determination of completeness for this application. Thank you for your consideration and I look forward to the board's review of the project.

Sincerely,

Greg Squires | Principal CONE ARCHITECTURE LLC

KEY ABBREVIATIONS

MECH **MECHANICAL** AND **EXISTING** MEMB MEMBRANE NEW MEZZ MEZZANINE MFR MANUFACTURER CENTERLINE MIN CL MINIMUM MISC MISCELLANEOUS ACT MO MASONRY OPENING ACOUSTICAL CEILING TILE MTD MOUNTED ADJ ADJUSTABLE; ADJACENT ABOVE FINISH FLOOR MTL METAL ALT ALTERNATE ALUM ALUMINUM NORTH **APROX** APPROXIMATE N/A **NOT APPLICABLE** NIC ARCH ARCHITECT NOT IN CONTACT NTS NOT TO SCALE BETWEEN BOARD OC ON CENTER BITUMINOUS OCC OCCUPANCY BLDG OD OUTSIDE DIAMETER BUILDING OPNG во BOTTOM OF .. OPENING CAB PERF PERFORATED CABINET CALC'S CALCULATIONS PERP PERPENDICULAR CANT CANTILEVER PL PROPERTY LINE PLAM CB CATCH BASIN PLASTIC LAMINATE CIP CAST-IN-PLACE PLAS. PLASTER CLOSET PLYWD PLYWOOD CL PR CLG CEILING PAIR PRCST **PRECAST** CLKG CAULKING CLR CLEAR PROP PROPERTY CARBON MONOXIDE PVC CM POLYVINYL CHLORIDE DETECTOR CMU CONCRETE MASONRY UNIT QTY QUANTITY COL COLUMN CONC CONCRETE RISER CONST CONSTRUCTION RAD RADIUS CONT CONTINUOUS REF REFERENCE CORR CORRIDOR REFR REFRIDGERATOR CPT CARPET; CARPETED REINF REINFORCED; REINFORCING CTR CENTER REQ REQUIRED CY CUBIC YARD RESIL RESILIENT REV REVISION; REVISED DEMO DEMOLITION RH ROWHOUSE DIA DIAMETER RO **ROUGH OPENING** DIM DIMENSION ROW RIGHT OF WAY DOOR

SOUTH

DRAIN

SECTION

SILL HEIGHT

SHEET METAL

SLAB ON GRADE

SPECIFICATION

STAINLESS STEEL

TONGUE AND GROOVE

UNLESS NOTED OTHERWISE

VINYL COMPOSITION TILE

TEMPERED GLASS

TOWNHOUSE

TOP OF BEAM

TOP OF CURB

TOP OF PLATE

TOP OF WALL

TREATED

TYPICAL

TUBE STEEL

VINYL BASE

VENEER

VERTICAL

VESTIBULE

WEST; WIDTH

WHOLE HOUSE FAN

WEATHER RESISTIVE

WALK IN CLOSET

VERIFY

WITH

WOOD

WITHOUT

BARRIER

WEIGHT

SHEATHING

SIMILAR

SQUARE

SETBACK

STORAGE

THREAD

TOP OF ...

STRUCTURAL

SUSPENDED

SHEET

SMOKE DETECTOR; STORM

SINGLE FAMILY RESIDENCE

SQUARE FOOT/FEET

SQUARE INCH; INCHES

SD

SECT

SF

SFR

SH

SHT

SHTG

SI

SIM

SOG

SPEC

SQ

SST STBK

STRUCT

TOC

TOP

TOW

TRTD

TYP

UNO

VCT

VEN

VEST

VFY

WD

WHF WIC

SHT MTL

ELEVATION ELECTRICAL **ELEVATOR**; **ELEVATION** ENCLOSURE **EQUAL EQUIPMENT EXISTING** EXPANDED; EXPANSION **EXTERIOR**

FIRE DEPARTMENT FDC CONNECTION FDN FOUNDATION FIRE EXTINGUISHER FEC FIRE EXTINGUISHER CABINET FINISHED FLOOR FIRE HYDRANT, FULL HEIGHT FINISH FLOOR FLR **FLUOR FLUORESCENT** FACE OF ... FO FOB FACE OF BEAM FACE OF CONCRETE FOC FOF FACE OF FINISH/FOUNDATION FINISHED BY OWNER -INSTALLED BY CONTRACTOR

DOWNSPOUT

DISHWASHER

DETAIL

EAST

EACH

DRAWING

DTL

DW

DWG

ELEC

ELEV

ENCL

EQUIP

EXIST

EXP

EXT

EQ

FOS FACE OF STUDS FRMG FRAMING FOOT; FEET FTG FOOTING **FURR FURRING** FUT **FUTURE** GΑ GAUGE GALVANIZED GALV GENERAL CONTRACTOR

GLASS

GLAM GLUE-LAMINATED GWB GYPSUM WALL BOARD HC HANDICAPPED HDR HEADER HDWD HARDWOOD **HEAD HEIGHT HOLLOW METAL** HORIZ HORIZONTAL

HOUR HEIGHT HEATING/VENTILATING/AIR HVAC CONDITIONING HIGH VOLTAGE LINE **HOT WATER**

INSUL INSULATION INTERIOR INVERT

JOIST LAMINATE; LAMINATED LAVATORY

LINEAR FOOT; FEET MAS MASONRY

MAXIMUM

DRAWING INDEX - LPB

SHEET NUMBER SHEET NAME

1 - GENERAL

TS

A8.30

TITLE SHEET & PROJECT DATA CA-00 CA-01 EXISTING HOUSE

2 - SURVEY

SURVEY

5 - LANDMARKS PRESERVATION BOARD CA-02 LANDMARKS PRESERVATION CA-03 RENDERED EXTERIOR IMAGES

6 - ARCHITECTURAL

A1-00 SITE PLAN A2.00 EXISTING PLANS A2.02 FLOOR PLAN A2.03 **ROOF PLAN** A3.00 EXISTING BUILDING ELEVATIONS A3.01 **BUILDING ELEVATIONS** A3.02 EXISTING BUILDING ELEVATIONS A3.03 BUILDING ELEVATIONS

DETAILS - FRAMING +WINDOWS

PROJECT DATA

PROJECT ADDRESS: 812 23RD AVE, SEATTLE, WA 98122 JURISDICTION: CITY OF SEATTLE

SDCI PROJECT NUMBER: 6868236-CN

AN ADDITION (668 SF) TO AN EXISTING SINGLE DESCRIPTION OF WORK: FAMILY RESIDENCE WITH SURFACE PARKING VIA ACCESS EASEMENT.

PROPOSED USE: CITY OF SEATTLE PARCEL NUMBER: 9126102040

WALLA WALLA ADD PLat Block: 21 LEGAL DESCRIPTION: Plat Lot: 6

LOT AREA (SF): 3575.00 SF ZONE: RSL (M)

URBAN VILLAGE: 23RD & UNION-JACKSON YES // ORDINANCE #108732

HISTORIC LANDMARK: CERT. OF APPROVAL REQUIRED (UNDER SEPARATE SUBMITTAL) NO

ECA: CONSTRUCTION TYPE: PER SMC TABLE 601 / VB SECTION 602

PROJECT TEAM

OWNER: **GREG SQUIRES** 812 23RD AVE SEATTLE, WA 98122 (206)693-3133 SQUIRES@CONE-ARCH.COM

APPLICANT: CONE ARCHITECTURE 2226 3RD AVE, SUITE 100 SEATTLE, WA 98121 (206) 693 - 3133 CONTACT: GREG SQUIRES

ARCHITECTURE

1319 N 49TH ST, SEATTLE, WA 98103 TEL. (206) 693-3133

SDCI Approval Stamp


DESCRIPTION MARK

BUILDING PERMIT INTAKE 09/07/2022

DATE



VIEW FROM 23RD AVE. IMAGE FOR ILLUSTRATIVE PURPOSES ONLY.

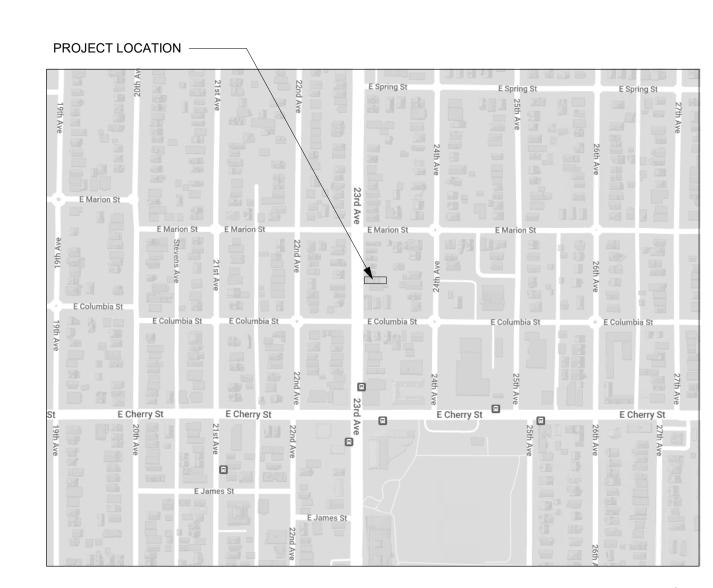

VICINITY PLAN SCALE: NTS



812 23RD AVE **ADDITION**

TITLE SHEET & PROJECT DATA

SDCI Project Numbers	6868236-CN
Issue Date	09/07/2022
Drawn by	MC
Checked by	GS

CA-00

CONE Project Number

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MAX



PROPOSAL FOR NEW SFR // 2007

SUBMITTED AS THE "MARION RESIDENCE" IN 2007 THE A NEW HOME BY PB ELEMENTAL PROPOSED A REINTERPRETATION OF THE ORIGINAL HISTORIC FORM IN A CONTEMPORARY MANNER. THE MASSING STRATEGY FOR THE NEW STRUCTURE WAS TO EMULATE THE SCALE AND SETBACKS OF THE NORTHERN NEIGHBORS AND MIMIC THE FAMILIAR GLAZING STRATEGY SEEN ON THE FRONT FAÇADES OF ALL THE ROWHOUSES. THERE WERE TWO EXTERIOR MATERIALS PROPOSED IN THE APPLICATION - CEDAR SIDING AND FIBER CEMENT PANELS.

THE DOMINANT EXTERIOR MATERIAL ON THE STREET FAÇADE IS 4" CEDAR BOARDS STAINED IN A NATURAL TONE WHICH PAIRS WITH THE NARROW WOOD SIDING ON THE EXISTING ROWHOUSE GROUP BUT WITH A MODERN THE APPLICATION OF AN OPEN-JOINT RAINSCREEN. THE SMOOTH FIBER CEMENT PANELS WERE ALSO APPLIED IN AN OPEN-JOINT RAINSCREEN FASHION AND ARRANGED IN A 2' STACKED PATTERN. THE PANEL BREAK LINES ARE ALIGNED WITH BLACK FRAMED WINDOWS. THE FRONT AWNING WAS A SIMPLE STEEL C-CHANNEL SUPPORTED WITH A TIE BACK ROD. THE UPPER ATTACHMENT PLATE FOR THE TIE ROD WAS HELD HIGH ON THE CEDAR FAÇADE TO CREATE AN EXAGGERATED SLOPE WHICH MATCHES THE STEEP PITCHED ROOFS ON THE EXISTING ROWHOUSES.

APPROVED MATERIALS FROM **2007 CERTIFICATE OF APPROVAL**

THE LANDMARKS PRESERVATION BOARD ISSUED AN APPROVAL LETTER (DATED 9/24/2007) FOR THE CONSTRUCTION OF THE NEW RESIDENCE. THE CERTIFICATE OF APPROVAL STATED THAT THE PROPOSED NEW RESIDENCE DID NOT ADVERSELY AFFECT THE FEATURES OR CHARACTERISTICS SPECIFIED IN ORDINANCE #108732 AND THAT THE PROPOSED NEW CONSTRUCTION WOULD NOT DESTROY HISTORIC MATERIALS THAT CHARACTERIZE THE PROPERTY. THE CERTIFICATE OF APPROVAL ALSO CONFIRMED THAT THE PROPOSED DESIGN WAS COMPATIBLE WITH THE MASSING, SIZE, SCALE AND ARCHITECTURAL FEATURES OF THE 23RD AVE HOUSES


EXISTING EXTERIOR SPECIFICATIONS

• 5/16" Smooth Architectural Panel, 2' wide

Williams Woodscapes - Cedarbark

 Open-Joint Rainscreen Finished with Exterior Acrylic Latex Paint: Sherwin Williams Super Paint - True White

- CEDAR SIDING SPECIFICATION
 1x4 S4S Clear Cedar
 Open-Joint Rainscreen
- Attached with Exposed Stainless Ringshank NailFinished with Semi-Transparent Stain: Sherwin

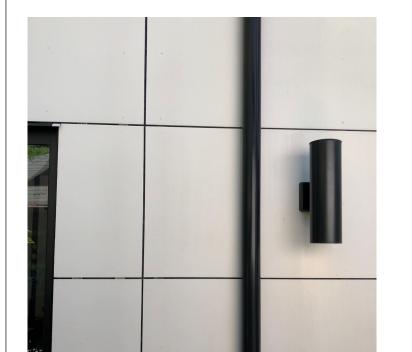

SMOOTH FIBER CEMENT PANEL




FRONT DOOR SIDING DETAIL




CEDAR RAINSCREEN



23RD AVE - STREET FACING FACADE

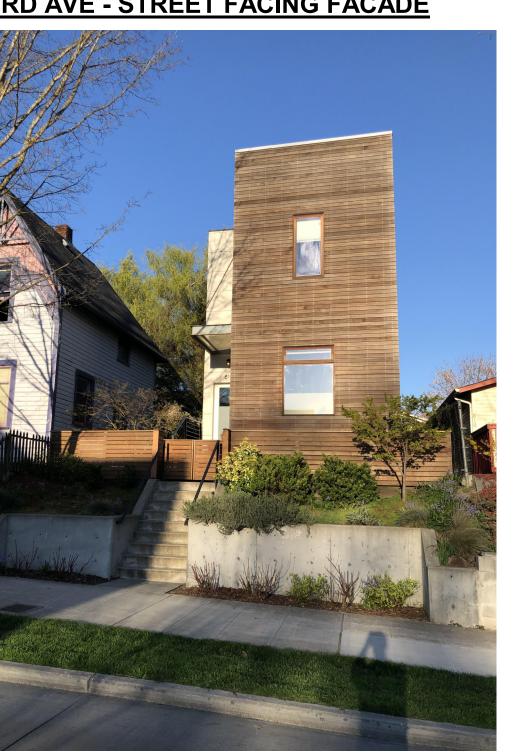

FRONT ENTRY DOOR AND STEPS

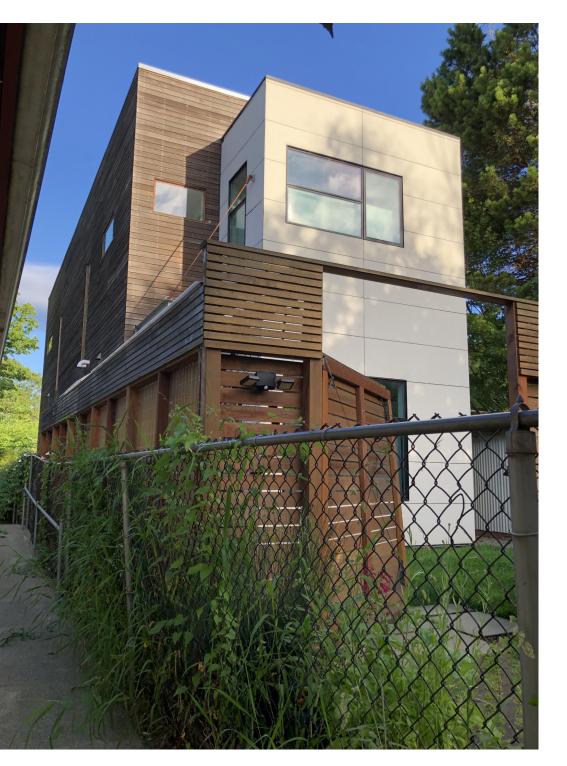

2009 / CONSTRUCTED

SOUTH FACADE - VIEW FROM SE CORNER



WEST FACADE - REAR ENTRY

BRIEF SITE HISTORY

IN 1978 THE SEATTLE HISTORIC PRESERVATION OFFICE CONDUCTED A CITY-WIDE SURVEY TO DOCUMENT STRUCTURES OF SIGNIFICANCE. THE SURVEY LISTED A ROW OF SIX CONTIGUOUS RESIDENCES ON 23RD AVE KNOWN AS THE "23RD AVENUE ROWHOUSE GROUP". ORIGINALLY BUILT IN 1893 THE GROUP OF HOMES WAS IDENTIFIED AS THE LAST INTACT EXAMPLE INSIDE THE CITY OF WORKING-CLASS HOUSING BUILT IN THE VICTORIAN VERNACULAR. IN 1979 ORDINANCE #108732 RESIDENCES ADDRESSED AT 812 - 828 23RD AVE. THE ORDINANCE IMPOSED CONTROLS WHICH STATED THAT PHOTOGRAPHIC RECORDS, THE ORIGINAL "ROWHOUSE" STRUCTURE LOCATED AT 812 23RD AVE WAS DEMOLISHED. THE REMOVAL OF THE HOME APPEARS TO HAVE OCCURRED WITHOUT PROPER APPROVAL AND THE LOT SAT VACANT FOR 30+ YEARS.

SDCI Approval Stamp

DESCRIPTION BUILDING PERMIT INTAKE




812 23RD AVE **ADDITION**

EXISTING HOUSE

6868236-CN
09/07/2022
MC
GS

CA-01

CONE Project Number

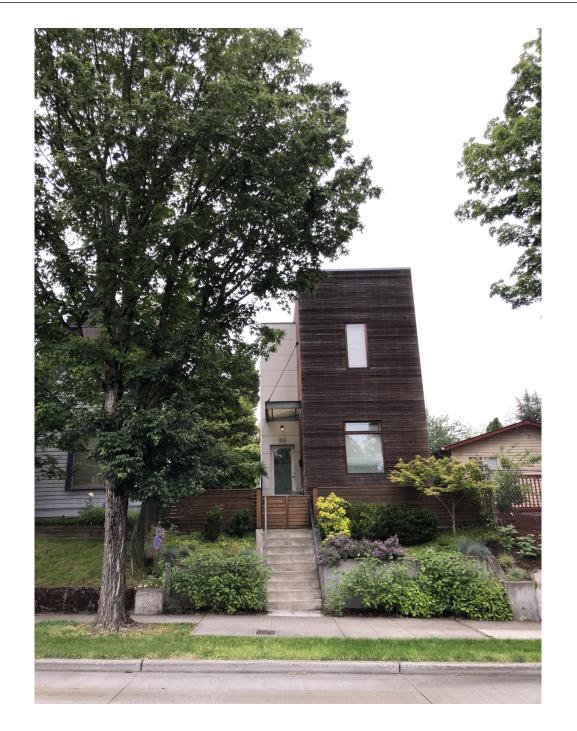

EXISTING SFR - STREET FRONT

SCALE: NTS




PROPOSED ADDITION - STREET FRONT



SCALE: NTS

EXISTING STREETSCAPE - "23RD AVE ROWHOUSE GROUP"

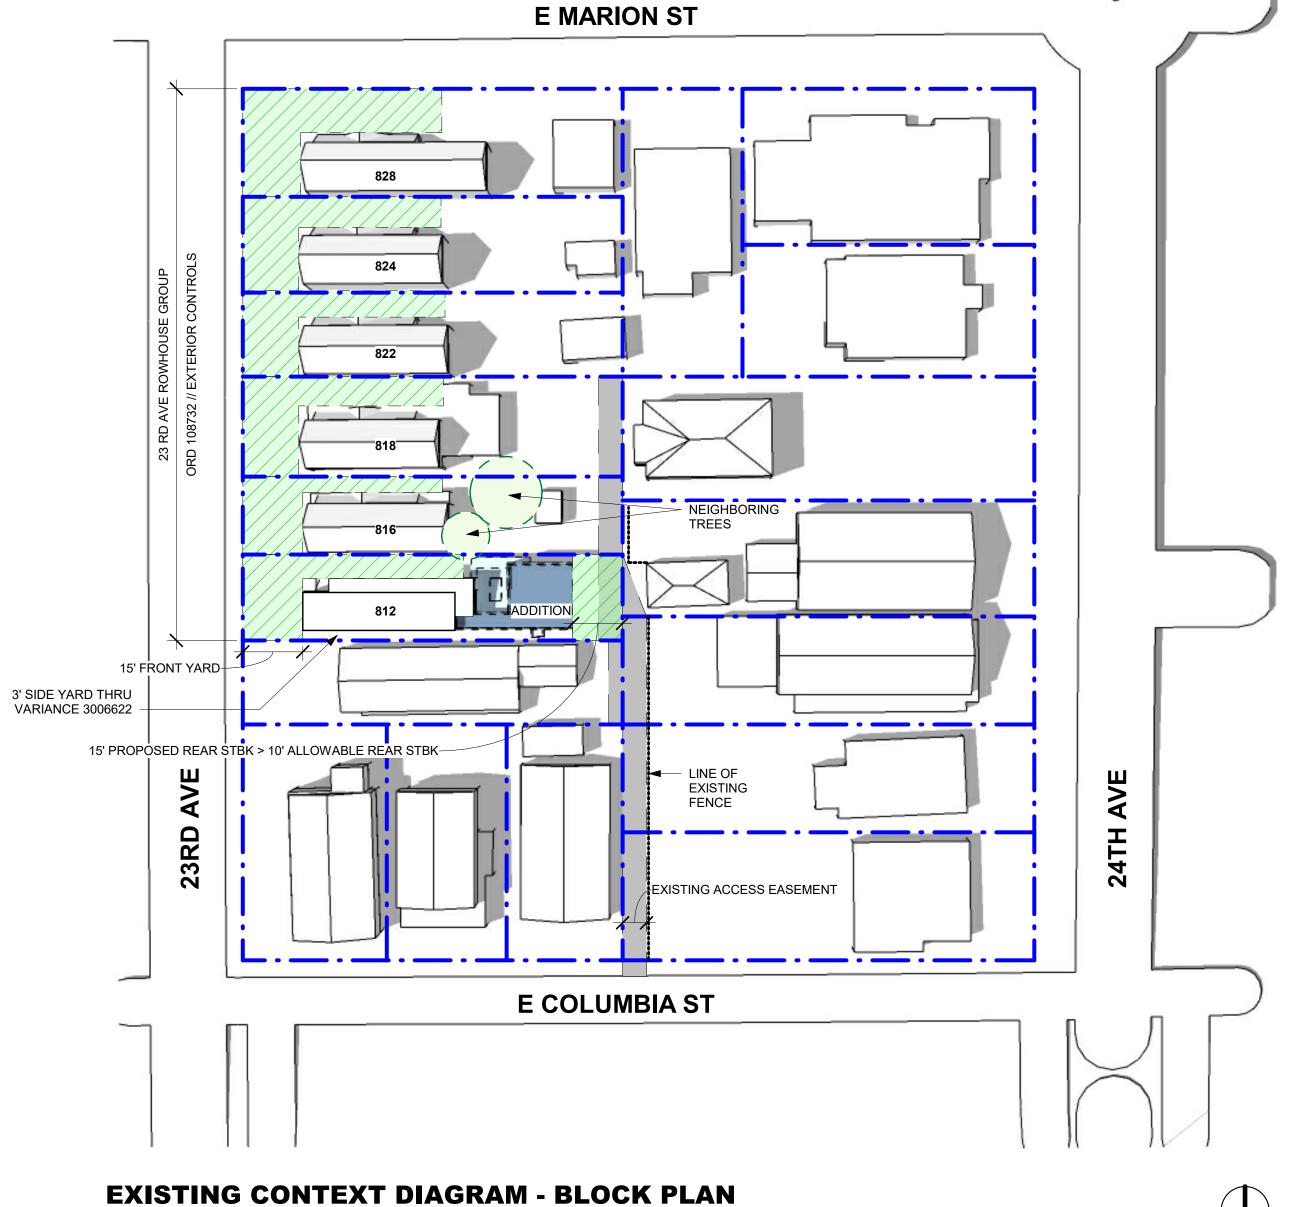

SDCI Approval Stamp


DESCRIPTION

BUILDING PERMIT INTAKE

PROPOSED PROJECT

SFR Addition Summary // 2022

THE PROJECT PROPOSES A REAR ADDITION TO THE EXISTING HOME WITH A SMALL EXPANSION ON THE FIRST FLOOR AND A LARGER EXPANSION ON THE SECOND FLOOR THAT EXTENDS OVER THE REAR SURFACE PARKING. THE ADDITION IS COMPLIANT WITH THE UNDERLYING ZONING – RESIDENTIAL SMALL LOT – AND EXTENDS FROM PORTIONS OF THE EXISTING EAST FAÇADE. THE HEIGHT OF THE REAR ADDITION IS ALIGNED WITH THE LOWER PARAPET OF THE EXISTING HOUSE AND IS APPROXIMATELY 7' BELOW THE ALLOWABLE HEIGHT LIMIT. ALL EXTERIOR SIDING MATERIALS ON THE PROPOSED ADDITION ARE TO MATCH THE EXTERIOR MATERIALS THAT WERE PREVIOUSLY APPROVED BY THE LANDMARKS PRESERVATION BOARD

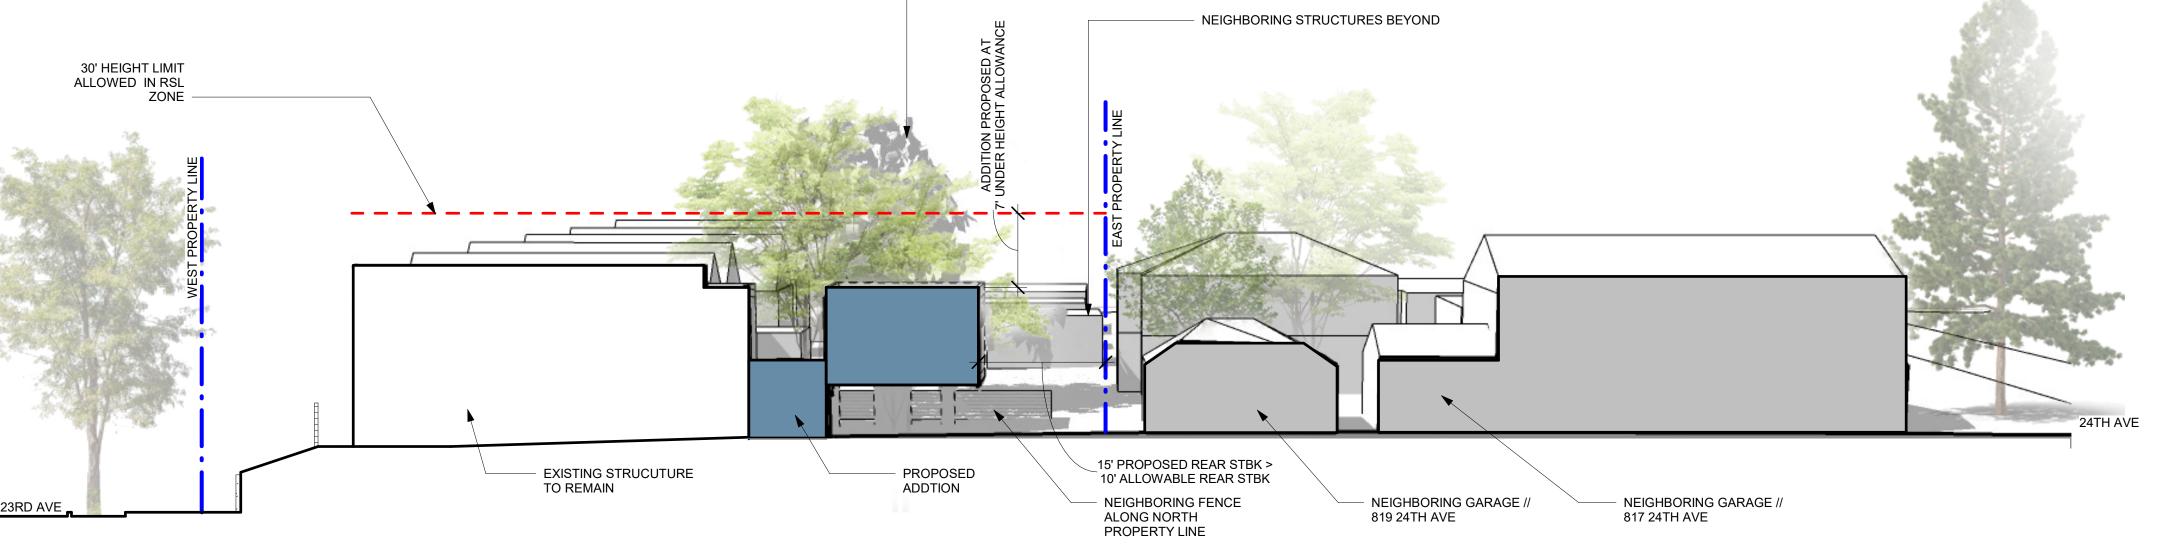

NEIGHBORING TREES

EXISTING CONTEXT DIAGRAM - BLOCK SECTION

SCALE: NTS




SDCI Project Numbers	6868236-CN
Issue Date	09/07/2022
Drawn by	MC
Checked by	GS

ADDITION

CA-02

CONE Project Number

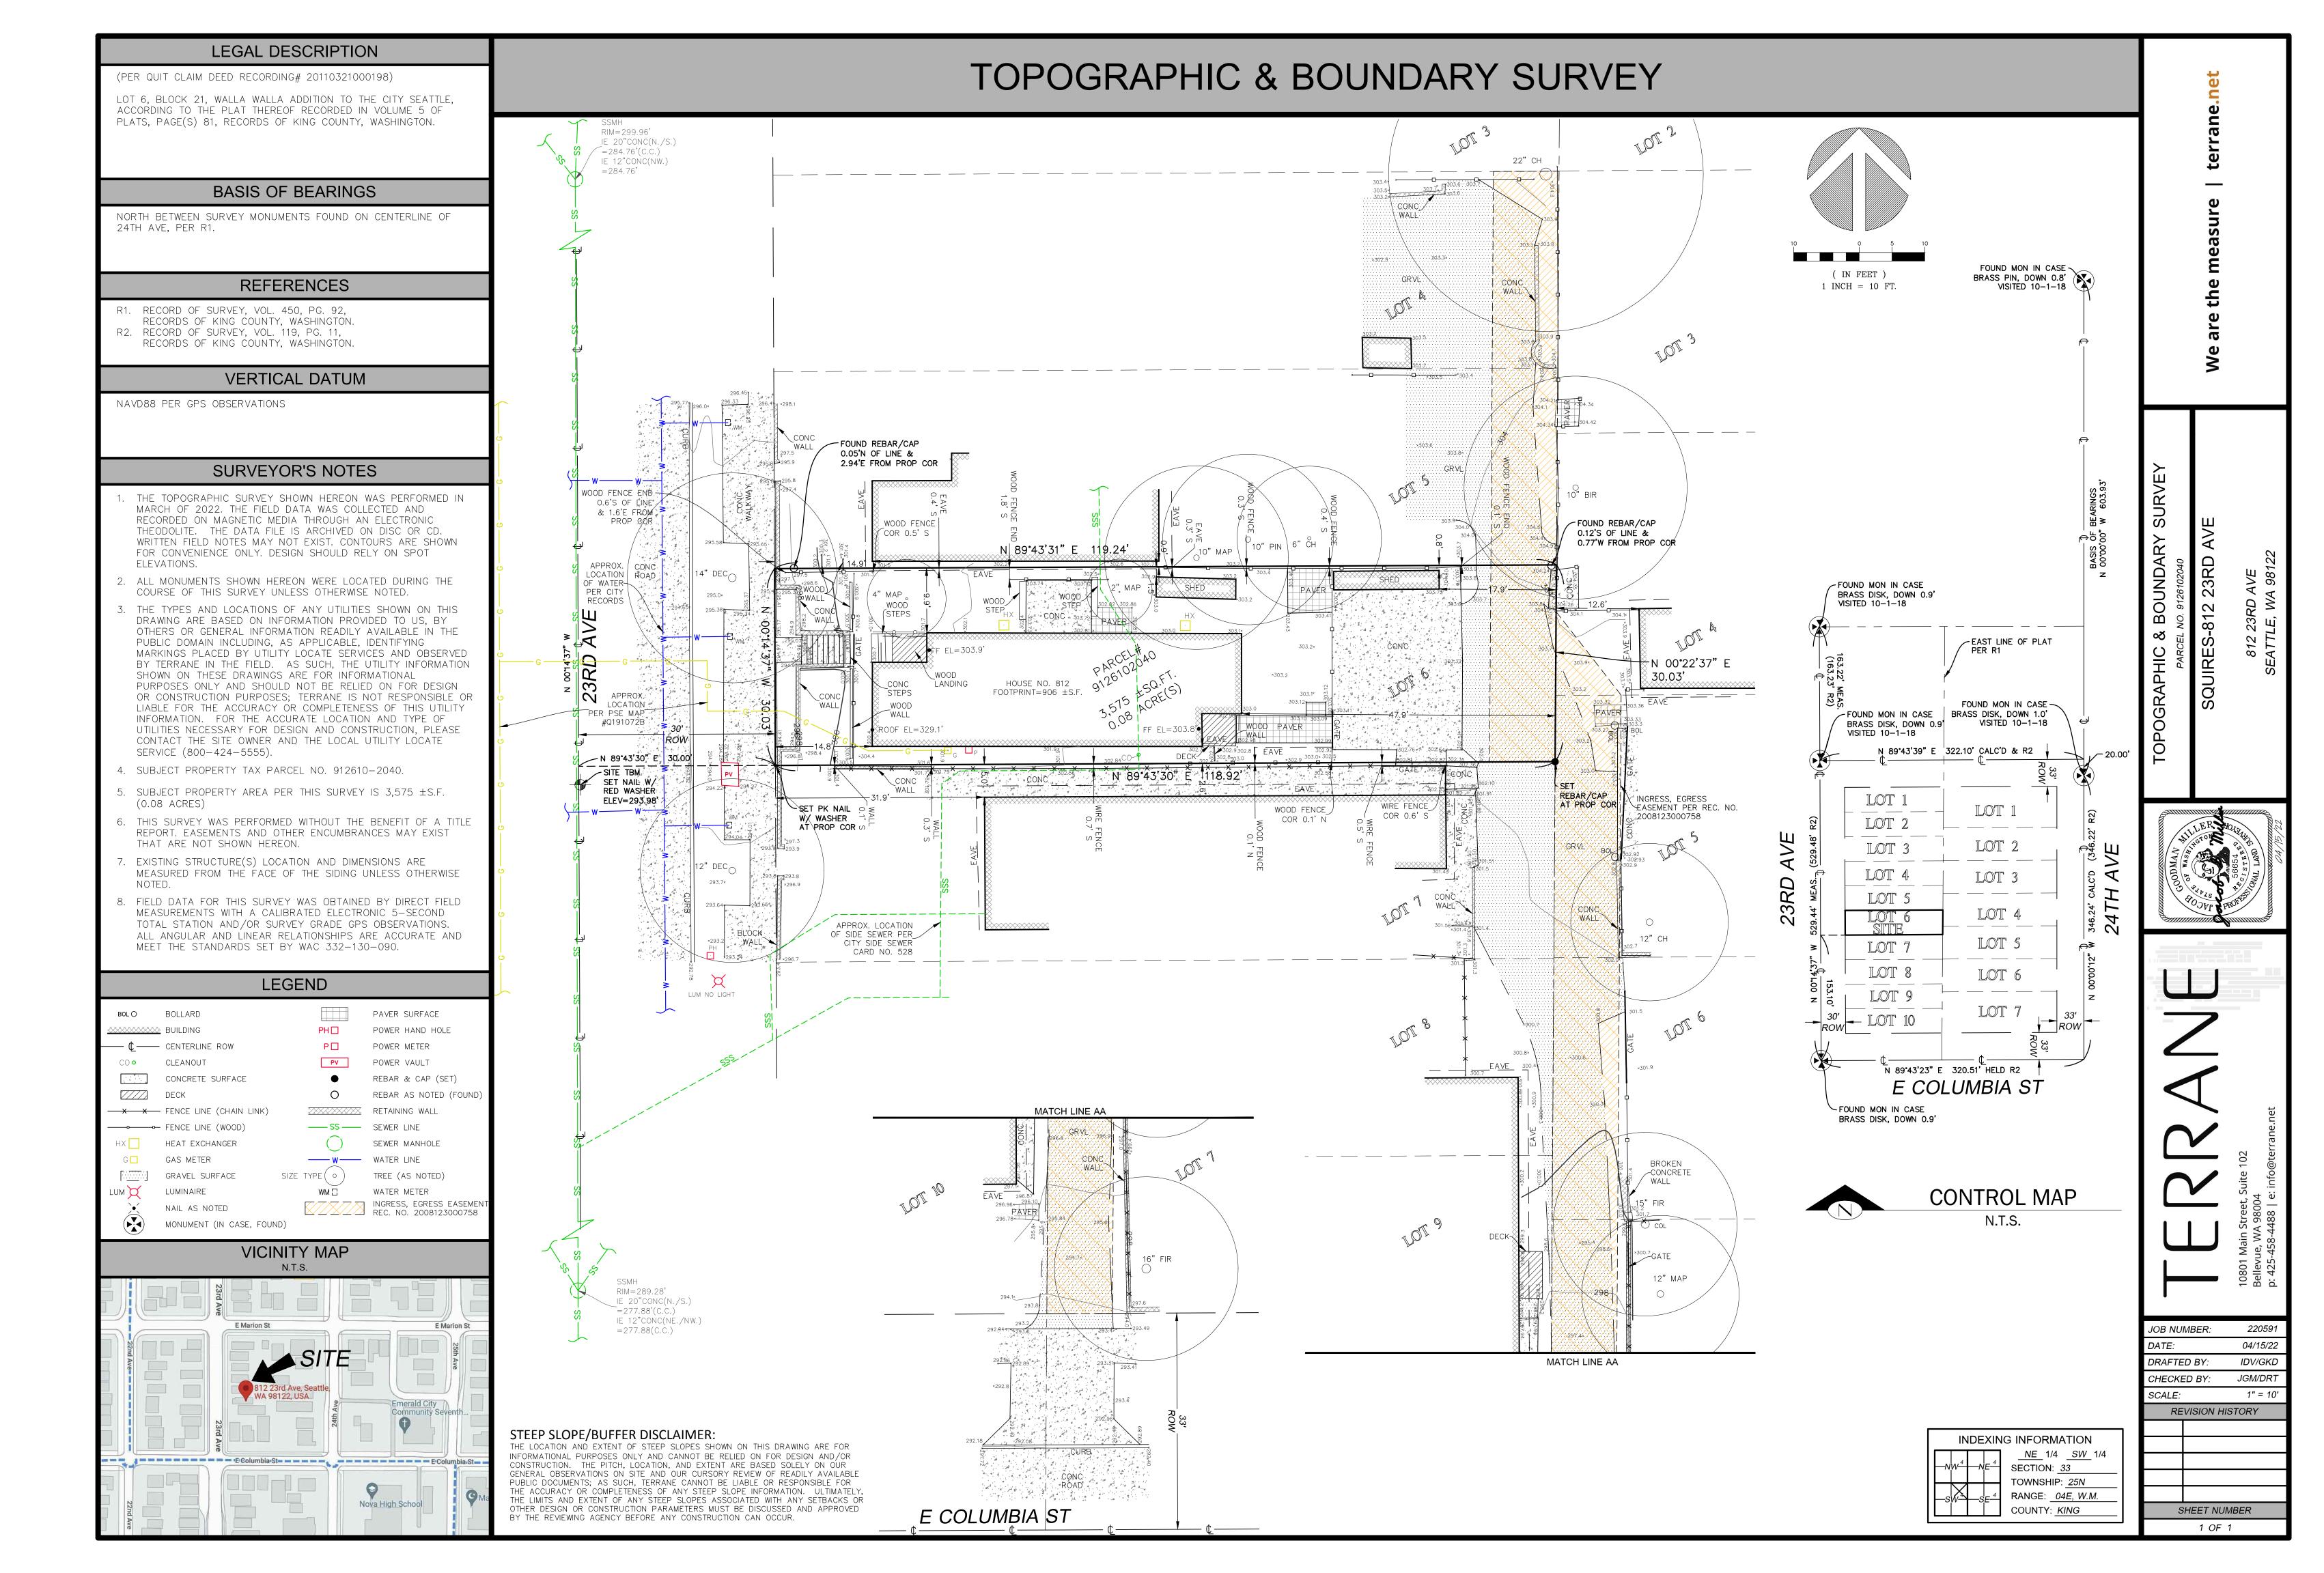



1 SW CORNER

2 SE CORNER

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SDCI Approval Stamp

MARK	DESCRIPTION	DATE	
	BLUI DING DEDMIT INTAKE	00/07/2022	



812 23RD AVE ADDITION


RENDERED EXTERIOR IMAGES

SDCI Project Numbers	6868236-CN
Issue Date	09/07/2022
Drawn by	MC
Checked by	GS

CA-03

CONE Project Number 2200

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2 SITE PLAN - EXISTING LANDSCAPE SCALE: 1" = 10'-0"

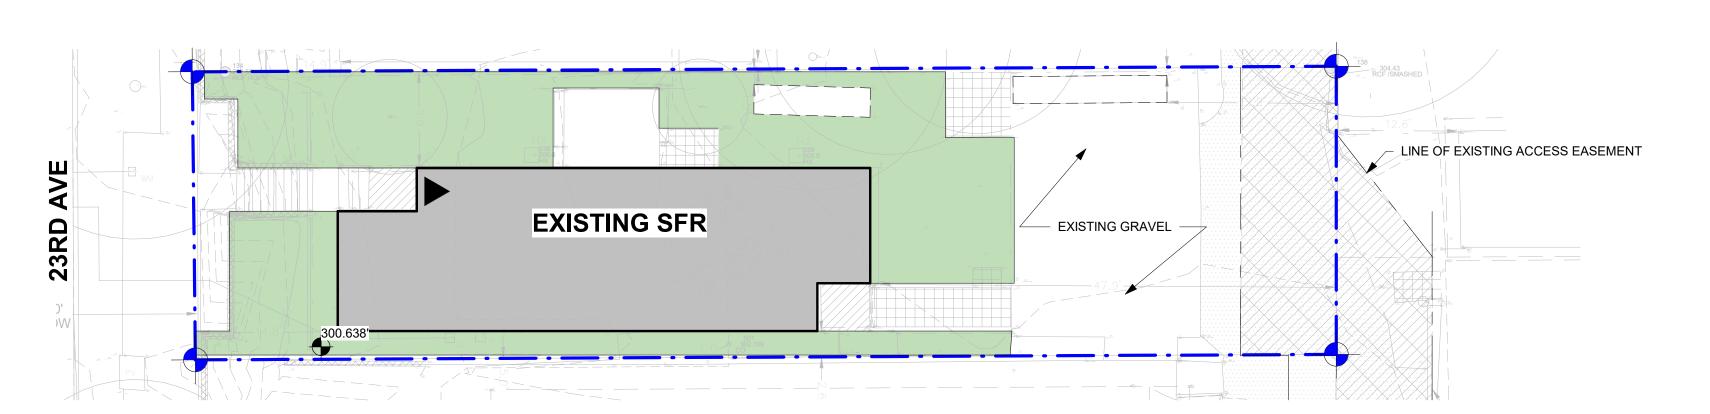
EXISTING WOOD FENCE TO

REMAIN

15' - 1 7/8"

EXISTING FRONT STBK

300.638'

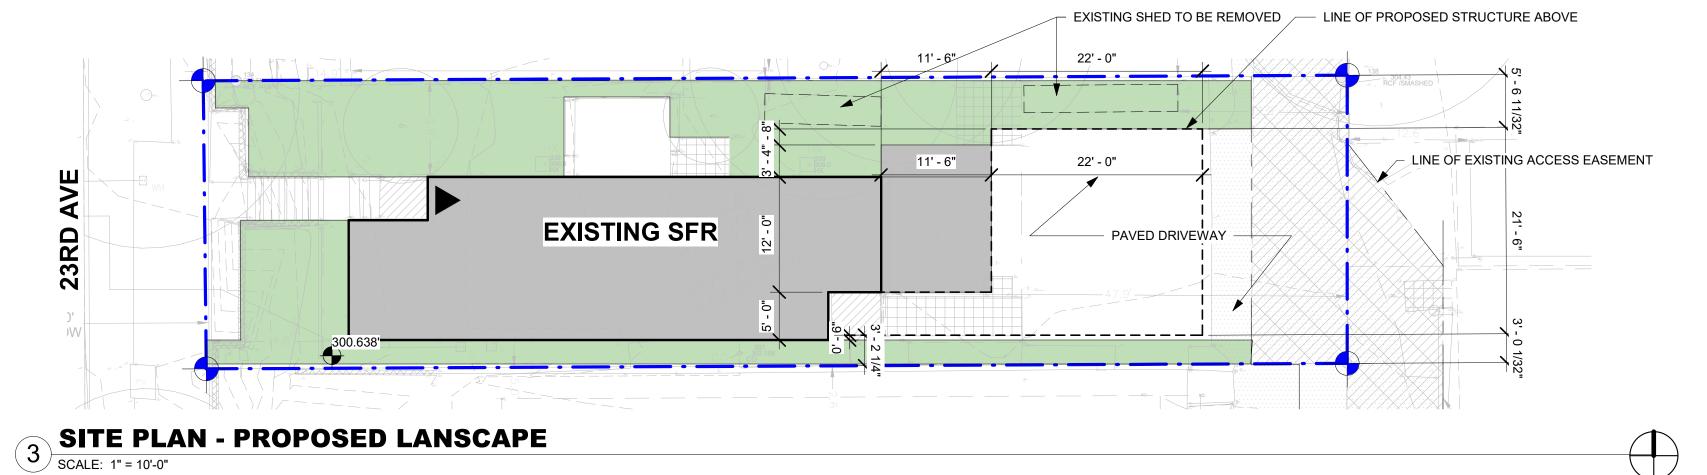

LINE FO AWNING ABOVE, TYP

PRIMARY ENTRY

SITE PLAN NOTES

- 1. PER SMC 23.45.534 ALL LIGHTING TO BE SHIELDED AND DIRECTED
- AWAY FROM ADJACENT BUILDINGS. 2. PROTECT ALL TREES TO REMAIN PER LANDSCAPE PLANS. ANY NECESSARY PRUNING TO BE DONE IN CONSULTATION WITH CERTIFIED ARBORIST.
- 3. ALL GRADING TO CONFORM TO SEATTLE GRADING CODE SMC 22.170. 4. ANY PERMANENT WORK COMPLETED IN THE ROW MUST BE DONE TO SDOT STANDARDS CONSISTEN WITH THE RIGHT-OF-WAY IMPROVEMENTS MANUAL

GRADING NOTES

- 1. NO SEDIMENT SHALL BE TRACKED INTO THE STREET OR ONTO PAVED SURFACES. SEDIMENT SHALL BE REMOVED FROM TRUCKS AND EQUIPMENT PRIOR TO LEAVING THE SITE. IN THE EVENT THERE IS A FAILURE OF AN EROSION CONTROL SYSTEM RESULTING IN SEDIMENT BEING TRACKED ONTO PAVED SURFACES, THE CONTRACTOR SHALL IMMEDIATELY IMPLEMENT MEASURES TO CORRECT THE SITUATION, AND STREET SWEEPING SHALL BE EMPLOYED ON AN EMERGENCY BASIS. IF STREET SWEEPING VEHICLES ARE UTILIZED, THEY SHALL BE OF THE TYPE THAT ACTUALLY REMOVES SEDIMENT FROM THE PAVEMENT.
- SEATTLE DCI REQUIRES A PRE-CONSTRUCTION MEETING BETWEEN OWNERS REPRESENTATIVES, THE GENERAL CONTRACTOR, EXCAVATOR, AND DPD SITE INSPECTOR
- 3. TEMPORARY ENCROACHMENT ACROSS PROPERTY LINES DUE TO EXCAVATION IS NOT ALLOWED WITHOUT WRITTEN PERMISSION GRANTED BY OWNERS OF NEIGHBORING PROPERTIES AND SUBMITTED TO SEATTLE DCI.

LANDSCAPING NOTES

- EXISTING SHED TO BE REMOVED

- 1. EXISTING LANDSCAPE LOCATED ON THE FRONT YARD TO REMAIN 2. ALL EXISTING TREES LOCATED ON SITE TO REMAIN
- 3. GREEN HATCH REPRESENTS LANDSCAPED AREAS AT THE GROUND

REAR STBK

RSL REQ STBK

25' - 6 1/2'

PROJECT DATA

812 23RD AVE SEATTLE, WA 98122

DPD PROJECT #: 6868236-CN ZONE: RSL **OVERLAY ZONING:** N/A LOT SIZE: 3574SF

USE TYPE: SINGLE FAMILY RESIDENTIAL (R-3)

PROJECT DESCRIPTION: REAR ADDITION TO EXISTING SFR


LEGAL DESCRIPTION: WALLA WALLA ADD PLat Block: 21 Plat Lot: 6

TAX ID NUMBER: 912610-2040

1319 N 49TH ST, SEATTLE, WA 98103 TEL. (206) 693-3133

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DESCRIPTION DATE BUILDING PERMIT INTAKE

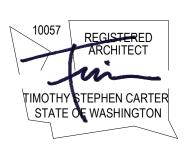

812 23RD AVE **ADDITION**

SITE PLAN

SDCI Project Numbers	6868236-CN
Issue Date	09/07/2022
Drawn by	MC
Checked by	GS

A1-00

SITE PLAN SCALE: 3/16" = 1'-0"

23RD

22' - 0"

SECONDARY

ENTRY

LOT DEPTH ADDITION: 33' - 6"/

PER PROVIDED ARBORIST REPORT, NO

OFFSITE TREES ARE EXCEPTIONAL

119' - 2 7/8"

339 306.0 HX

ALL EXISTING TREES TO REMAIN

EXISTING SFR 55' - 6"

HX

338 306.8 HX

EXISTING SFR: 50' - 0'

FIRST FLOOR ADDITION **EXISTING SFR**

ADDITION: 39' - 0"

118' - 11 1/32"

EXTEND EXISTING
NON-CONFORMING
(3'-0") FOR SOUTH
SIDE ADDITION PER
SMC 23.44.014.C.4.a

15' - 1"

22' - 0"

SECOND FLOOR

ADDITION

REAR STBK

ACCESS EASEMENT TO 🏅

E. COLUMBIA ST.

304.43 RCF /SMASHED

- LINE OF EXISTING ACCESS EASEMENT

HATCH REPRESENTS VEHICULAR EASEMENT


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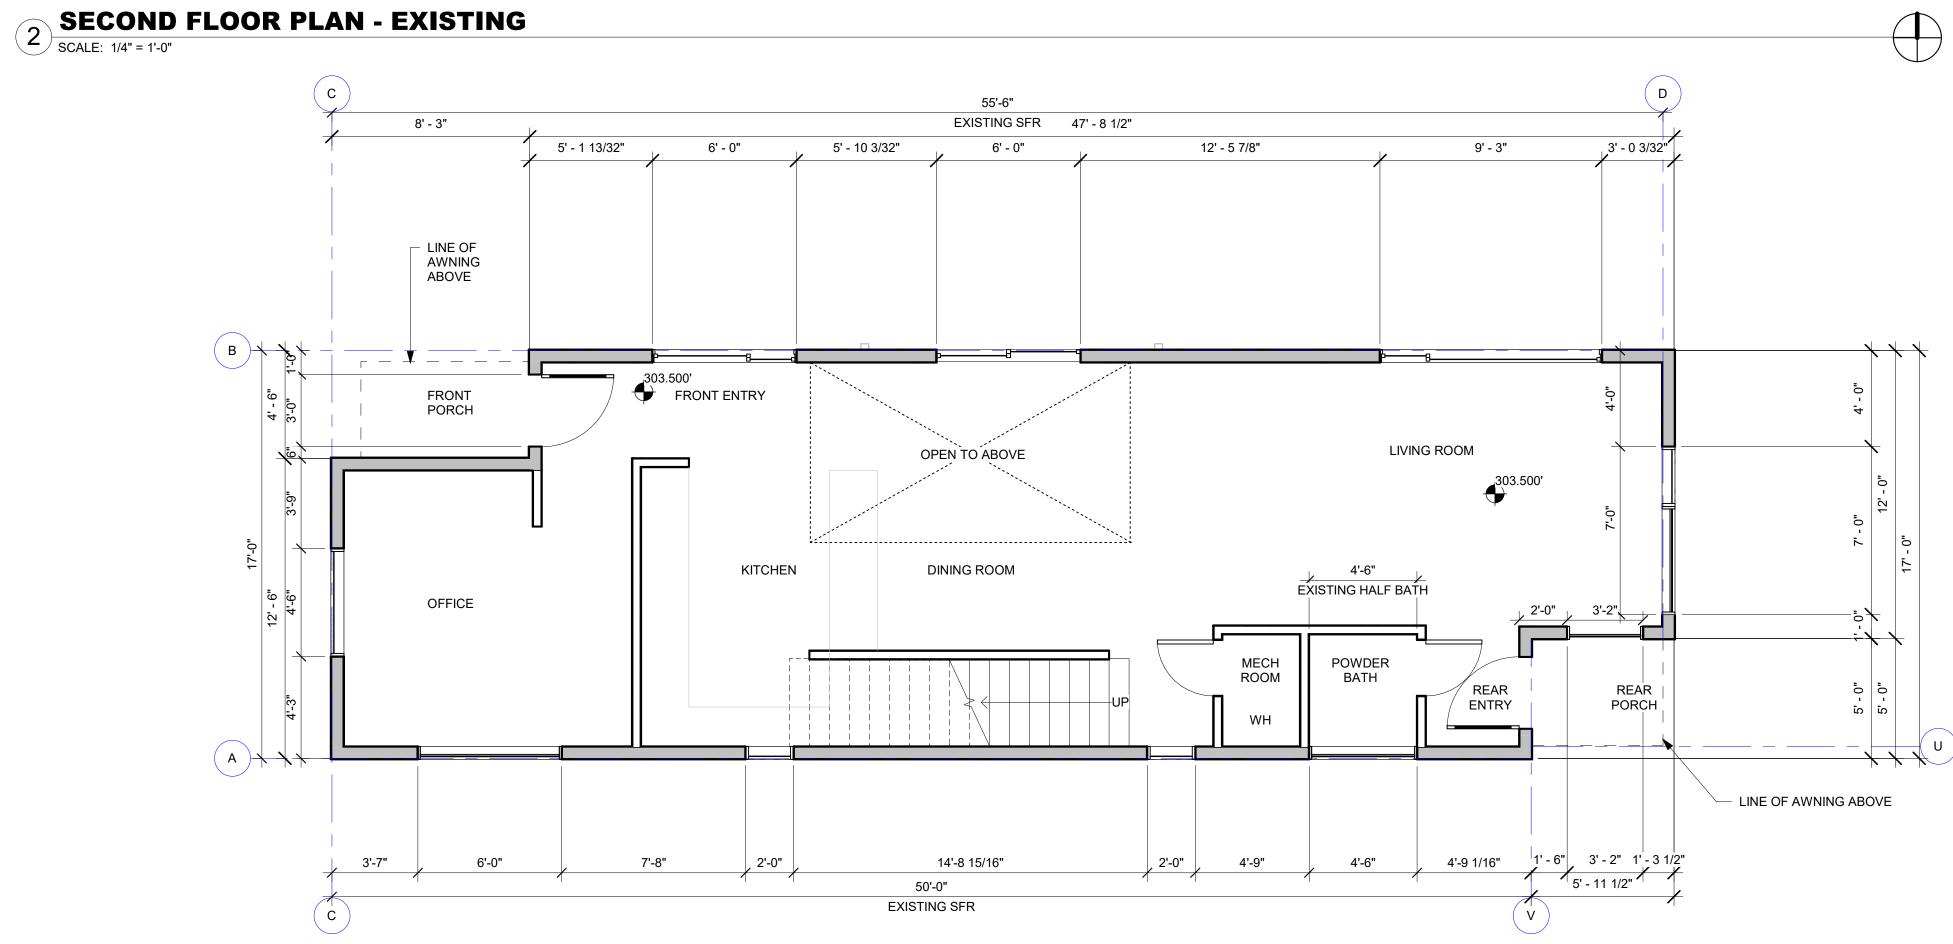
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CONE Project Number





FIRST FLOOR PLAN - EXISTING

SCALE: 1/4" = 1'-0"

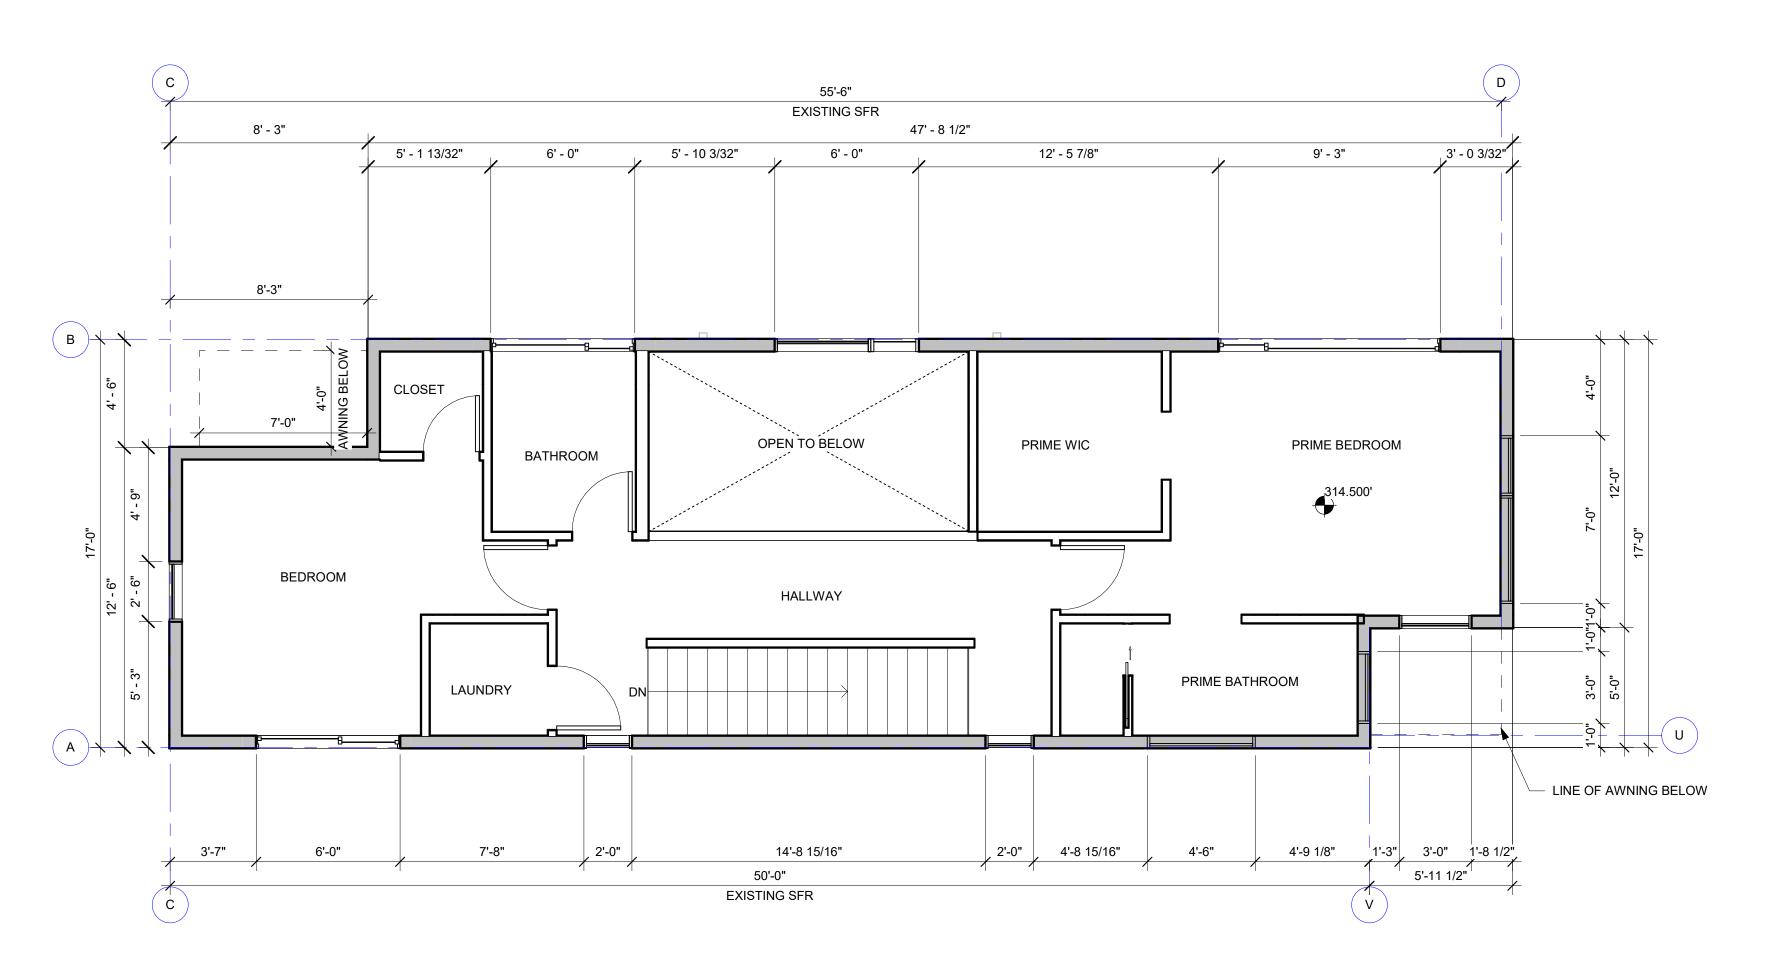EXISTING BUILDING AREA

EXISTING SFR
FIRST FLOOR
SECOND FLOOR

890 SF 768 SF 1658 SF

EXISTING SFR NOTES

- CALCULATIONS ARE FOR MARKETABLE SQUAREFOOTAGES AND DO NOT REFLECT GROSS FLOOR AREA AS DEFINED BY SMC 23.84A.014
- SEE G0.02 FOR FAR AND NET UNIT SIZE CALCULATIONS
 EXISTING SFR CONSTRUCTED IN 2009 UNDER
- CONSTRUCTION NUMBER #6102279-CN AND VARIANCE UNDER MUP# 3006622-LU

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SDCI Approval Stamp

RK	DESCRIPTION	DATE
	BUILDING PERMIT INTAKE	09/07/2022




812 23RD AVE ADDITION

EXISTING PLANS

SDCI Project Numbers	6868236-CN
Issue Date	09/07/2022
Drawn by	Author
Checked by	Checker

A2.00

CONE Project Number 220

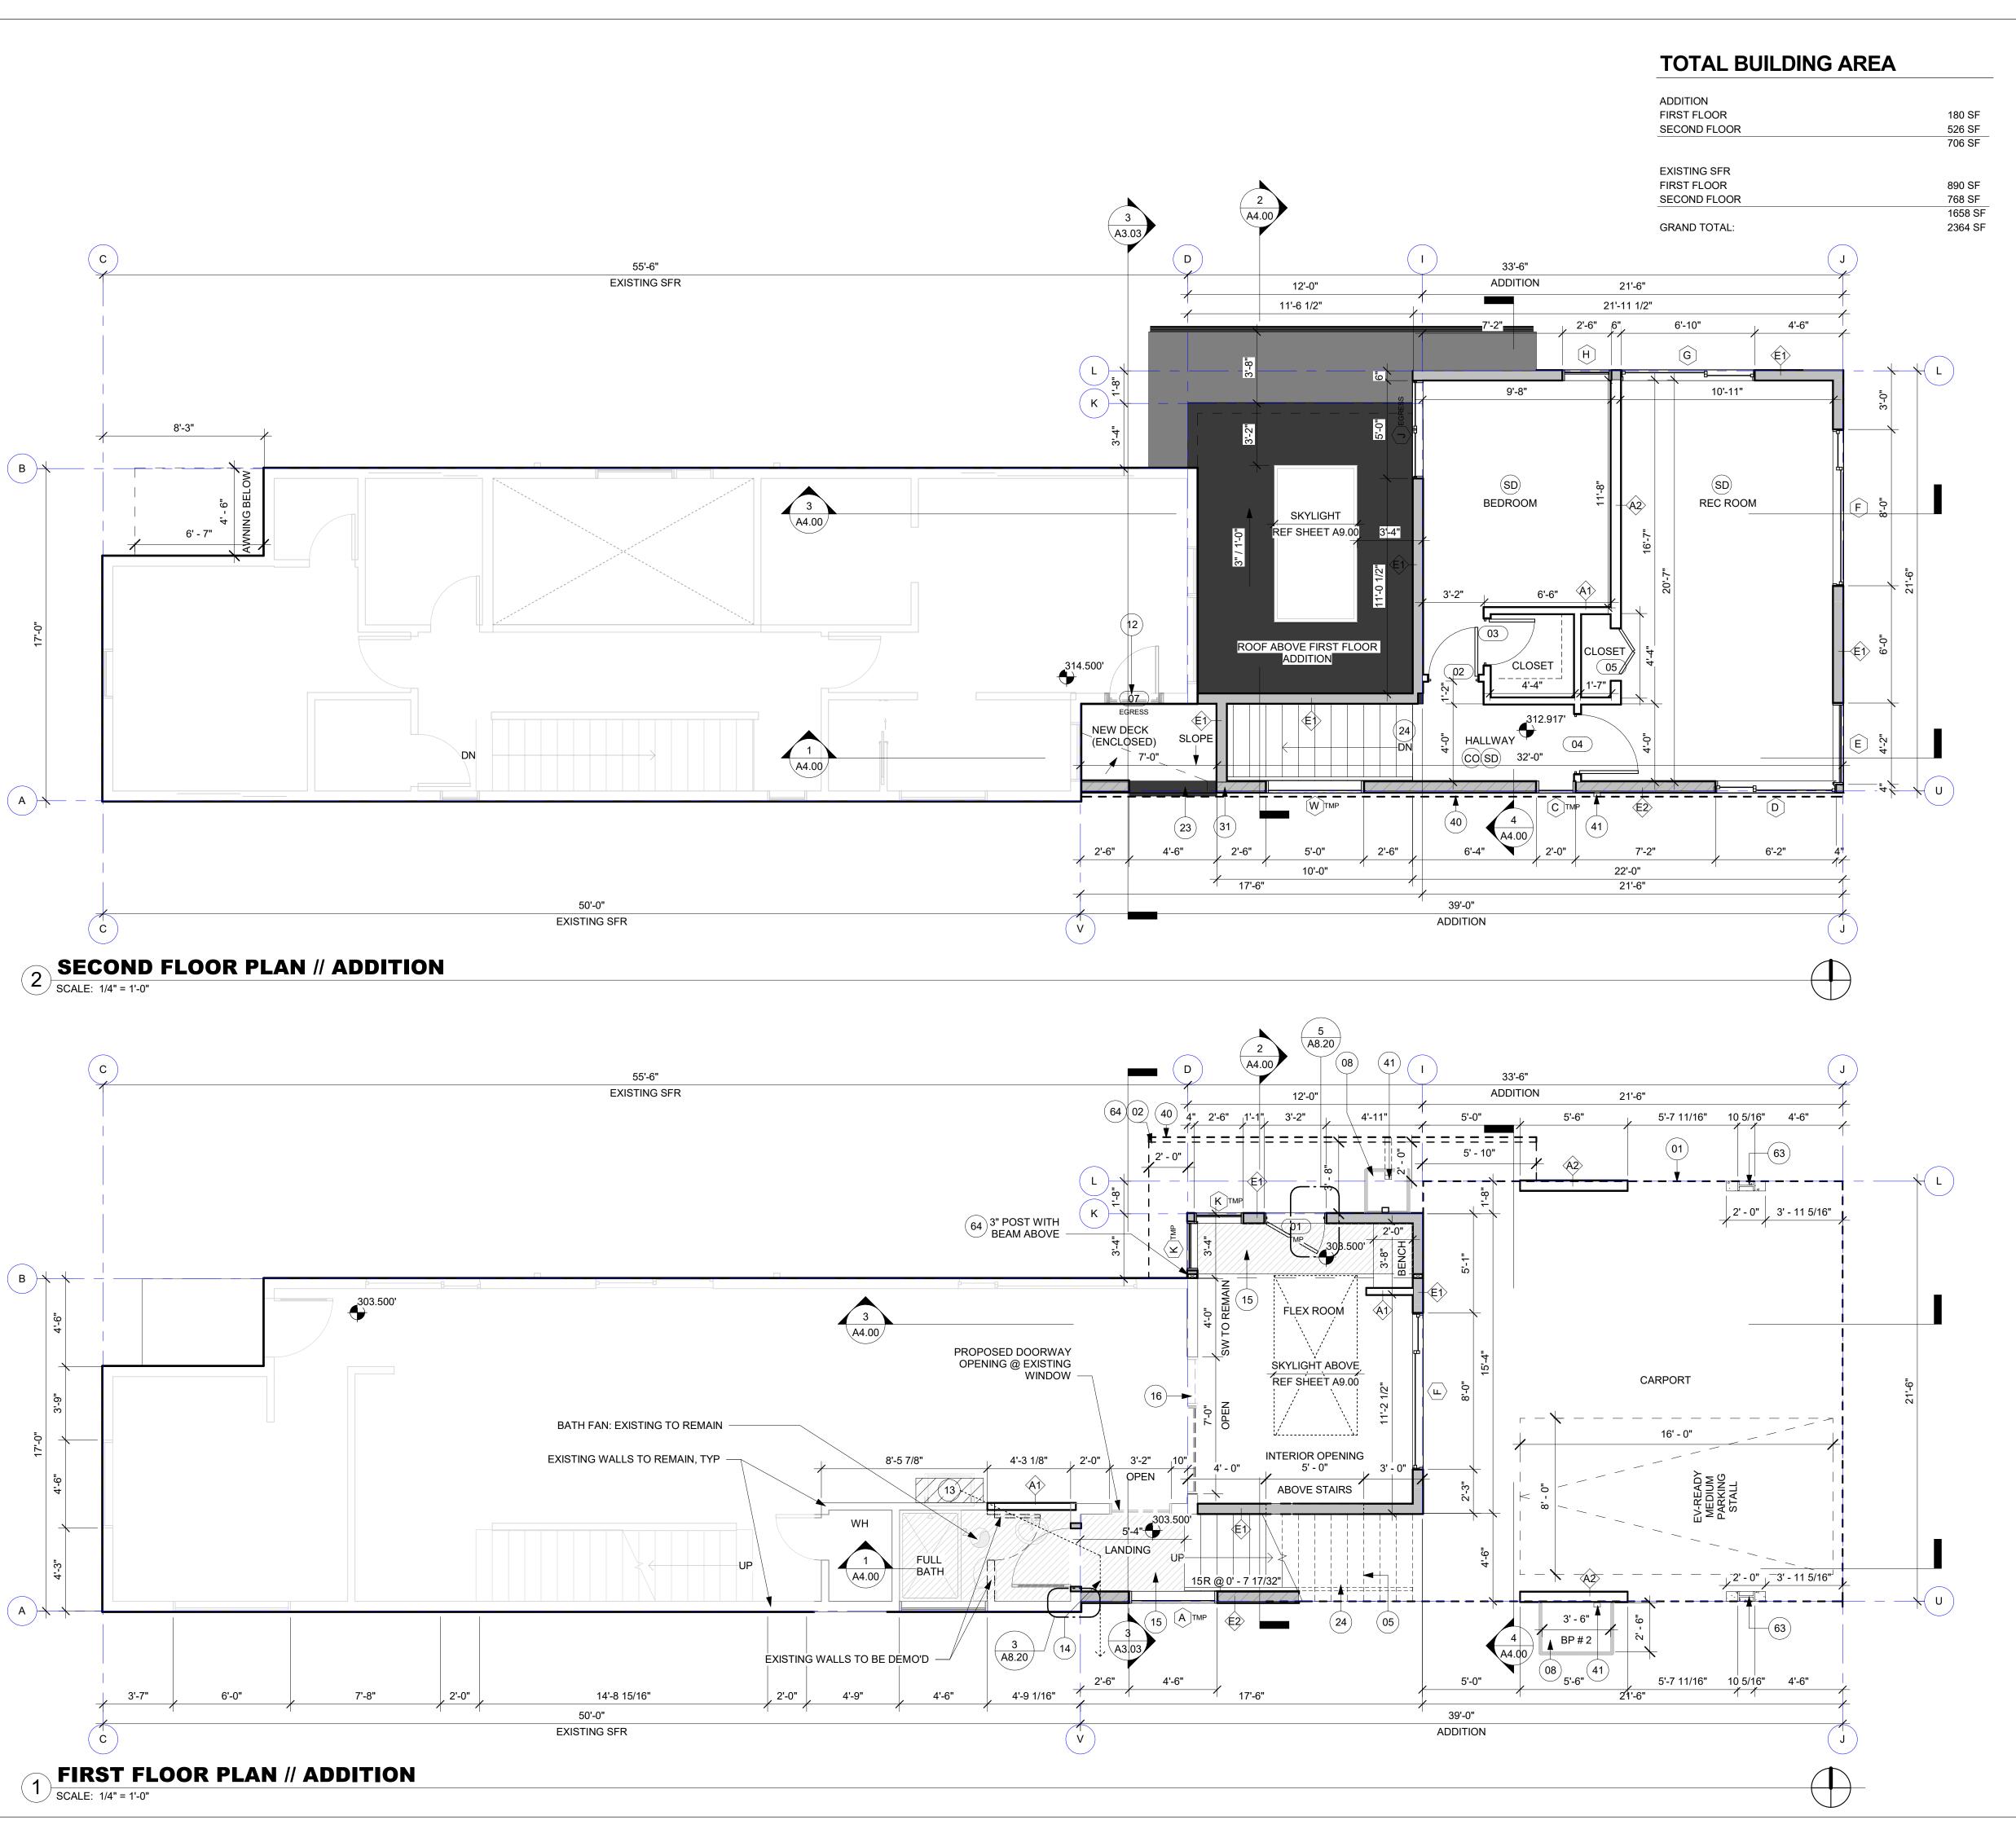

TYPICAL FLOOR PLAN NOTES

- REFER TO SHEET A8.00 FOR ALL WALL AND FLOOR ASSEMBLIES.
- REFER TO STRUCTURAL SHEETS FOR ALL COLUMN,
- BEAM, JOIST SCHEDULES.
- ALL INTERIOR WALLS TO BE 2x4 @ 16" OC (UNO). ALL EXTERIOR WALLS TO BE 2x6 @ 16" OC (UNO).
- INSULATED EXTERIOR WALLS TO BE MIN R-21, HEADERS MIN R-10 PER SEC 6-1, FOOTNOTE 7.
- PROVIDE BACKING IN ALL WALLS AS REQUIRED FOR REQUIRED GRABBARS, HANDRAILS, SHELVES, CABINETS, BRACKETS, ETC.
- PROVIDE FIREBLOCKING OVER SUPPORTS.
- PROVIDE SOLID BLOCKING OVER SUPPORTS. ALL WINDOWS TO BE FLUSH HEADERS UNO.
- WINDOW SIZES ARE NOMINAL ROUGH OPENING, WIDTH AND HEIGHT.
- DOOR SIZES NOTED ARE SLABS NOT ROUGH OPENINGS.
- PROVIDE TEMPERED SAFETY GLAZING PER SRC R308 IN ALL DOORS, TYP.

KEYNOTE LEGEND

- 01 LINE OF BUILDING ABOVE
- 02 LINE OF AWNING ABOVE
- 05 LINE OF STAIR ABOVE 08 BIORETENTION PLANTER
- 12 NEW DOOR REPLACES EGRESS WINDOW // MAINTAIN EGRESS REQUIREMENTS FROM BEDROOM
- 13 FIREPLACE: INSTALL 'UL' LISTED AND APPROVED DIRECT VENT GAS FIREPLACE PER MANUFACTURER SPECIFICATION. PROVIDE NON-COMBUSTABLE MATERIALS WITHIN 12"
- 14 EXHAUST PATH FROM FIREPLACE
- 15 HATCH REPRESENTS DROPPED SOFFIT
- 16 REMOVE EXISTING WINDOW / CREATE OPENING TO NEW CONDITIONED SPACE
- 23 FALL PROTECTION: PROVIDE 36" HIGH SOLID WALL AS GUARDRAIL PER SRC R312.1.2
- 24 REFER TO STAIR NOTES ON G0.01 FOR ALL STAIR REQUIREMENTS
- 31 EXTERIOR WALL PROTECTION: 1-HOUR PROTECTION REQUIRED WITHIN 5' OF ASSUMED PROPERTY LINE
- FOR NON-SPRINKLERED BUILDINGS / WITHIN 3' FOR SPRINKLERED BUILDINGS (SRC TABLES R302.1(1) AND
- 40 LINE OF GUTTER ABOVE, TYP
- 41 DOWNSPOUT TO CITY-APPROVED POINT OF DISCHARGE INDEPENDENT OF FOOTING DRAIN REQUIREMENTS
- 63 TYPICAL W 10X26 STEEL COLUMN -REFER TO STRUCTURAL SHEETS
- 64 REFER TO STRUCTURAL SHEETS

1319 N 49TH ST, SEATTLE, WA 98103 TEL. (206) 693-3133

SDCI Approval Stamp

DESCRIPTION DATE MARK BUILDING PERMIT INTAKE



812 23RD AVE **ADDITION**

FLOOR PLAN

SDCI Project Numbers	6868236-CN
Issue Date	09/07/2022
Drawn by	MC
Charled by	CS

A2.02

CONE Project Number

TYPICAL ROOF NOTES

- REFER TO ARCH PLAN FOR ALL FIRE RATING LOCATIONS.
- REFER TO ARCH PLAN FOR SLOPE DIRECTION, PITCH, AND CRICKET LOCATIONS
- ALL MANUFACTURED TRUSSES:
 REFER TO STRUCTURAL DRAWINGS FOR REQUIRED
- ROOF LOADS AND TRUSS MANUFACTURER REQUIREMENTS.
- SHALL HAVE DESIGN DETAILS AND DRAWINGS ON
- SITE FOR FRAMING INSPECTION.
- SHALL BE INSTALLED AND BRACED TO MANUFACTURER'S SPECIFICATIONS. SHALL CARRY MANUFACTURER'S STAMP ON EACH
- DS = DOWNSPOUT TIGHT-LINED TO APPROVED DRAINGAGE LOCATION AND INDEPENDENT OF
- FOOTING DRAIN.
- REFER TO SHEET A8.00 TO VERIFY VENTED OR UNVENTED ASSEMBLY REQUIREMENTS.

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SDCI Approval Stamp

DESCRIPTION DATE BUILDING PERMIT INTAKE





812 23RD AVE **ADDITION**

ROOF PLAN

6868236-CN
09/07/2022
MC
GS

A2.03

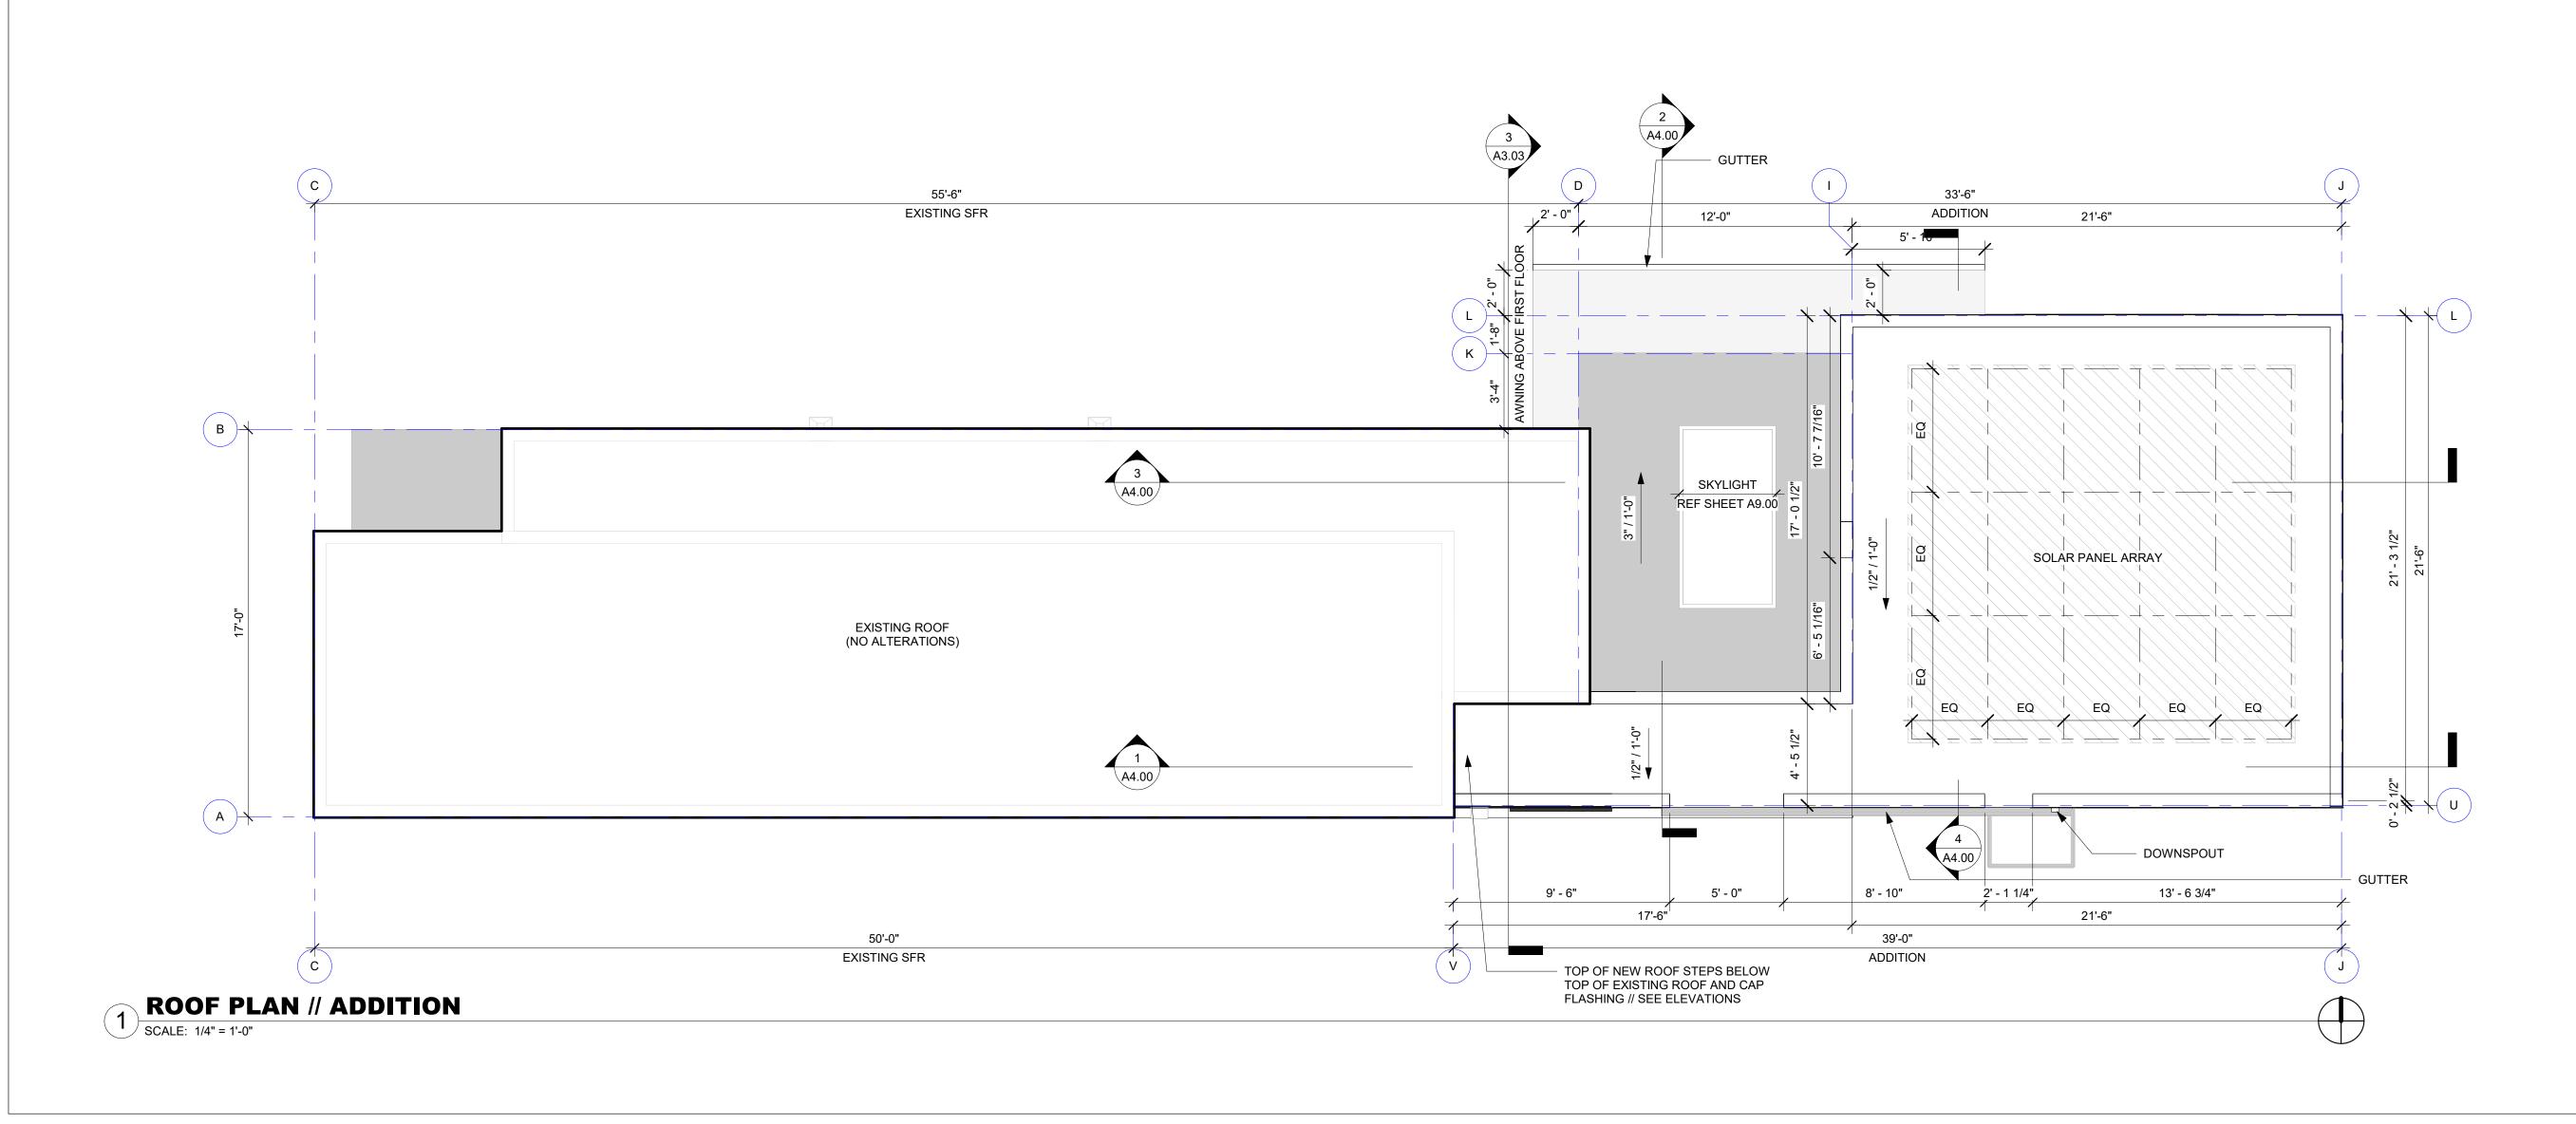

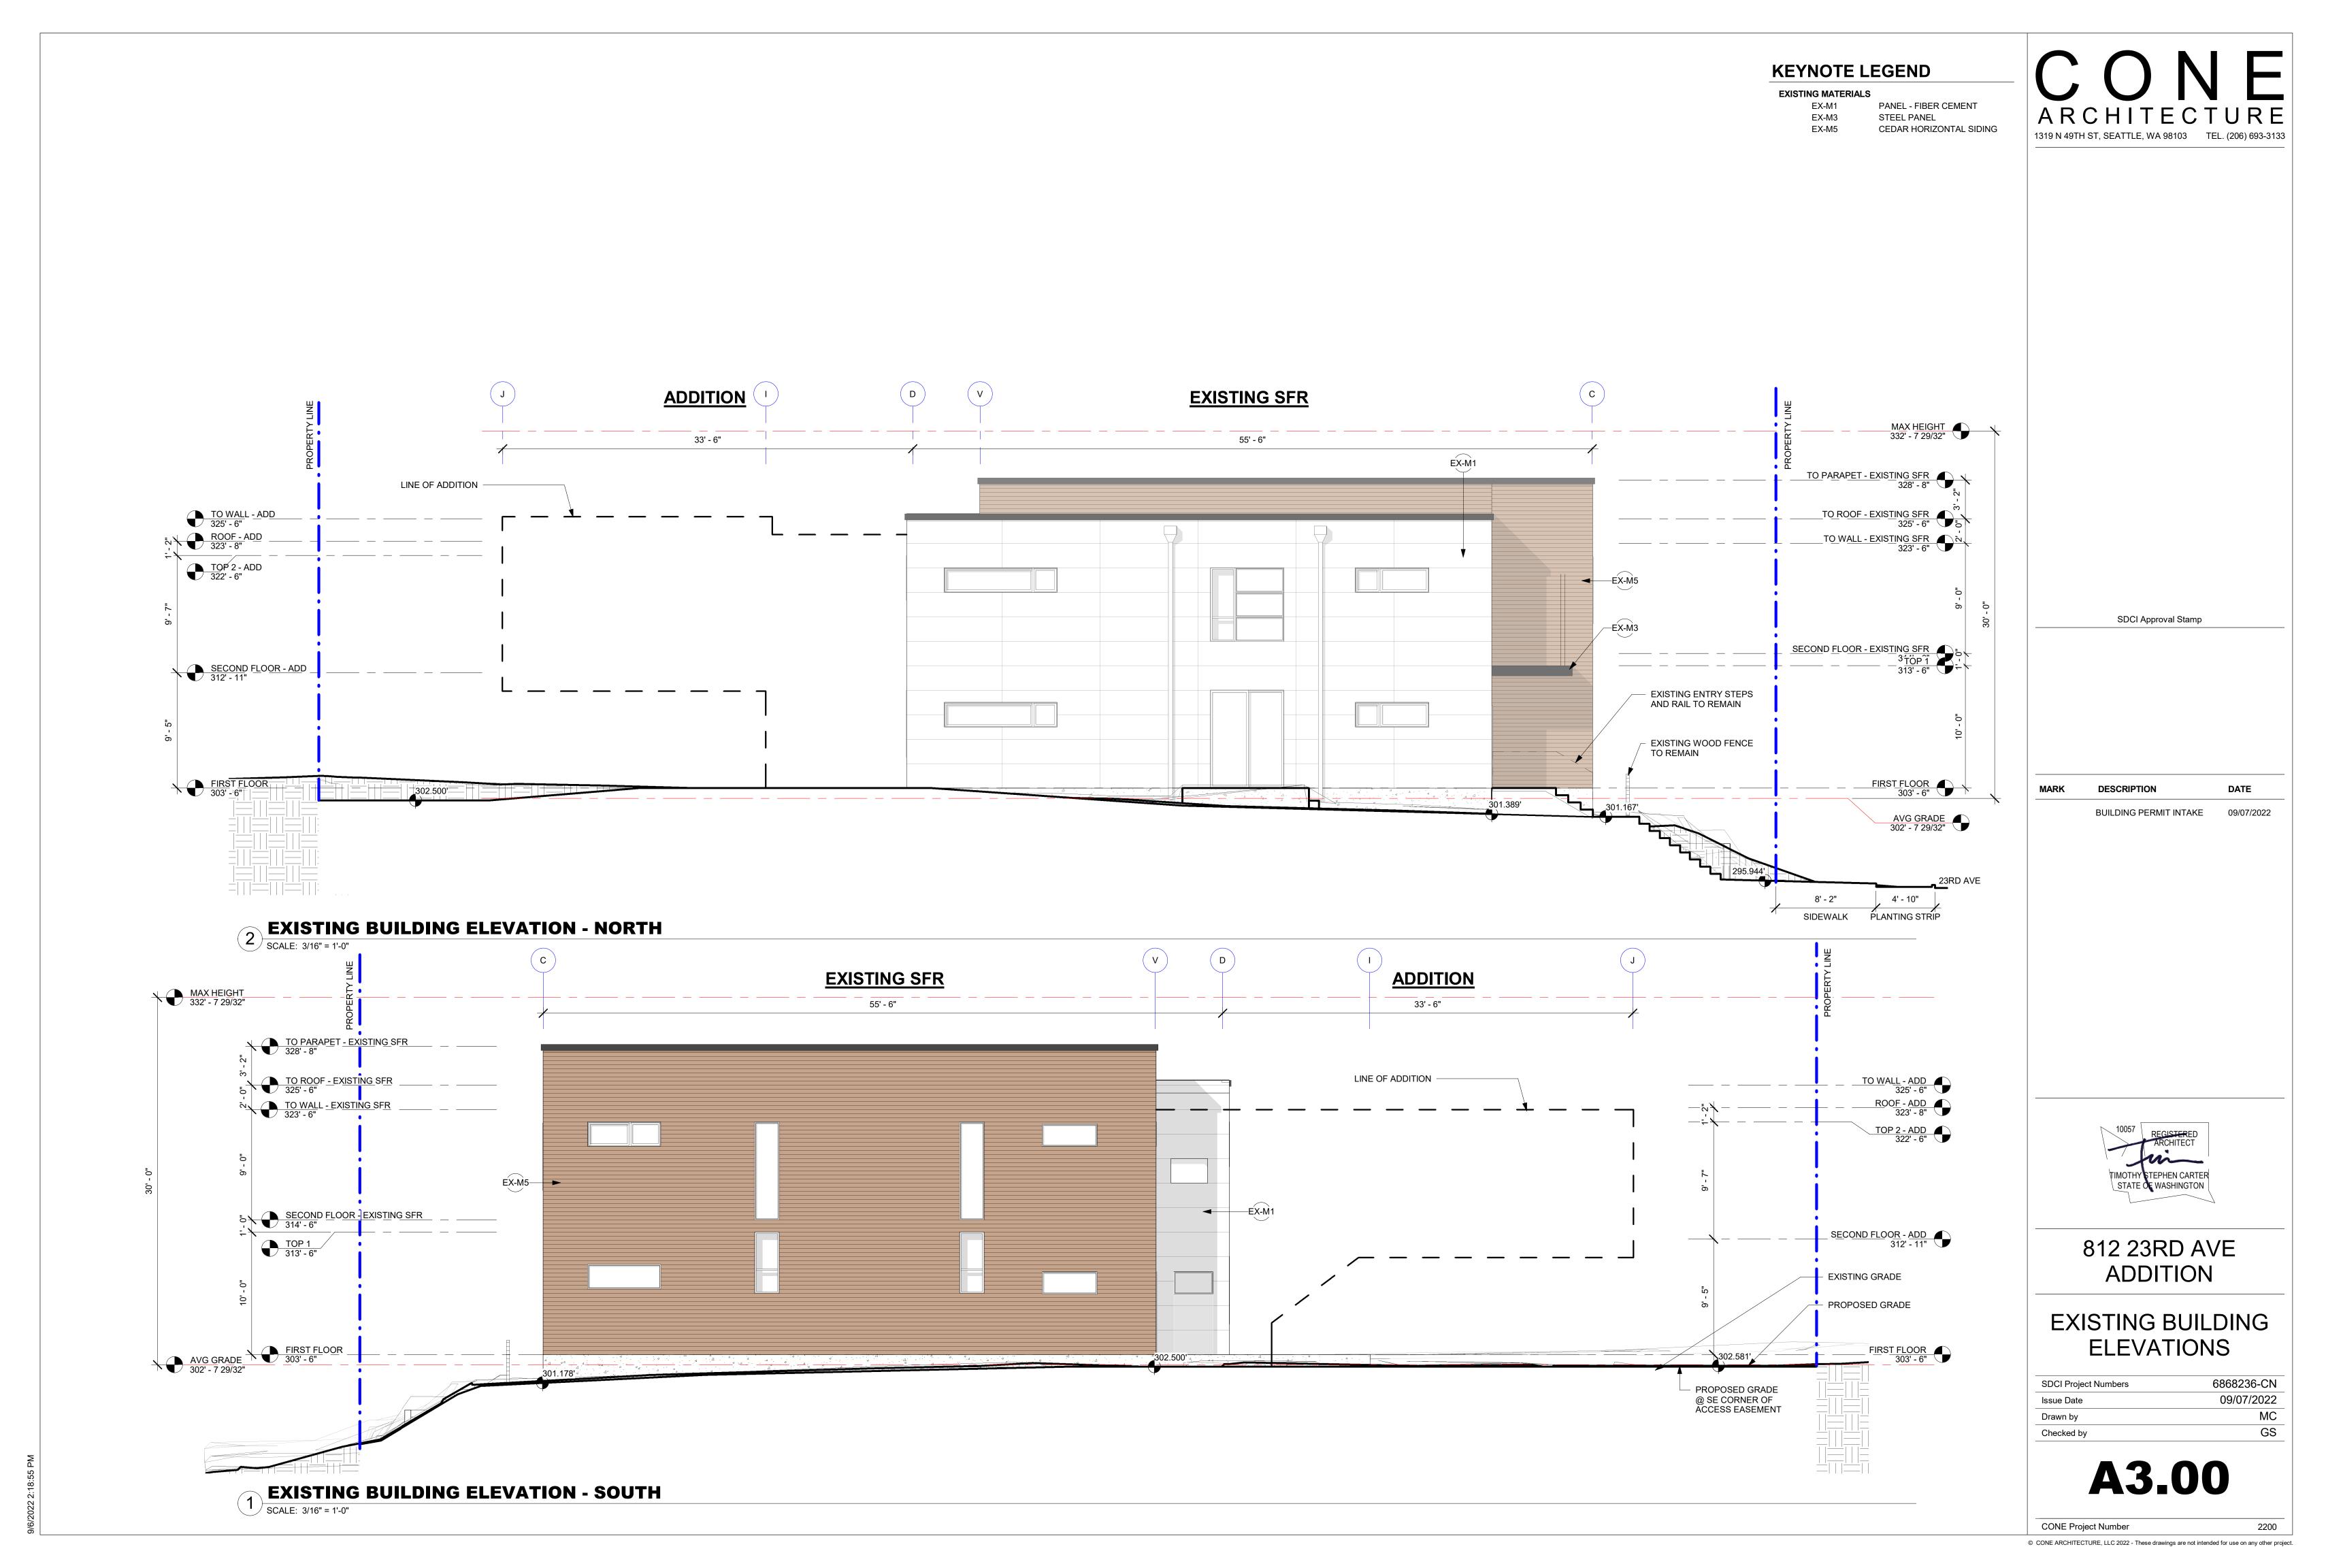

KEYNOTE LEGEND ELEMENTS FINISHES MATERIALS EXISTING MATERIALS PANEL - FIBER CEMENT PANEL - FIBER CEMENT F2 PAINTED - GUN METAL GRAY EX-M1 E4 CAP FLASHING INFILL - FIBER CEMENT EX-M3 STEEL PANEL F4 PAINTED - TO MATCH EXISTING PANEL SIDING E5 DOWNSPOUT FM PAINTED TO MATCH ADJACENT MATERIAL STEEL PANEL EX-M5 CEDAR HORIZONTAL SIDING FIREPLACE VENT 1319 N 49TH ST, SEATTLE, WA 98103 TEL. (206) 693-3133 FASCIA BOARD - FIBER CEMENT E7 BLACK WINDOWS CEDAR HORIZONTAL SIDING (MATCH E8 STEEL I BEAM PER STRUCTURAL EXISTING CEDAR SIDING) $\left(\begin{array}{c} \mathsf{c} \end{array} \right)$ **ADDITION EXISTING SFR** MAX HEIGHT 332' - 7 29/32" 33' - 6" 55' - 6" TO PARAPET - EXISTING SFR 328' - 8" (M4)(F2)- (F2)(E4)---TO ROOF - EXISTING SFR 325' - 6" EX-M1 TOP 2 - ADD 322' - 6" EX-M5 SDCI Approval Stamp F4 M1 SECOND FLOOR - ADD 312' - 11" EXISTING ENTRY STEPS AND RAIL TO REMAIN EXISTING WOOD FENCE F2 M3 TO REMAIN FIRST FLOOR 303' - 6" DESCRIPTION DATE BUILDING PERMIT INTAKE AVG GRADE 302' - 7 29/32" 4' - 10" PLANTING STRIP SIDEWALK **BUILDING ELEVATION - NORTH** (V) D **EXISTING SFR ADDITION** MAX HEIGHT 332' - 7 29/32" 55' - 6" 33' - 6" TO PARAPET - EXISTING SFR 328' - 8" TO WALL - EXISTING SFR 323' - 6" TOP 2 - ADD 322' - 6" EX-M5 M1 F4 SECOND FLOOR - EXISTING SFR FM E6 TOP 1 313' - 6" 812 23RD AVE **ADDITION** EXISTING GRADE PROPOSED GRADE _____E5_F2 BUILDING AVG GRADE 50303' - 6" 5030' - 6" **ELEVATIONS** FIRST FLOOR
303' - 6" 301.178 6868236-CN SDCI Project Numbers PROPOSED GRADE@ SE CORNER OF ACCESS EASEMENT 09/07/2022 SEE ALLOWABLE OPENING DIAGRAM // G0.03 Issue Date Drawn by GS Checked by A3.01 **BUILDING ELEVATION - SOUTH** SCALE: 3/16" = 1'-0" CONE Project Number

KEYNOTE LEGEND

EXISTING MATERIALS


EX-M1 PANEL - FIBER CEMENT
EX-M3 STEEL PANEL
EX-M5 CEDAR HORIZONTAL SIDING





EXISTING BUILDING ELEVATION - EAST

SCALE: 1/4" = 1'-0"

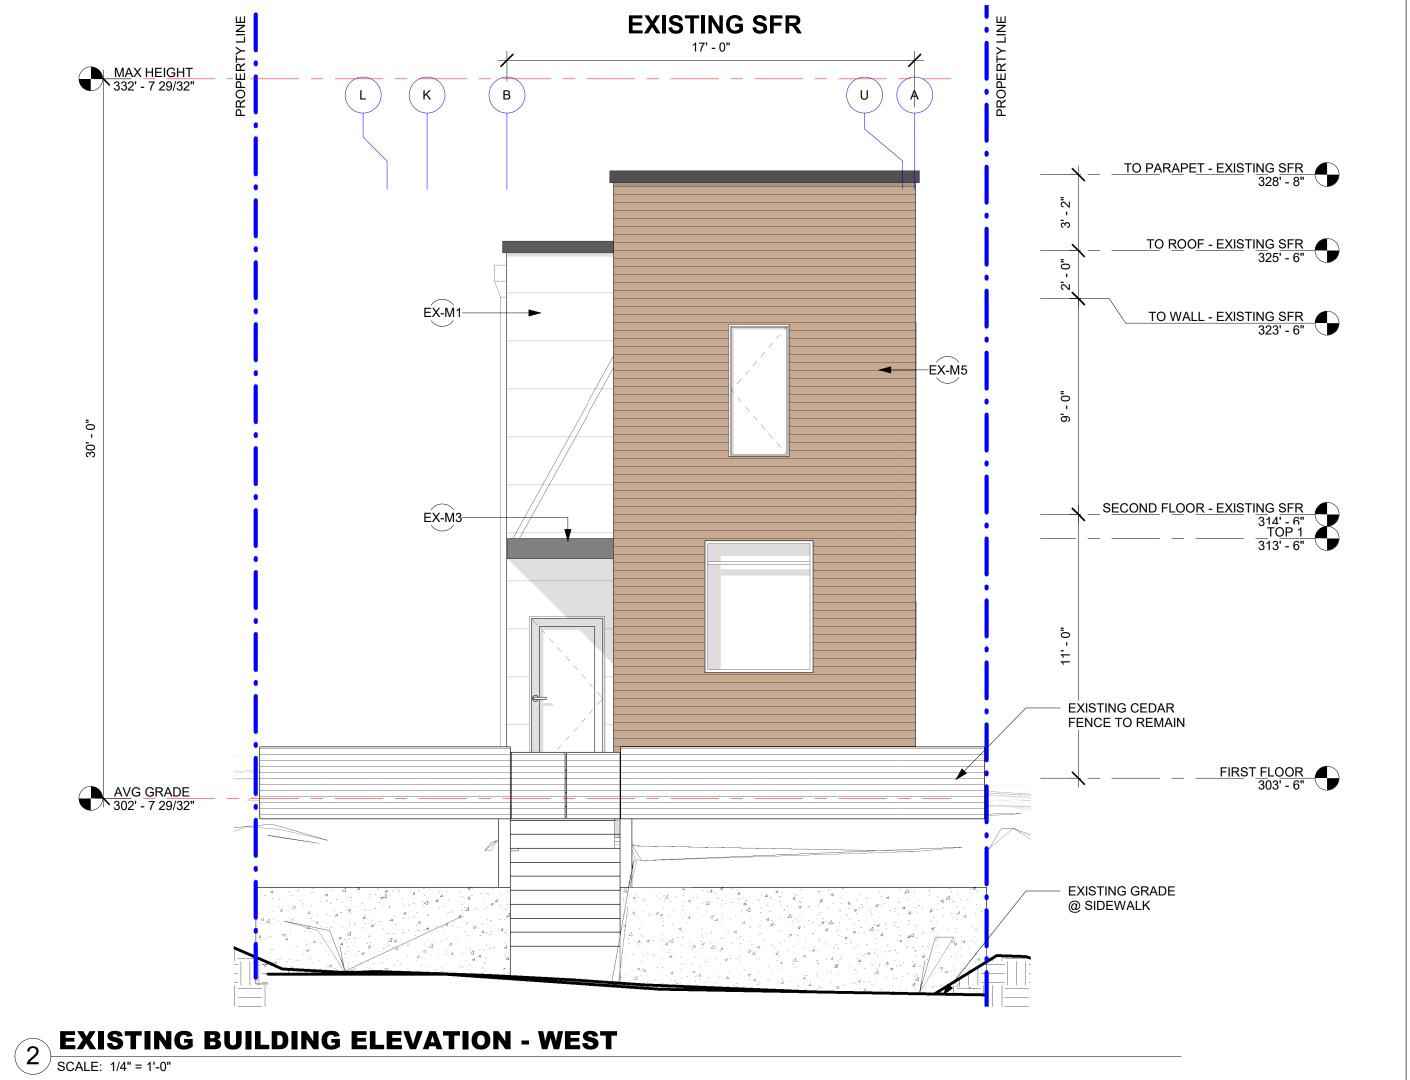

MARK DESCRIPTION DATE

BUILDING PERMIT INTAKE 09/07/2022

SDCI Approval Stamp



812 23RD AVE ADDITION

EXISTING BUILDING ELEVATIONS


SDCI Project Numbers	6868236-CN
Issue Date	09/07/2022
Drawn by	MC
Checked by	GS

A3.02

Number 2

© CONE ARCHITECTURE, LLC 2022 - These drawings are not intended for use on any other project.

MG 90.49.06 PM

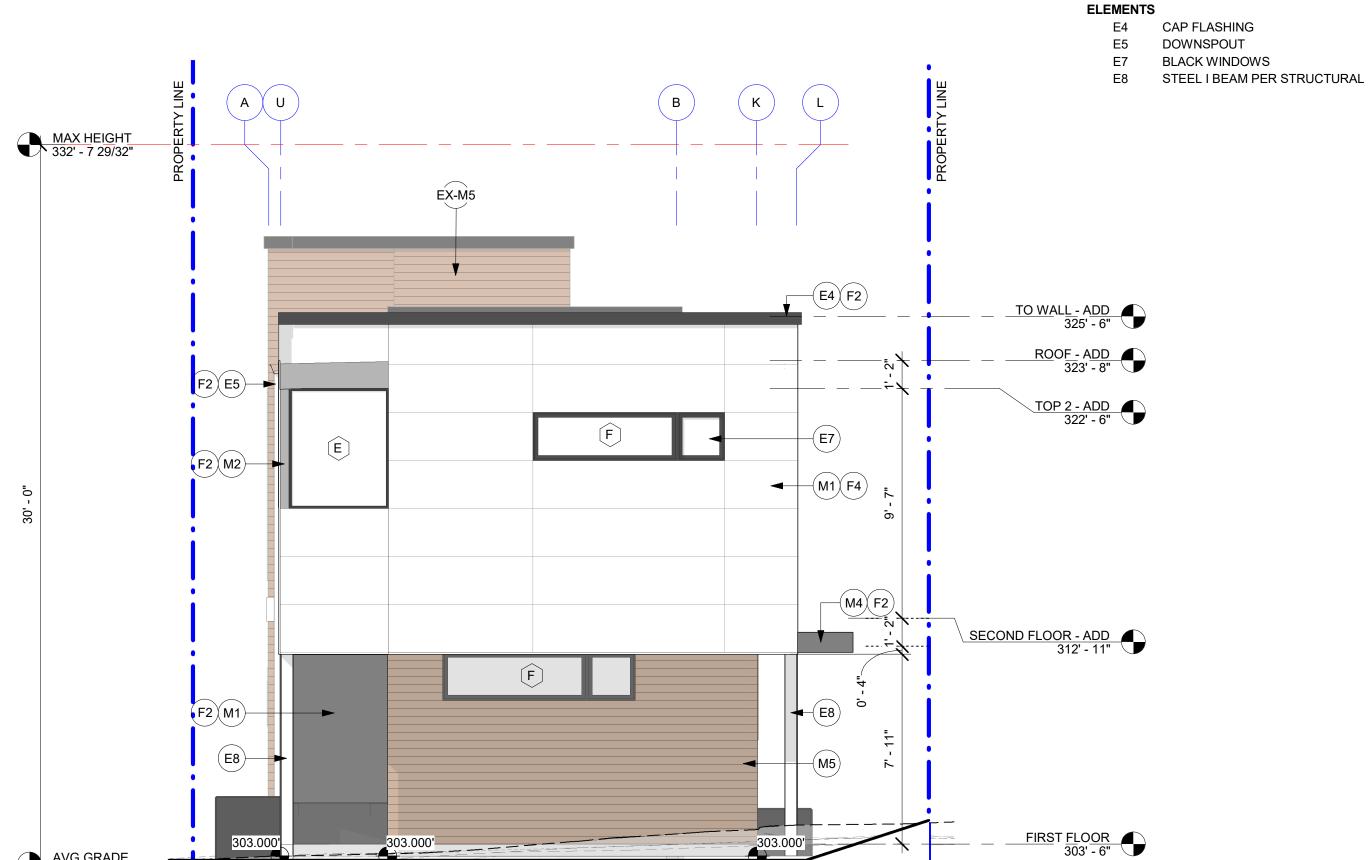

KEYNOTE LEGEND

F4 PAINTED - TO MATCH EXISTING PANEL SIDING E5 DOWNSPOUT **BLACK WINDOWS**

FINISHES

F2 PAINTED - GUN METAL GRAY

MATERIALS M1

PANEL - FIBER CEMENT INFILL - FIBER CEMENT FASCIA BOARD - FIBER CEMENT CEDAR HORIZONTAL SIDING (MATCH EXISTING CEDAR SIDING)

EXISTING MATERIALS EX-M1 EX-M3

TO PARAPET - EXISTING SFR 328' - 8"

TO WALL - EXISTING SFR 323' - 6"

SECOND FLOOR - EXISTING SFR 314' - 6" TOP 1 313' - 6"

FIRST FLOOR 303' - 6"

EXISTING CEDAR
FENCE TO REMAIN

- EXISTING GRADE @ SIDEWALK

300.341'

TO WALL - ADD TO ROOF - EXISTING SFR 325' - 6"

EX-M5

PANEL - FIBER CEMENT STEEL PANEL CEDAR HORIZONTAL SIDING 1319 N 49TH ST, SEATTLE, WA 98103 TEL. (206) 693-3133

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DESCRIPTION DATE BUILDING PERMIT INTAKE

812 23RD AVE **ADDITION**

BUILDING **ELEVATIONS**

SDCI Project Numbers 6868236-CN 09/07/2022 Issue Date Drawn by Checked by

A3.03

AVG GRADE 302' - 7 29/32" **BUILDING ELEVATION - EAST** 1 SCALE: 1/4" = 1'-0" **ADDITION EXISTING SFR** (L)(K) B MAX <u>HEIGHT</u> 332' - 7 29/32" K EX-M1 F2 E4 — 7' - 6" 3' - 6" 5' - 0" TO WALL - ADD 325' - 6" (F2)(E4) ROOF - ADD 323' - 8" TOP 2 - ADD 322' - 6" F4 M1 F4 M1 (E7)— EX-M5 (E7)— EX-M3 F2 M4 SECOND FLOOR - ADD 312' - 11" OMITTED FOR CLARITY, SEE SECTION 2//A4.00 E8 → F2 E5 303.500' FIRST FLOOR


AVG GRADE

- 302' - 7 29/32" 302.660' AVG GRADE 302' - 7 29/32"


ADDITION ELEVATION - WEST SCALE: 1/4" = 1'-0"

BUILDING ELEVATION - WEST

SCALE: 1/4" = 1'-0"

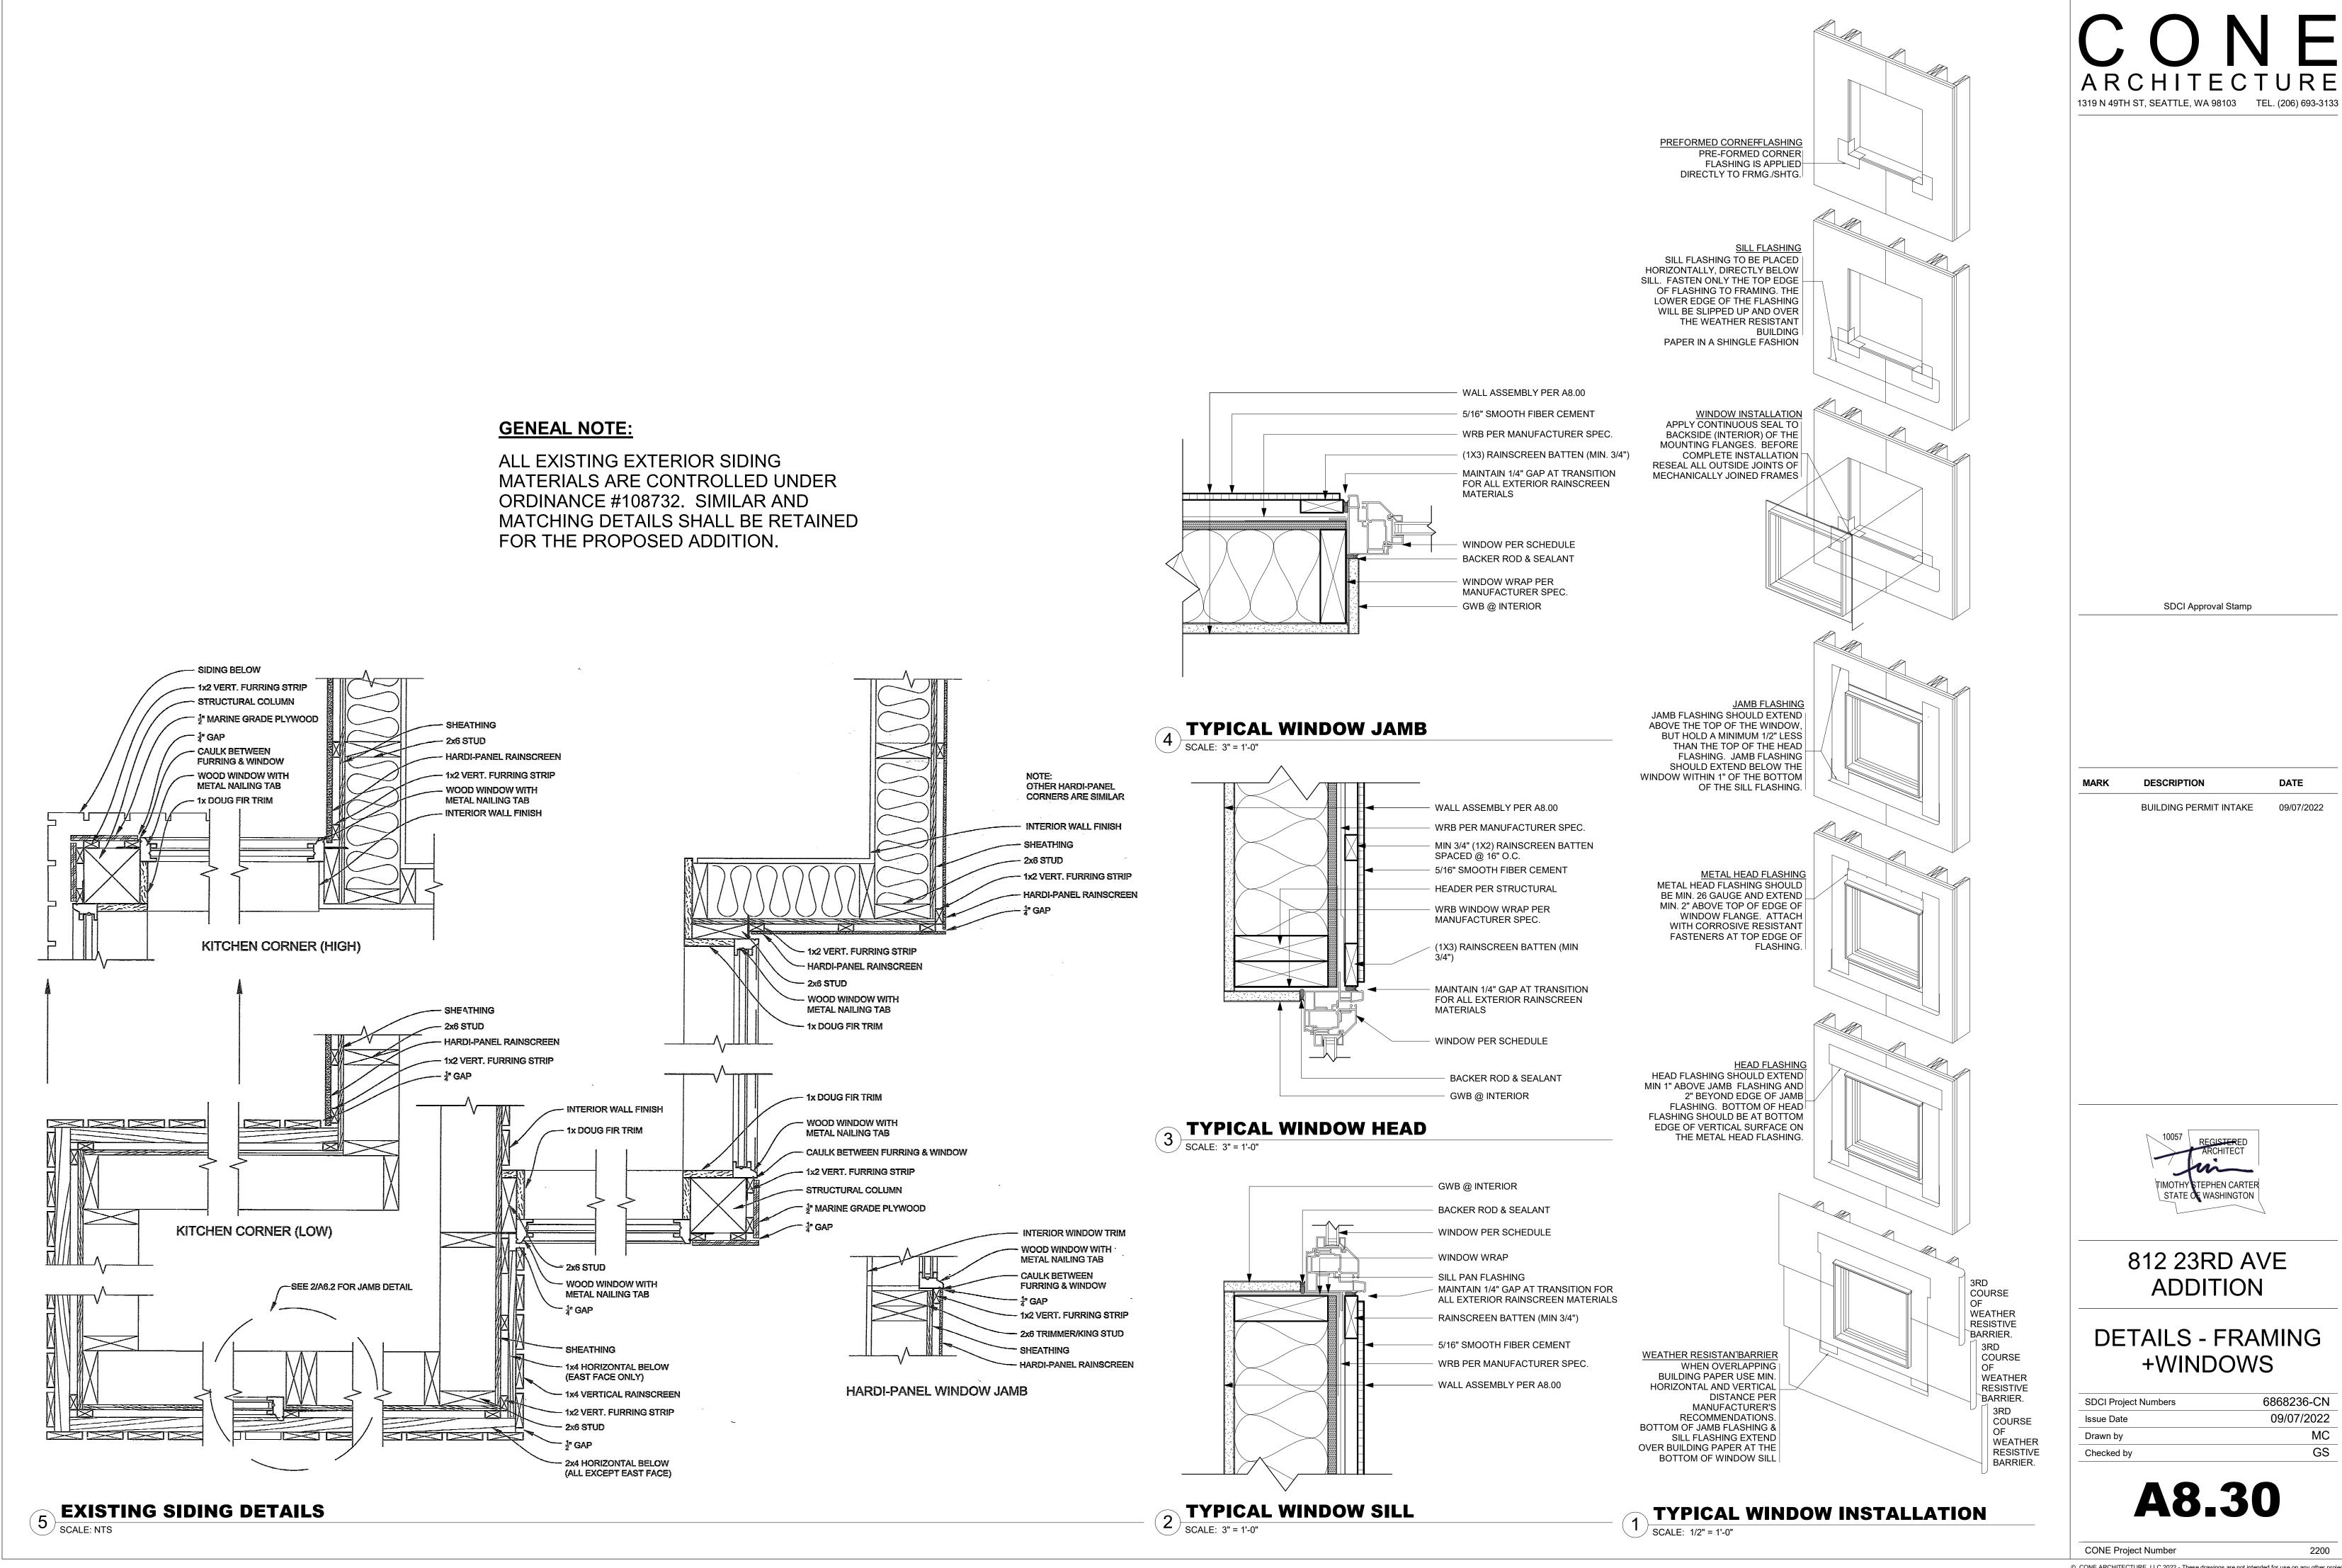

0.10.15 DM

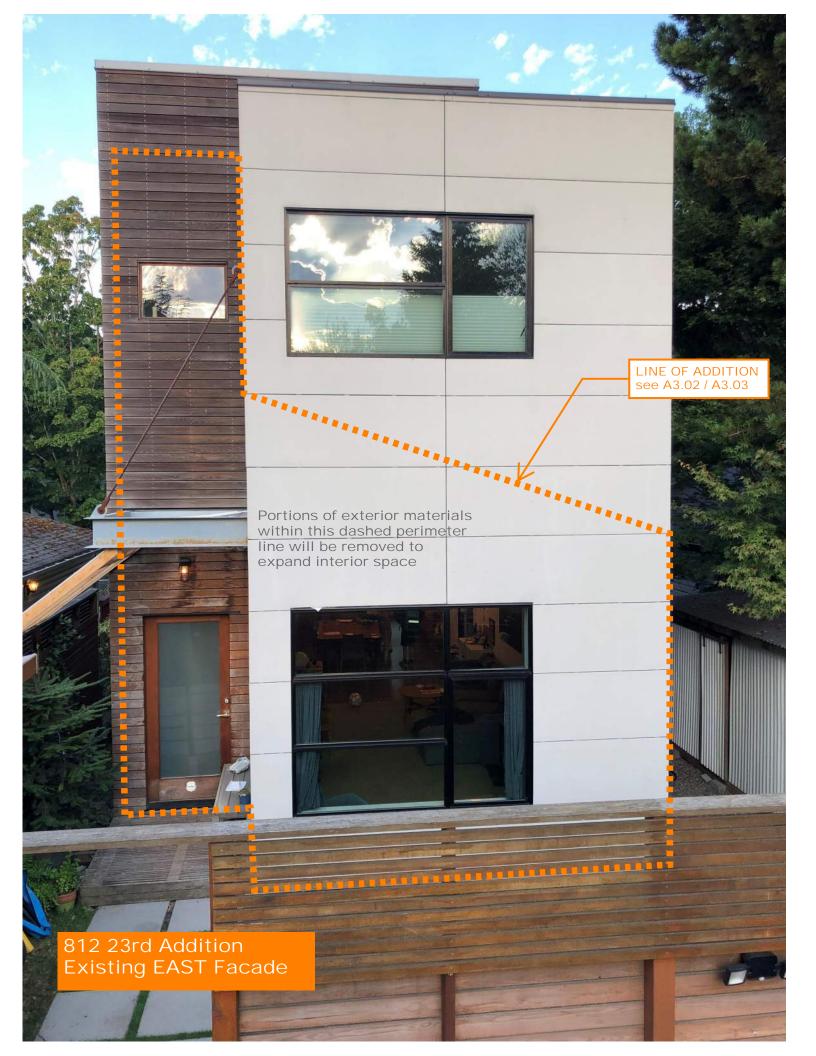



Existing Streetscape along 23rd Ave



Fiber Cement Panel & Cedar Rainscreen Transition



Fiber Cement Panel - True White

EXISTING EXTERIOR SPECIFICATIONS

FIBER CEMENT SIDING SPECIFICATION

- 5/16" Smooth Architectural Panel, 2' wide
- · Open-Joint Rainscreen
- Finished with Exterior Acrylic Latex Paint: Sherwin Williams Super Paint - True White

CEDAR SIDING SPECIFICATION

- 1x4 S4S Clear Cedar
- · Open-Joint Rainscreen
- Attached with Exposed Stainless Ringshank Nail
- Finished with Semi-Transparent Stain: Sherwin Williams Woodscapes - Cedarbark



Cedar Rainscreeen - Cedarbark



The City of Seattle

Landmarks Preservation Board

Mailing Address: PO Box 94649 Seattle WA 98124–4649 Street Address: 700 5th Ave Suite 1700

LPB 319/07

CERTIFICATE OF APPROVAL

812 23rd Ave 23rd Avenue Houses Group

On September 19, 2007, the Landmarks Preservation Board voted to grant a Certificate of Approval for the proposed new construction on the vacant lot, as per the attached submittal.

Features and Characteristics for which a Certificate of Approval is required: See Ordinance #108732

Summary of proposed changes: Proposed new construction on vacant lot

I hereby issue a Certificate of Approval for the proposed new construction on the vacant lot. This action is based on the following:

- The proposed changes do not adversely affect the features or characteristics specified in Ordinance # 108732 as the proposed new construction does not destroy historic materials that characterize the property, and
- 2. The design is compatible with the massing, size and scale and architectural features of the 23rd Avenue Houses Group, as per Standard #9 of the Secretary of Interior's Standards for Rehabilitation:

New additions, exterior alterations, or related new construction will not destroy historic materials, features, and spatial relationships that characterize the property. The new work shall be differentiated from the old and will be compatible with the historic materials, features, size, scale and proportion, and massing to protect the integrity of the property and its environment.

The other factors in SMC 25.12.750 are not applicable to this application.

This action is pursuant to SMC 25.12 and does not waive the owner's obligations with regard to other permits and plans.

Issued: September 24, 2007

Stephen Lee,

Chair

By: Elizabeth Chave

Landmarks Preservation Board Coordinator

cc: Mark Hazlip

Diane Sugimura, DPD Cheryl Mosteller, DPD Stephen Lee, Chair, LPB

NOTICE TO APPLICANT:

Work must occur exactly according to approved plans and specifications. ANY revisions, omissions and/or additions to plans and specifications must be reviewed and approved by the Landmarks Preservation Board prior to implementation.

APPEAL PROCEDURE

In accordance with SMC 25.12.740, any interested person may appeal to the Hearing Examiner the decision of the Board to grant, deny or attach conditions to a certificate of approval by serving written notice of appeal upon the Board and filing such notice and a copy of the Board's decision with the Hearing Examiner (Office of the Hearing Examiner, Seattle Municipal Tower, 700 5th Ave., 40th Floor) within 14 days after such grant, denial or conditional grant. The written appeal must clearly state the appellant's objections to the decision, and must be accompanied by a \$50.00 filing fee. The written appeal and filing fee must reach the Office of the Hearing Examiner prior to 5:00 p.m. on the last day of the appeal period.