



I hereby affirm that I am the owner of the property located at:

Property Address/Location: 1119 1st Ave.

City: Seattle State: WA Zip Code: 98101

By signing below, I verify that I have reviewed the proposed project/activities and authorize the individual identified in the following section to act as my authorized agent with regard to the Certificate of Approval Application (including requests for preliminary project briefings) made to City of Seattle’s Historic Preservation Program for the project/activities described below.

Project/Activity for which Application (or briefing request) is being made: Exterior façade repairs limited to general masonry cleaning, brick repointing, sandstone tooling (removal of exfoliated sandstone), sandstone patching, terra cotta repair, terra cotta repointing. Project also includes replacement of non-original wood windows (previously replaced in 1981) with new aluminum clad wood windows in existing wood window frames and modifications to existing juliette balconies (north and east facades) and balconies (west façade) to improve life-safety performance.

Signature of Owner:  Date: February 9, 2021

Printed Owner Name: Douglas Stroud, Board President, Colonial Grand Pacific Owners Association

Owner Mailing Address 710 Kensington Lane

City: Bloomfield Hills State: MI Zip Code: 48304

Owner Email Address: dstroud.work@gmail.com

Printed Name of Permit Applicant/
Owner’s Authorized Agent: Matt Hamel, SHKS Architects

Address: 1050 N. 38th St.

City: Seattle State: WA Zip Code: 98107

Applicant Email Address: matth@shksarchitects.com

Signature of Applicant/Agent:  Date: 2/11/2021

Introduction

This Certificate of Approval (COA) application is for the exterior facade repairs, modification of balconies (seismic and life safety), and window replacement scope for the Colonial Grand Pacific Condominiums, formerly the Grand Pacific Hotel and the Colonial Hotel located at 1119 First Avenue, in downtown Seattle.

The Grand Pacific and Colonial Hotel as part of the "First Avenue Groups/Waterfront Center Project" are Seattle Landmarks designated by the Landmarks Preservation Board, per Ordinance 111058. The designation is based on meeting the following criteria: significant relationship to the city's economic heritage; architectural significance; and significant spatial relationships and contribution to distinctive historical identity of First Avenue. Controlled features include the entire exteriors of the properties listed.

Architectural Description

The Colonial Grand Pacific Condominiums is comprised of two historic buildings, the Grand Pacific Hotel, and the Colonial Hotel. The two buildings were renovated and joined during the 1981 Waterfront Center Project.

The Grand Pacific Building was built in 1889 and is comprised of unreinforced brick and stone masonry construction with a four-story primary, front façade at First Avenue and a six-story façade along Post Avenue. The front façade consists of red pressed brick and rusticated cut sandstone and sculptural elements, while the rear façade at Post Avenue consists mainly of red common brick. The front façade terminates into a metal cornice and red brick parapet wall that is capped with sandstone coping stones. The Grand Pacific fenestration currently consists of a mix of replacement double-hung, casement, hopper, and fixed wood windows.

The first phase of the Colonial Building was constructed between 1892 and 1893. The Colonial Building is unreinforced brick masonry construction and was initially completed to one-story at First Avenue and four-stories at Post Avenue. The primary exterior material of the first building phase is red common brick with some bush-hammered sandstone quoins located to the northeast corner at the terminus of the First Avenue storefront. The fenestration mainly consisted of segmentally arched openings, some of which were later filled on the north façade of the fourth level.

The second phase of the Colonial Building was constructed in 1901, becoming the Colonial Hotel. The exterior materials and fenestration of the three-story addition differ greatly from the initial phase of the building. The front (east) and north façade of the 1901 addition consist of tan pressed brick, with cream-colored terra cotta decorative elements such as a Greek key belt course, sill course, and voussoirs at the openings. The west façade along Post Avenue consists mainly of red common brick, with terra cotta detailing wrapping at the northwest corner. Wrought iron Juliet balconies adorn the openings of the fifth floor at the east and north facades. The east and north facades terminate into an entablature and a modillion supported metal cornice. The Colonial fenestration currently consists of a mix of replacement double-hung, casement, hopper and fixed windows. Single pane leaded Palladian windows and sidelights are located at the east façade and north facade. Prior seismic upgrades included concrete shear wall elements over portions of the original brick on the north and west facades of the Colonial Building, and exposed exterior rosettes tying walls to floors and roof. Storefronts at the First Avenue east facade are a combination of cast iron columns, wood frames, and plate glass, which have been modified over time, and are not part of this evaluation or project scope.



Grand Pacific Hotel South and East Facades, ca. 1917



Grand Pacific and Colonial Hotel East and Partial North Facades, ca. 1903

Reason for Proposed Changes

The Colonial Grand Pacific Condominium Association (CGPCA) is in the process of planning repairs and upgrades to the 1892-1901-era Colonial Grand Pacific Building, and commissioned SHKS Architects to provide design and construction drawings for the exterior facade repairs and restoration of the subject building.

Masonry Repairs

- Deferred Maintenance
- Life Safety
- Performance / Durability
- Cosmetic

Window Improvements

- Operation
- Air Infiltration
- Performance
- Acoustics

Balconies

- Life Safety
- Cosmetic

Description of Proposed Work

- Masonry scope includes the cleaning of all exterior brick, terra cotta and sandstone masonry; selective repointing; selective replacement and patching of deteriorated brick; repairs to cracked terra cotta; patching or replacement of existing deteriorated sandstone, particularly at skyfacing ledge areas; treatment of skyfacing mortar joints; removal and patching of abandoned attachments; and repair of parged window sills and ledges. The deteriorated sandstone coping at the Grand Pacific building will be modified for positive drainage and weatherproofing in order to protect the masonry parapet and wall below.
- Window scope includes the replacement of non-original wood windows to match historic types and details, and improve thermal, operational, and acoustic performance, while restoring historic frames and exterior and interior wood trim. Original leaded glass wood windows at the Colonial Building will be repaired, repainted, and interior storm sash added.
- Balcony scope includes the removal and modification of wrought iron Juliet balconies on the east and north facades of the Colonial Building, and steel balconies on the west facade to provide code compliant railings (reduced opening sizes) and improve attachments to the building, and repainted with a durable coating. Plant boxes will be similarly be removed for visual consistency, and recoated.
- Sheet metal scope includes sealing and reaffixing opened seams, repainting, and replacement of sealants at metal cornices.



Colonial Grand Pacific Condominiums East Facade



Colonial Grand Pacific Condominiums North and Partial West Facade



East Facade



East and North Facades



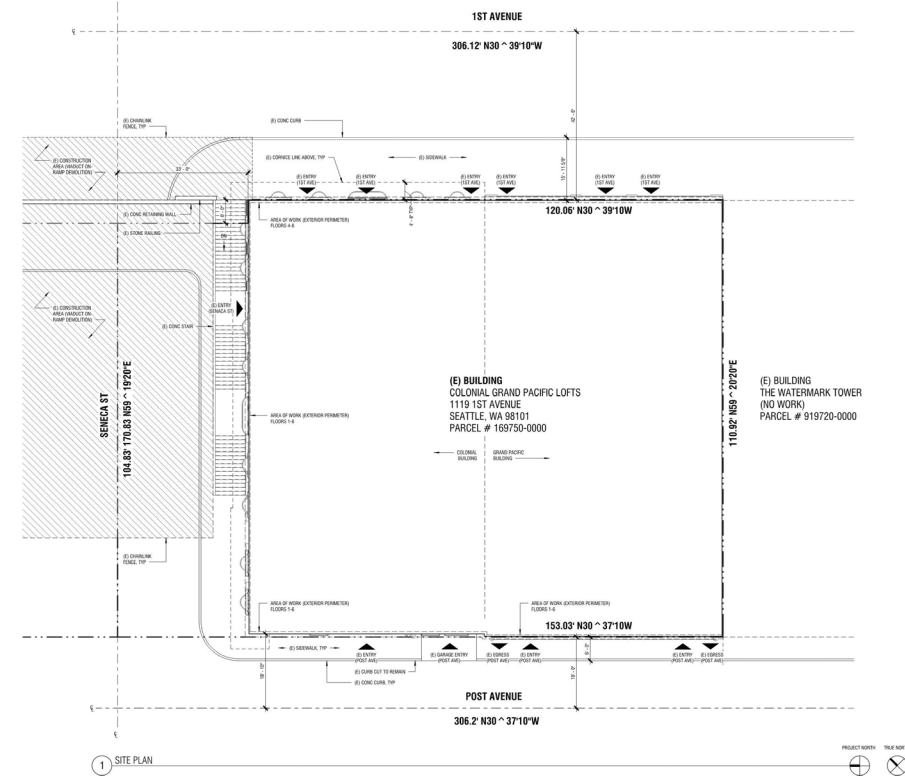
North Facade



Partial North and West Facades



West Facade



Site Plan



TYPICAL MATERIALS AND ELEMENTS



Red Pressed Brick



Red Common Brick



Terra Cotta



Tan Pressed Brick

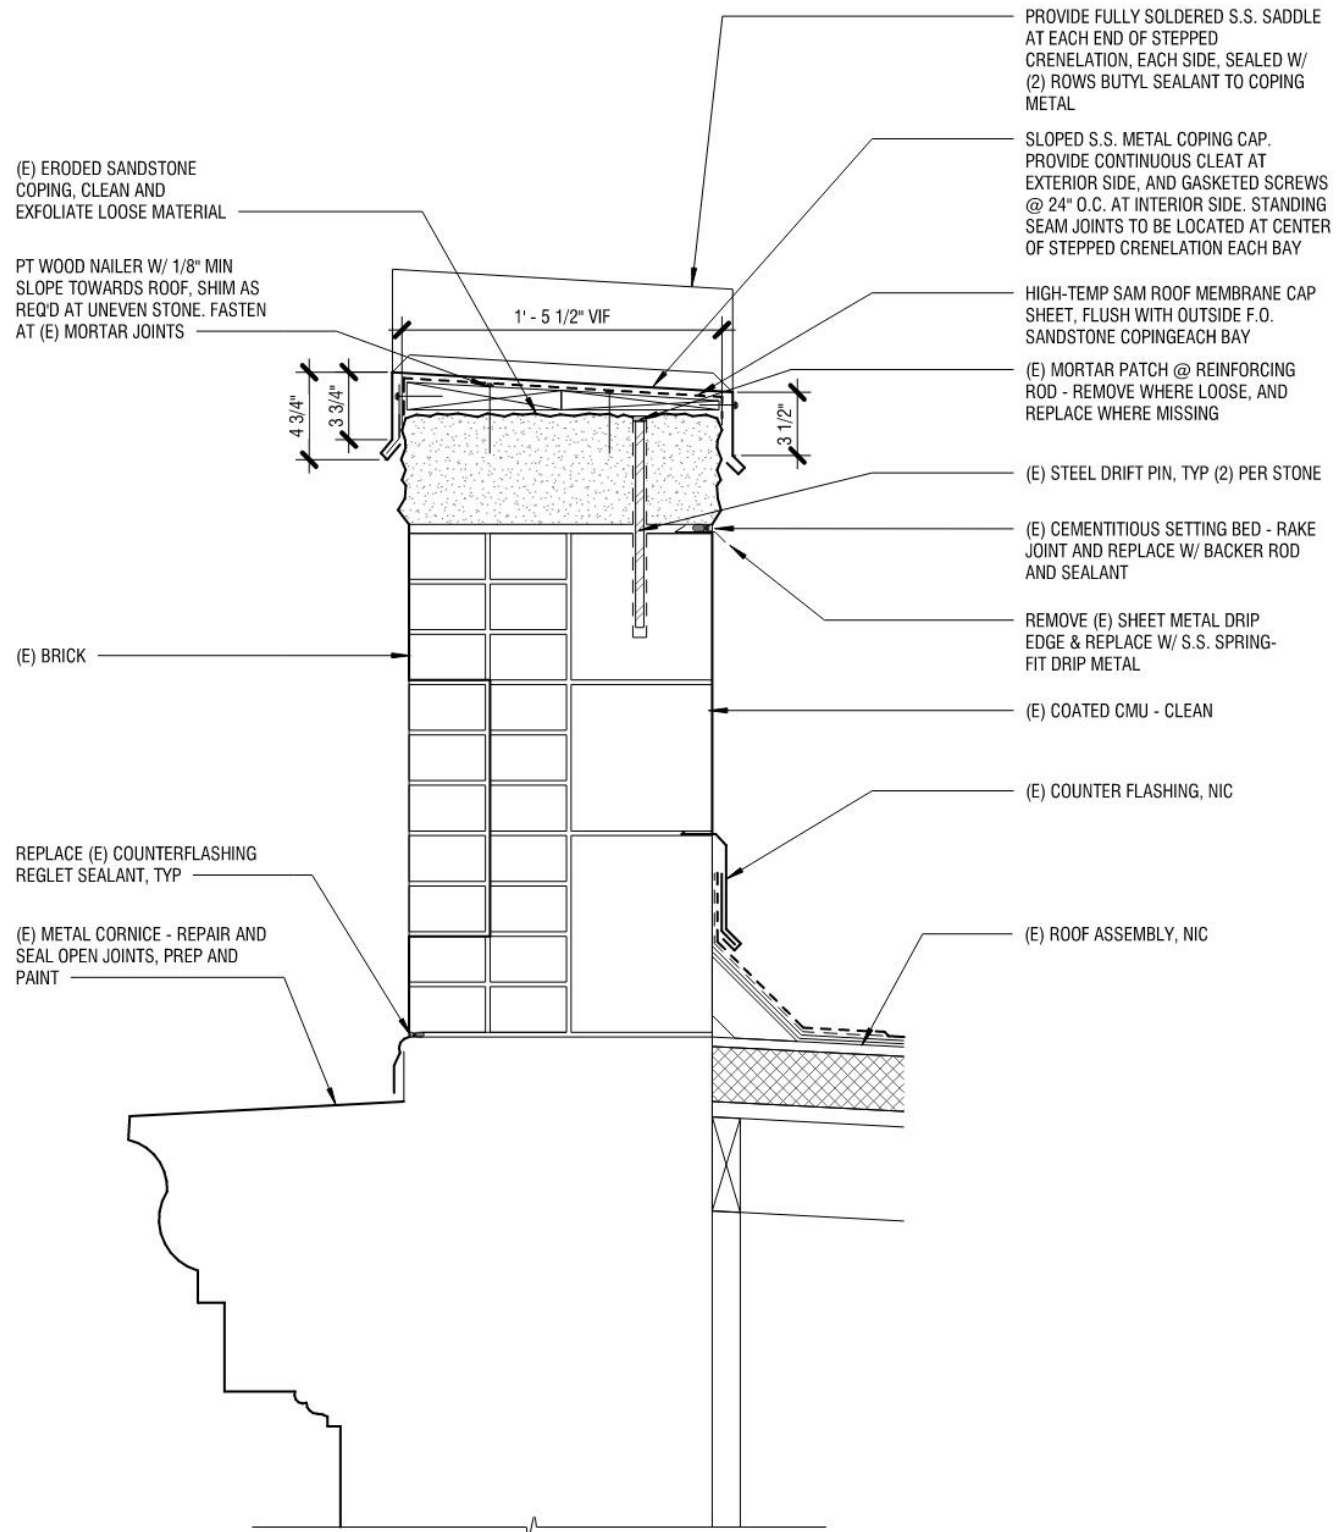


Sandstone



Parging

MASONRY CONDITIONS



Grand Pacific - Parapet Cap Detail

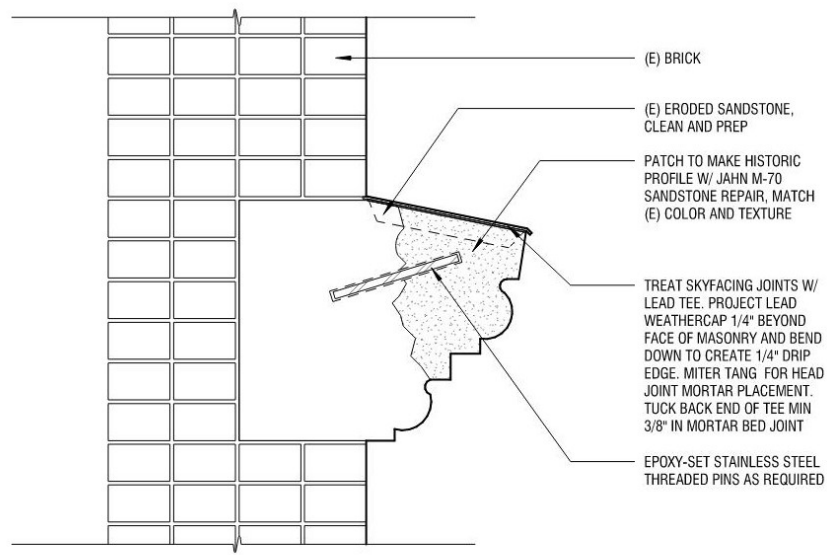


Parapet Wall - Exterior View Facing North




Parapet Wall - Roof View Facing Southeast


PARAPET REPAIRS



Sandstone Option 1 Patch

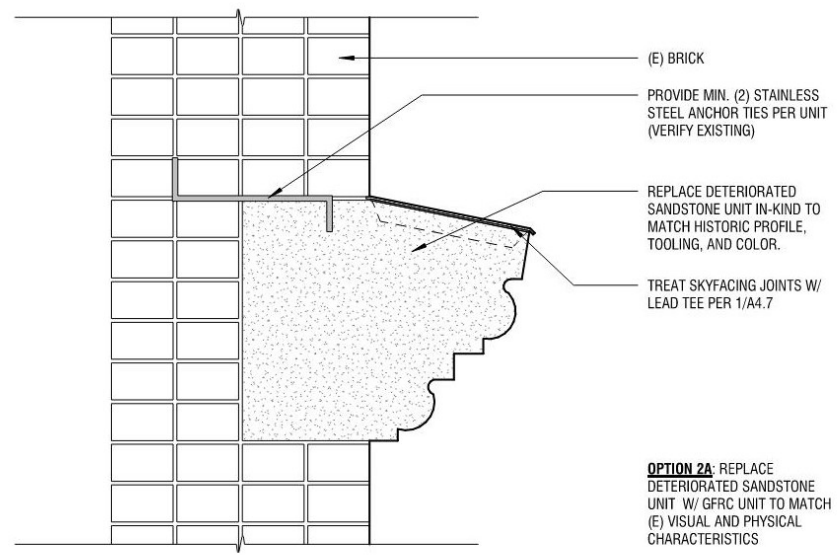


Sandstone Option 2 Replace

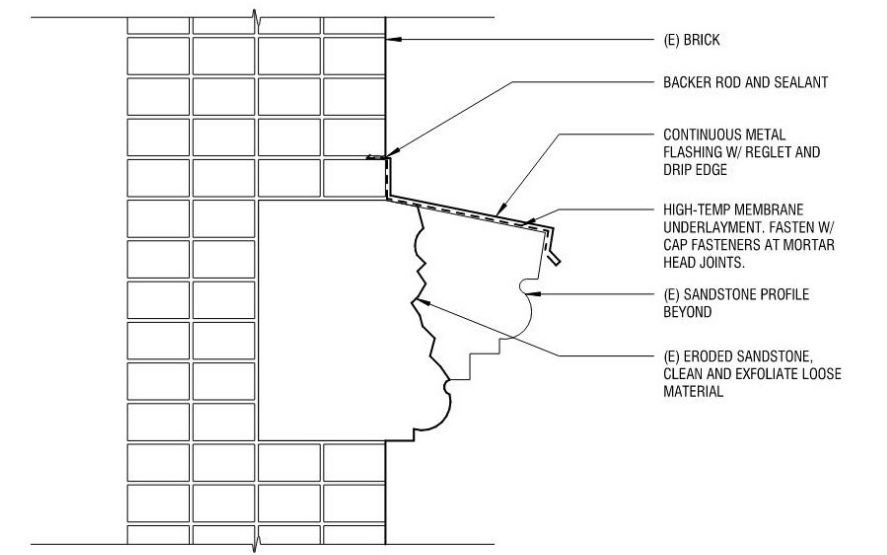

Sandstone Option 3 Flashing




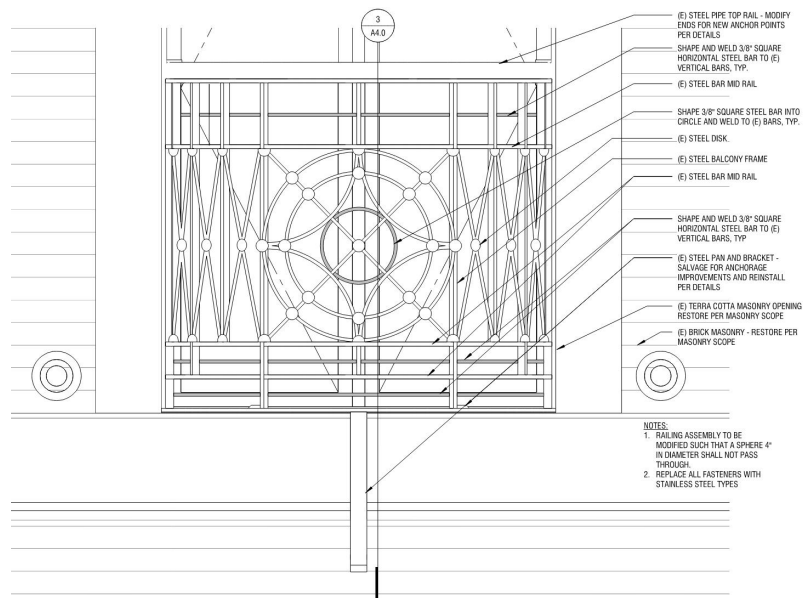SANDSTONE REPAIRS




- (E) STEEL PIPE TOP RAIL - MODIFY ENDS FOR NEW ANCHOR POINTS PER DETAILS
- SHAPE AND WELD 3/8\"/>
- (E) STEEL BAR MID RAIL
- SHAPE 3/8\"/>
- (E) STEEL DISK
- (E) STEEL BALCONY FRAME
- (E) STEEL BAR MID RAIL
- SHAPE AND WELD 3/8\"/>
- (E) STEEL PAN AND BRACKET - SALVAGE FOR ANCHORAGE IMPROVEMENTS AND REINSTALL PER DETAILS
- (E) TERRA COTTA MASONRY OPENING - RESTORE PER MASONRY SCOPE
- (E) BRICK MASONRY - RESTORE PER MASONRY SCOPE

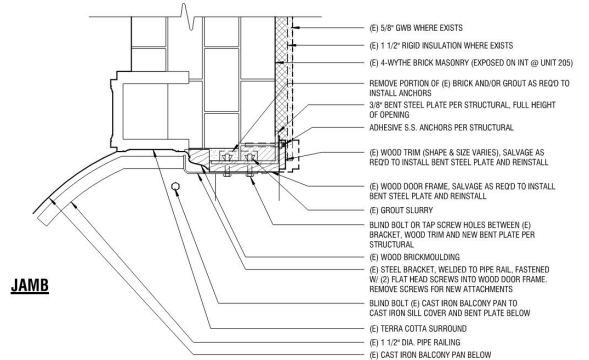NOTES:
 1. RAILING ASSEMBLY TO BE MODIFIED SUCH THAT A SPHERE 4\"/>



JAMB

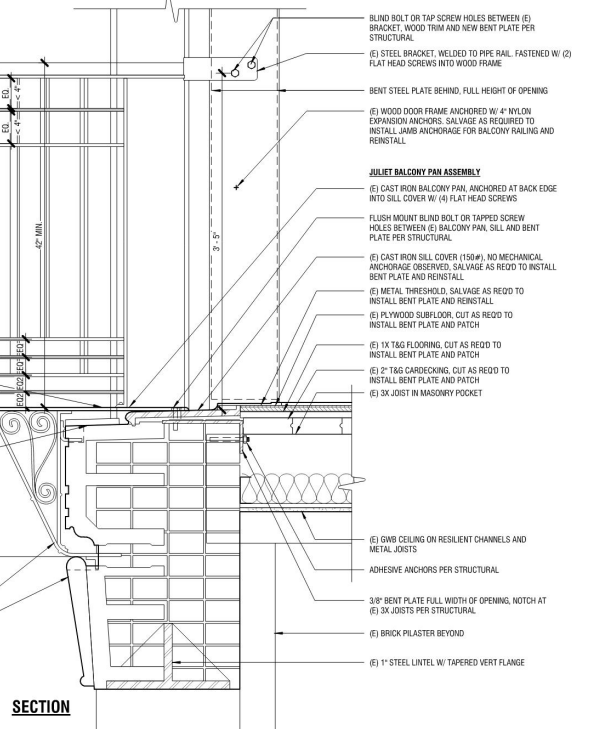

SECTION

- JULIET BALCONY RAILING ASSEMBLY**
- (E) STEEL PIPE TOP RAIL
- SHAPE AND WELD 3/8\"/>
- VERTICAL BARS, TYP.
- (E) STEEL BAR MID RAIL
- (E) STEEL BAR VERTICAL
- SHAPE 3/8\"/>
- VERTICAL BARS, TYP.
- (E) STEEL BAR MID RAIL
- SHAPE AND WELD 3/8\"/>
- VERTICAL BARS, TYP.
- (E) STEEL BAR BOTTOM RAIL
- JULIET BALCONY PAN ASSEMBLY**
- (E) IRON RAILING BOLT TO BALCONY PAN AT 4 LOCATIONS. SALVAGE AS REED FOR MODIFICATIONS, REPAIR, AND REINSTALL. PROVIDE STEEL SHIM UNDER RAILING FEET AS REED TO ENSURE 42\"/>
- (E) TERRA COTTA GREEK KEY BAND, CUT IN TO RECEIVE BRACKET BEARING PLATE. NOTE: TERRA COTTA UNITS ARE SLOTTED FULL W/ BRICK AND MORTAR
- (E) WROUGHT IRON BRACKET WITH RIVET CONNECTIONS. SALVAGE AS REED TO INSTALL SILL PAN BENT PLATE AND REINSTALL. SET UPPER AND LOWER BRACKET IN GROUT PER STRUCTURAL
- (E) TERRA COTTA KEystone (WHERE EXISTS), CUT IN TO RECEIVE BRACKET BEARING PLATES. (E) BRICK IS MODIFIED / PATCHED TO RECEIVE BRACKET TAIL

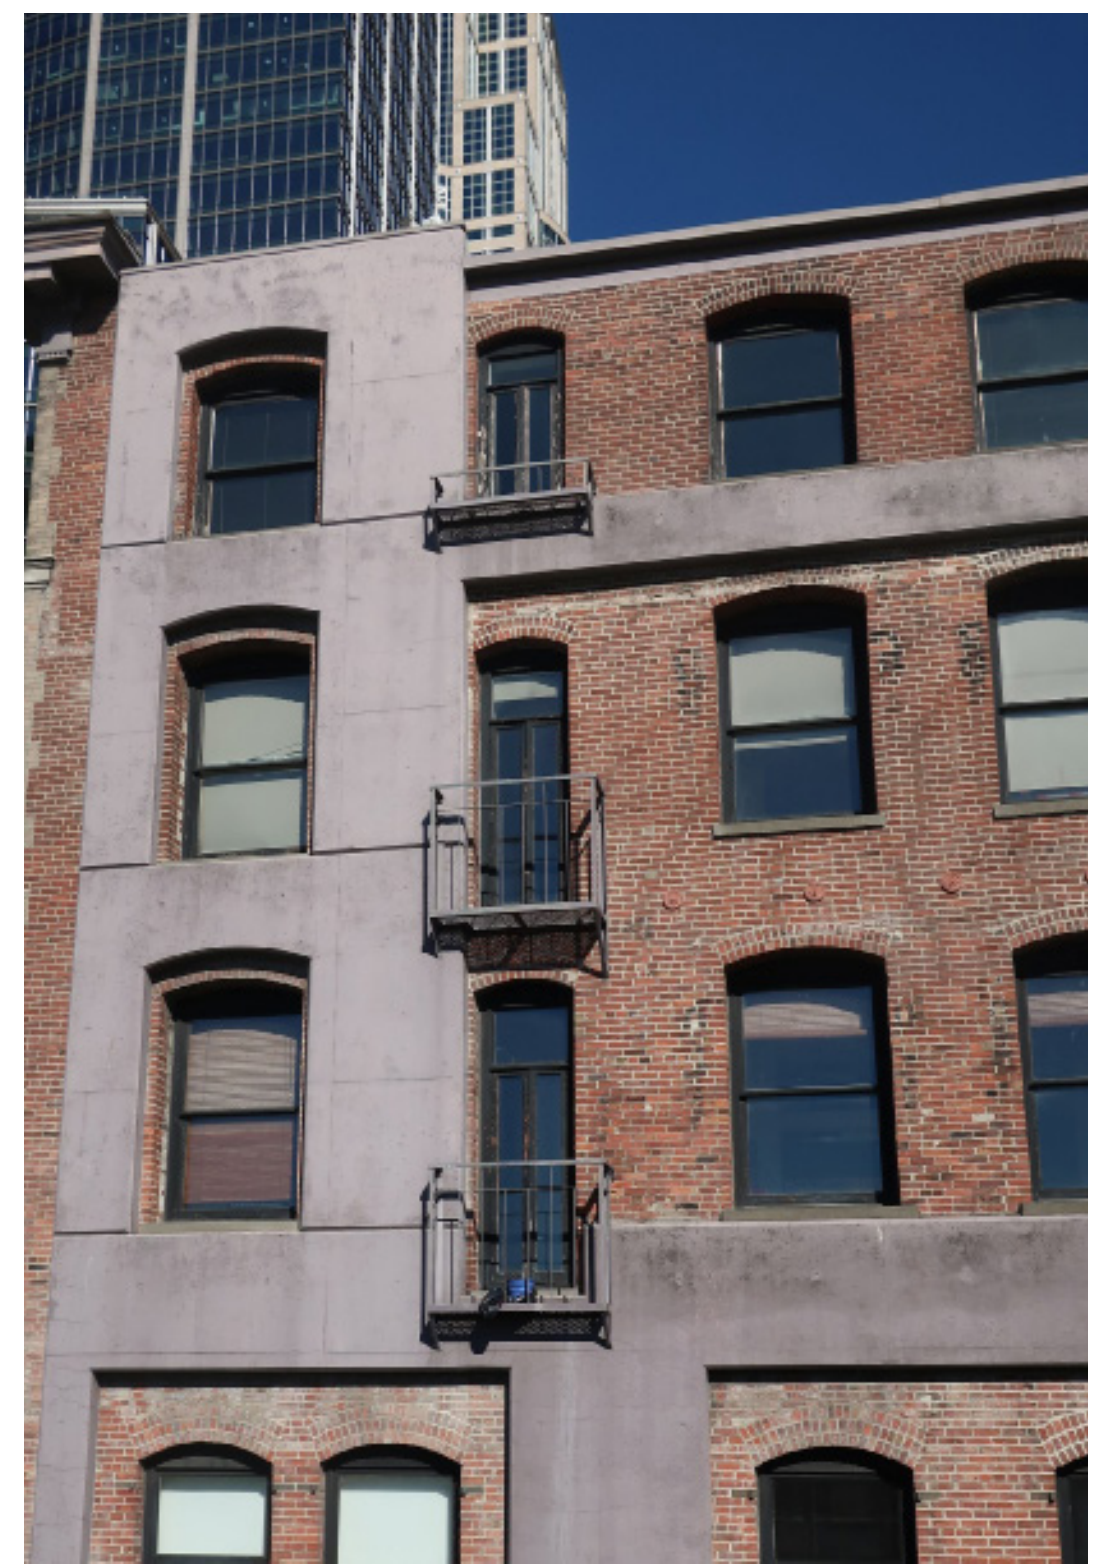
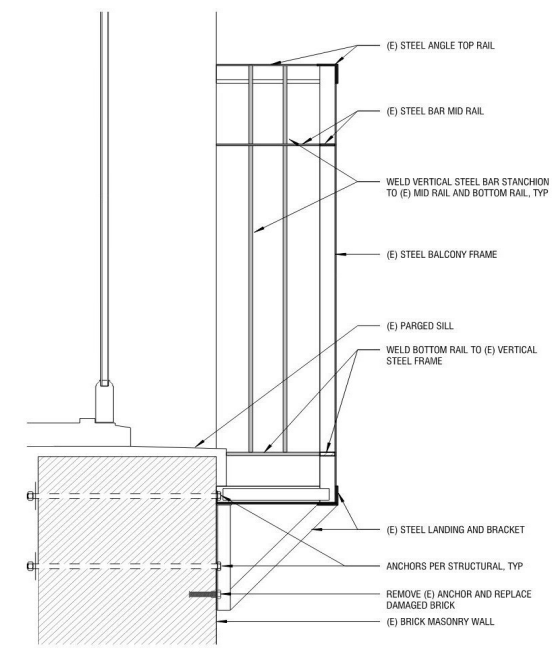
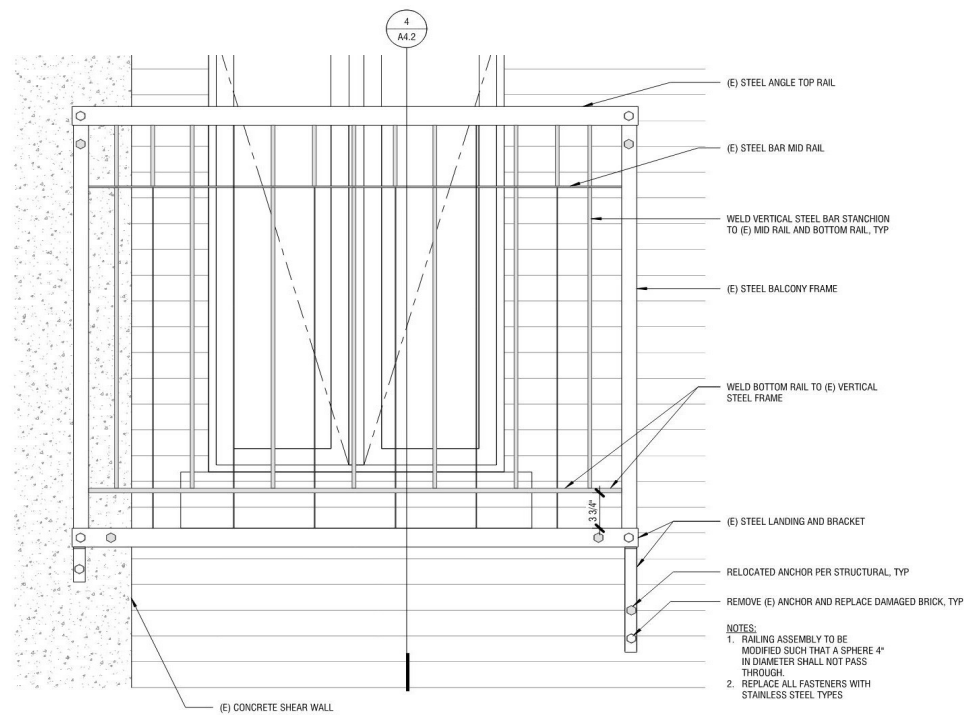
- (E) 5/8\"/>
- (E) 1 1/2\"/>
- (E) 4-WYTHE BRICK MASONRY (EXPOSED ON INT @ UNIT 205)
- REMOVE PORTION OF (E) BRICK AND/OR GROUT AS REED TO INSTALL ANCHORS
- 3/8\"/>
- ADHESIVE S.S. ANCHORS PER STRUCTURAL
- (E) WOOD TRIM (SHAPE & SIZE VARIES), SALVAGE AS REED TO INSTALL BENT STEEL PLATE AND REINSTALL
- (E) WOOD DOOR FRAME, SALVAGE AS REED TO INSTALL BENT STEEL PLATE AND REINSTALL
- (E) GROUT SURRY
- BLIND BOLT OR TAP SCREW HOLES BETWEEN (E) BRACKET, WOOD TRIM AND NEW BENT PLATE PER STRUCTURAL
- (E) WOOD BRICKMOLDING
- (E) STEEL BRACKET, WELDED TO PIPE RAIL, FASTENED W/ (C) FLAT HEAD SCREWS INTO WOOD DOOR FRAME. REMOVE SCREWS FOR NEW ATTACHMENTS
- BLIND BOLT (E) CAST IRON BALCONY PAN TO CAST IRON SILL COVER AND BENT PLATE BELOW
- (E) TERRA COTTA SURROUND
- (E) 1 1/2\"/>
- (E) CAST IRON BALCONY PAN BELOW
- BLIND BOLT OR TAP SCREW HOLES BETWEEN (E) BRACKET, WOOD TRIM AND NEW BENT PLATE PER STRUCTURAL
- (E) STEEL BRACKET, WELDED TO PIPE RAIL, FASTENED W/ (C) FLAT HEAD SCREWS INTO WOOD FRAME
- BENT STEEL PLATE BEHIND, FULL HEIGHT OF OPENING
- (E) WOOD DOOR FRAME ANCHORED W/ 4\"/>
- (E) CAST IRON BALCONY PAN, ANCHORED AT BACK EDGE INTO SILL COVER W/ (C) FLAT HEAD SCREWS
- FLUSH MOUNT BLIND BOLT OR TAPPED SCREW HOLES BETWEEN (E) BALCONY PAN, SILL AND BENT PLATE PER STRUCTURAL
- (E) CAST IRON SILL COVER (150#), NO MECHANICAL ANCHORAGE OBSERVED, SALVAGE AS REED TO INSTALL BENT PLATE AND REINSTALL
- (E) METAL THRESHOLD, SALVAGE AS REED TO INSTALL BENT PLATE AND REINSTALL
- (E) PLYWOOD SUBFLOOR, CUT AS REED TO INSTALL BENT PLATE AND PATCH
- (E) 1X T&G FLOORING, CUT AS REED TO INSTALL BENT PLATE AND PATCH
- (E) 2\"/>
- (E) 3X JOIST IN MASONRY POCKET
- (E) GWB CEILING ON RESILIENT CHANNELS AND METAL JOISTS
- ADHESIVE ANCHORS PER STRUCTURAL
- 3/8\"/>
- (E) BRICK PLASTER BEYOND
- (E) 1\"/>

Juliet Balcony - Elevation and Details



Juliet Balcony - East Facade


JULIET BALCONIES




West Balconies - Elevation and Details

Balconies - West Facade

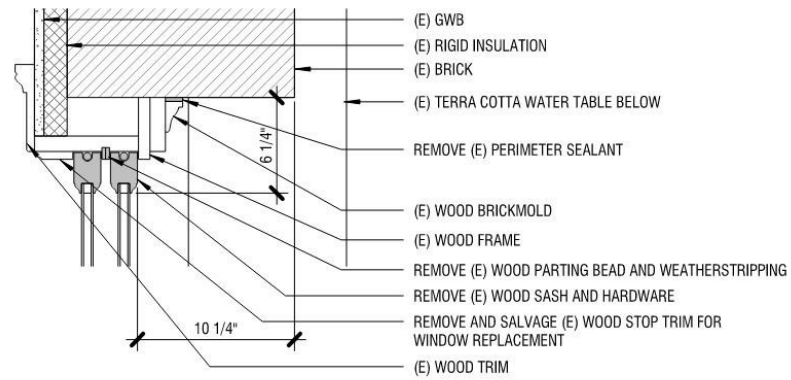
WEST BALCONIES




2 WINDOW TYPE D - DEMO JAMB DETAIL

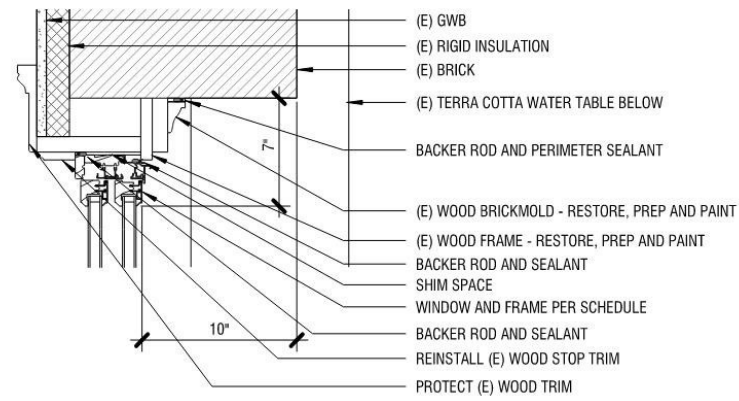

6 WINDOW TYPE D - JAMB DETAIL

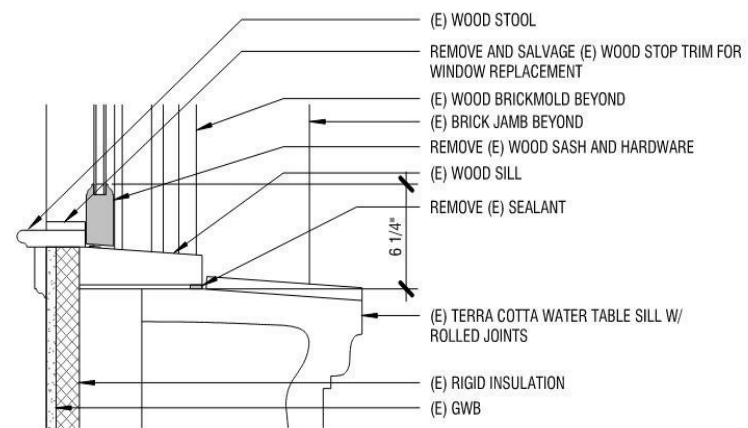

4 WINDOW TYPE D - DEMO SILL DETAIL

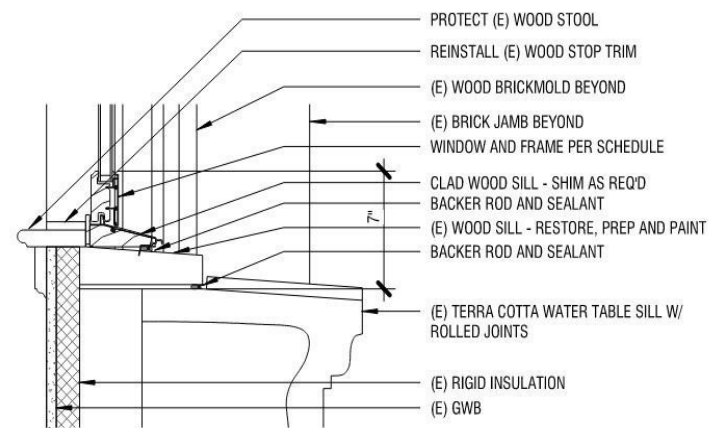


8 WINDOW TYPE D - SILL DETAIL



Double-Hung Window Details - Demo


Double-Hung Window Details - Replacement

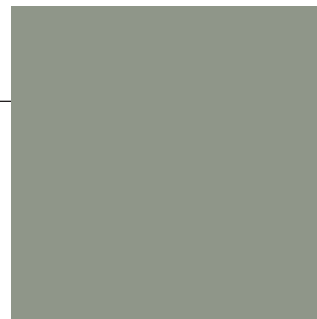Double-Hung Window Type D - East Facade



Existing Frame / Trim (Match)
Sherwin Williams SW6164 Svelte Sage

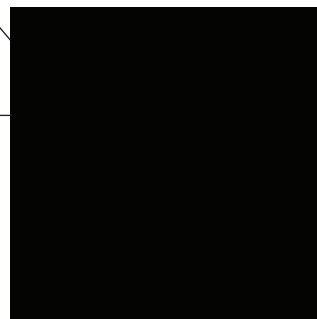
Color shown is for design intent only. Final selection to be determined from on-site mockups during construction and submitted to Landmarks for approval.




Existing Sash (Match)
Sherwin Williams SW6994 Greenblack

Color shown is for design intent only. Final selection to be determined from on-site mockups during construction and submitted to Landmarks for approval.

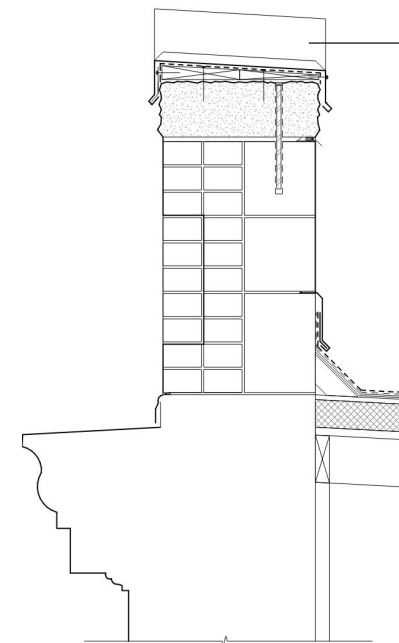Window Trim and Sash Finishes , East (Top) and West (Bottom)



Grand Pacific Flashing at Coping

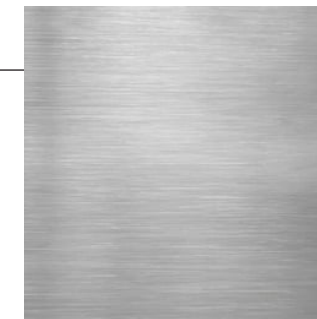


Stainless Steel Flashing

Color shown is for design intent only. Final selection to be determined from on-site mockups during construction and submitted to Landmarks for approval.



Existing Balcony (Unknown)

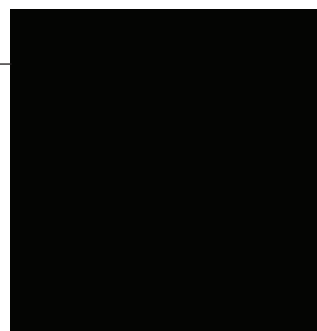The product information for the existing balcony (purple) is unknown. Based on historic photos (far left), the design intent is to propose a similar color, which appears to be black.



Proposed Balcony Color
Sherwin Williams SW6994 Greenblack

Color shown is for design intent only. Final selection to be determined from on-site mockups during construction and submitted to Landmarks for approval.

Balcony Finishes



Concrete Shear Wall



Existing Concrete (Unknown)

The product information for the existing concrete (purple) is unknown. The design intent is to propose a neutral color that is less susceptible to color fading due to UV radiation.



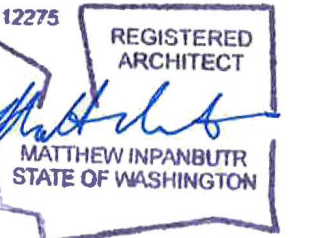
Proposed Balcony Color
Sherwin Williams SW7045 Intellectual Gray

Color shown is for design intent only. Final selection to be determined from on-site mockups during construction and submitted to Landmarks for approval.

FINISHES

COLONIAL GRAND PACIFIC FACADE REPAIRS


1050 N. 38th St.
Seattle, WA 98103
PH: 206.675.9151
www.shksarchitects.com



ABBREVIATIONS

| | | |
|---|--------------------------------------|--------------------------------------|
| & L AND | GA GAUGE | R or RAD RADIUS |
| @ ANGLE | GB GALVANIZED | RB RESILIENT BASE |
| # AT | GB GRAB BAR | RC REFLECTED CEILING PLAN |
| □ DIAMETER | GC GENERAL CONTRACTOR | RD ROOF DRAIN |
| # POUND OR NUMBER | GL GLASS | REF REFERENCE |
| (E) EXISTING | GLB GLU-LAM BEAM | REFR REFRIGERATOR |
| ⊕ CENTERLINE | GND GROUND | REINF REINFORCED |
| ⊖ PROPERTY LINE | GR GRADE | RELOC RELOCATE |
| | GRTD GROUDED | REQ'D REQUIRED |
| | GWB GYPSUM WALL BOARD | RES RESILIENT |
| A.B. ANCHOR BOLT | | RM ROOM |
| ABV ABOVE | | RO ROUGH OPENING |
| AC AIR CONDITIONING | HB HOSE BIBB | RV ROOF VENT |
| ACP ACOUSTIC CEILING PANEL | HC HANDICAP | RL RAIN WATER LEADER |
| ADU AIR CONDITION UNIT | HCMU HOLLOW CLAY MASONRY UNIT | |
| ADJ ADJUSTABLE | HDWD HARDWOOD | S SOUTH |
| AF ABOVE FINISHED FLOOR | HDWE HARDWARE | SA SMOKE ALARM |
| ALT ALTERNATE | HT HEIGHT | SAF SELF-ADHERED MEMBRANE |
| ALUM ALUMINUM | HM HOLLOW METAL | SC SOLID CORE |
| APPROX APPROXIMATELY | HR HOUR | SCHED SCHEDULE |
| ARCH ARCHITECT, ARCHITECTURAL | HORIZ HORIZONTAL | SECT SECTION |
| | | SG SAFETY GLASS |
| BLDG BUILDING | I.D. INSIDE DIAMETER | SHT SHEET |
| BLW BELOW | INSUL INSULATION | SIM SIMILAR |
| BM BEAM | INT INTERIOR | SPEC SPECIFICATION |
| B.O. BOTTOM OF | | SQ SQUARE |
| BRS BACKER ROD & SEALANT | JAN JANITOR | S.S. STAINLESS STEEL |
| | JT JOINT | STA STATION |
| | | STD STANDARD |
| CB CATCH BASIN | KIT KITCHEN | STL STEEL |
| CBB CEMENT BACKER BOARD | | STR STAIN |
| CBM CEMENT | | STRG STORAGE |
| CJ CONTROL JOINT | | STRUCT STRUCTURE |
| CL CENTERLINE | LAB LABORATORY | SLAB SLAB ON GRADE |
| CLG CEILING | LAM LAMINATE | SUSP SUSPENDED |
| CLR CLEAR | LAV LAVATORY | SYM SYMMETRICAL |
| CO CLEAN OUT | LKR LOCKER | |
| COL COLUMN | LOC LOCATE | T, TMP TEMPERED |
| CONC CONCRETE | LT LIGHT | T&G TONGUE & GROOVE |
| COND CONDITION | LVL LAMINATED VENEER LUMBER | TEL TELEPHONE |
| CONT CONTINUOUS | | TER TERRAZZO |
| CPT CARPET | M MEN'S | THK THICK |
| CT CERAMIC TILE | MATL MATERIAL | T.O. TOP OF |
| CTR CENTER | MAX MAXIMUM | TS TUBE STEEL |
| | MC MEDICINE CABINET | TV TELEVISION |
| | MECH MECHANICAL | TYP TYPICAL |
| DBL DOUBLE | MEMB MEMBRANE | |
| DEMO DEMOLISH | MFR MANUFACTURER | UL UNDERWRITERS' LABORATORIES |
| DF DRINKING FOUNTAIN | MIN MINIMUM | UNO UNLESS NOTED OTHERWISE |
| DIA DIAMETER | MIR MIRROR | UTIL UTILITY |
| DIFF DIFFUSER | MISC MISCELLANEOUS | |
| DIM DIMENSION | MH MANHOLE | VCT VINYL COMPOSITION TILE |
| DISP DISPENSER | MO MASONRY OPENING | VERT VERTICAL |
| DN DOWN | MTD MOUNTED | VEST VESTIBULE |
| DR DOOR | MTL METAL | VIF VERIFY IN FIELD |
| DS DOWNSPOUT | MULL MULLION | VTR VENT THRU ROOF |
| DTL DETAIL | | |
| DW DISHWASHER | | |
| | N NORTH | W WEST |
| E EAST | NA NOT APPLICABLE | WITH WITH |
| EA EACH | NIC NOT IN CONTRACT | WC WATER CLOSET |
| ECS EXTERIOR COMPOSITE SIDING | NOM NOMINAL | WD WOOD |
| EF EXHAUST FAN | NTS NOT TO SCALE | WF WIDE FLANGE |
| EJ EXPANSION JOINT | NR NOT RATED | WITHOUT WITHOUT |
| EL ELEVATION | | WOM WALK OFF MAT |
| ELEC ELECTRICAL | OA OVERALL | WP WATERPROOFING |
| ELEV ELEVATOR | OB OBSCURE | WR WATER RESISTANT |
| EMERG EMERGENCY | O.C. ON CENTER | WRB WATER-RESISTIVE BARRIER |
| EQ EQUAL | O.D. OUTSIDE DIAMETER | WCSOT WAINGSCOT |
| EXP EXPANSION | OFF OFFICE | WT WEIGHT |
| EXT EXTERIOR | OPNG OPENING | |
| | OPP OPPOSITE | |
| FBP FIBER BOARD PANEL | | |
| FD FLOOR DRAIN | PC PRECAST CONCRETE | |
| FE FIRE EXTINGUISHER | PL PLATE | |
| FF FINISH FLOOR | PLAS PLASTER | |
| FH FIRE HYDRANT | PLY PLYWOOD | |
| FIN FINISH | P.LAM PLASTIC LAMINATE | |
| FLR FLOOR | PNT PAINT | |
| F.O. FACE OF | PNC POINT OF CONNECTION | |
| FOIC FURNISHED BY OWNER, INSTALL BY CONTRACTOR | PR PAIR | |
| | PSL PARALLEL STRAND LUMBER | |
| FOIO FURNISHED BY OWNER, INSTALL BY OWNER | PT PRESSURE TREATED | |
| FR FIRE RESISTANT | PTN PARTITION | |
| FS FLOOR SINK | QT QUARRY TILE | |
| FT FEET | | |

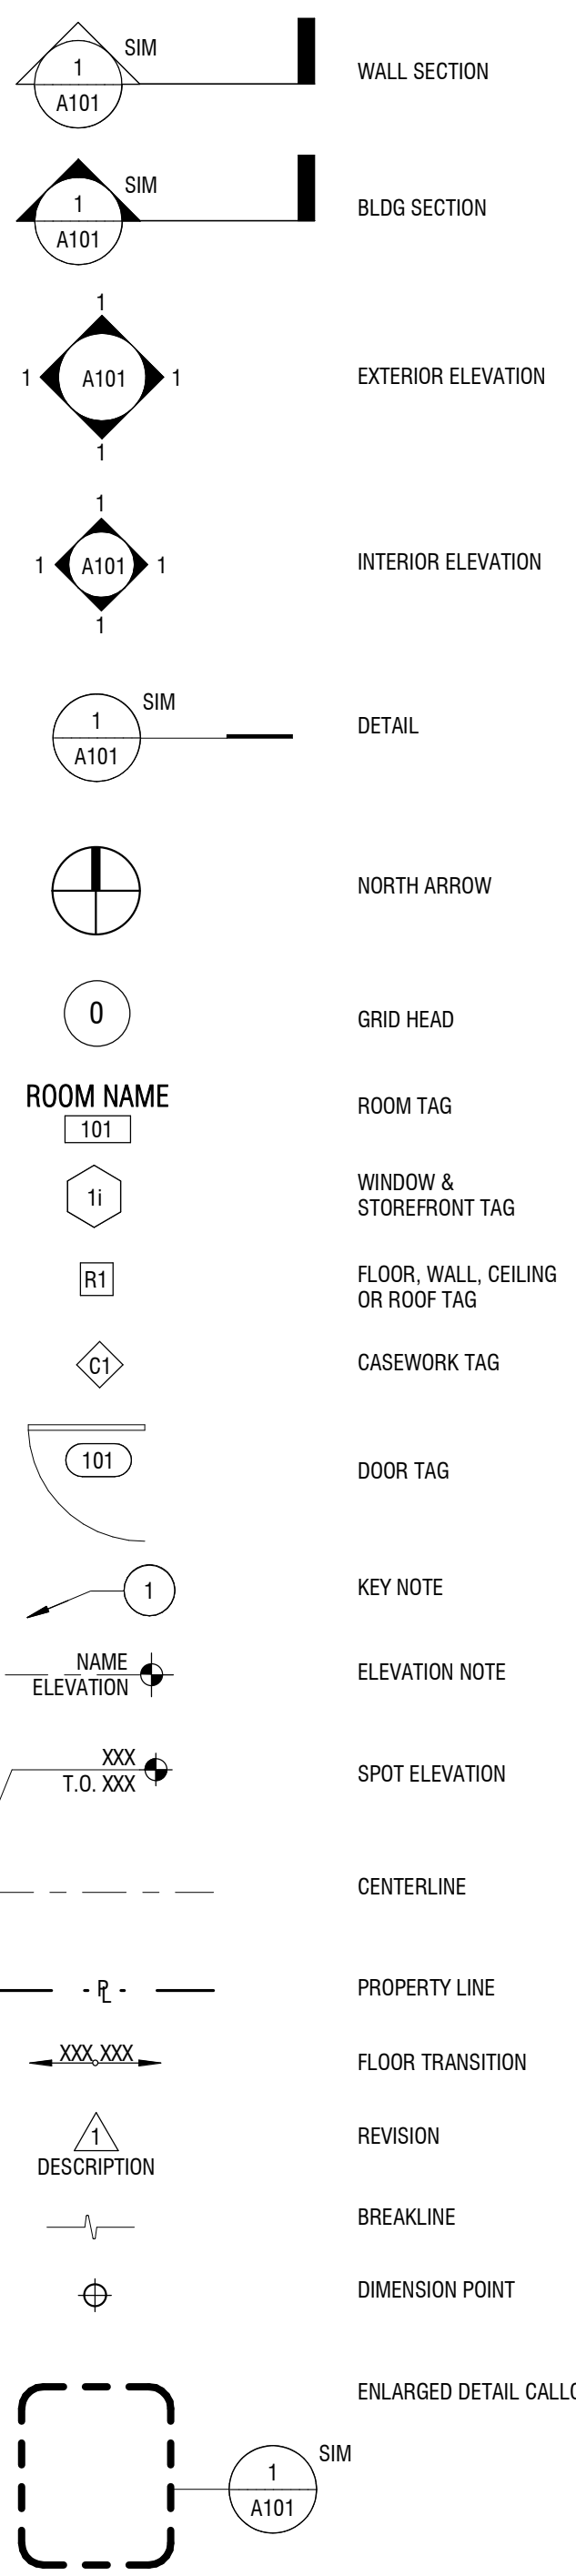DRAFTING SYMBOLS



GENERAL NOTES

- THE BUILDING IS LISTED ON THE NATIONAL REGISTER OF HISTORIC PLACES, AND IS A CITY OF SEATTLE LANDMARK. ALL WORK SHALL COMPLY WITH THE SECRETARY OF THE INTERIORS STANDARDS FOR THE TREATMENT OF HISTORIC PROPERTIES AND GUIDELINES FOR REHABILITATION.
- REFER TO STRUCTURAL DRAWINGS FOR ADDITIONAL NOTES AND SYMBOLS.
- MATERIALS, ASSEMBLIES AND NOTED ITEMS ARE NEW UNLESS OTHERWISE NOTED.
- CONTRACTOR SHALL VERIFY CONDITIONS. NOTIFY THE ARCHITECT OF ANY CONDITIONS INCONSISTENT WITH THE INTENT OF THE DRAWINGS PRIOR TO STARTING OR CONTINUING WORK IN THE AREA CONCERNED.

CODE:

- ALL WORK SHALL CONFORM TO APPLICABLE CODES AND LOCAL BUILDING REQUIREMENTS, WHICH INCLUDE THE MOST CURRENT EDITIONS OF THE INTERNATIONAL BUILDING CODE WITH LOCAL AMENDMENTS, INTERNATIONAL MECHANICAL CODE (IMC), NATIONAL ELECTRICAL CODE (NEC), INTERNATIONAL FIRE CODE (IFC), AND WASHINGTON STATE ENERGY CODE (WEC). REFER TO WINDOW SCHEDULE FOR WINDOW SIZES AND TYPES. ALL GLAZING WITHIN 18" OF INTERIOR FLOOR, EXTERIOR WALKING SURFACE OR WITHIN 24" OF A DOOR IN ANY POSITION TO BE TEMPERED GLASS UNLESS INDICATED OTHERWISE.
- PROVIDE FIREBLOCKS AND DRAFTSTOPS PER IBC.
- PROVIDE CLOSURE MEETING THE REQUIREMENT OF GOVERNING FIRE AUTHORITIES BETWEEN FIRE RATED FLOORS, SHAFTS AND BUILDING PARTITIONS AND PENETRATING DUCTS, PIPES, CONDUIT, MECHANICAL, ELECTRICAL, AND OTHER ITEMS.
- RECESSES LOCATED WITHIN FIRE RATED PARTITIONS SHALL BE CONSTRUCTED TO MAINTAIN THE REQUIRED FIRE RATING OF THE PARTITION.
- EXISTING FIRE EXTINGUISHERS AND CABINETS ARE NOT SHOWN ON PLANS. PROTECT EXISTING FIRE EXTINGUISHERS AND CABINETS (RECESSED OR SURFACE MOUNTED) FROM DAMAGE.

HAZMAT:

- HAZARDOUS MATERIAL REMOVAL & DISPOSAL: BEFORE BEGINNING ANY DEMOLITION OR OTHER WORK, COMPLY WITH DOCUMENTS PREPARED BY THE OWNER'S HAZARDOUS MATERIALS CONSULTANT. THIS APPLIES TO DEMOLITION, DISPOSAL AND CONSTRUCTION OPERATIONS ASSOCIATED WITH THE PROJECT. THE CONTRACTOR WILL SUSPEND WORK IMMEDIATELY AND NOTIFY THE OWNER IF MATERIALS SUSPECTED OF BEING HAZARDOUS, AND NOT PREVIOUSLY IDENTIFIED, ARE ENCOUNTERED IN THE COURSE OF THE CONTRACTOR'S WORK.

DEMOLITION:

- WHERE ITEMS ARE INDICATED ON PLANS TO BE DEMOLISHED, IT SHALL MEAN THE COMPLETE REMOVAL AND DISPOSAL OF THE ITEM INDICATED UNLESS OTHERWISE NOTED. CONTRACTOR IS RESPONSIBLE FOR REVIEW OF THE HAZARDOUS MATERIALS ABATEMENT, ARCHITECTURAL AND STRUCTURAL DRAWINGS AND SPECIFICATIONS FOR CUTTING AND PATCHING WORK.

DIMENSIONS:

- DO NOT SCALE DRAWINGS.
- VERIFY DIMENSIONS SHOWN ON DRAWINGS. USE ONLY DIMENSIONS INDICATED. PRIOR TO STARTING OR CONTINUING WORK, NOTIFY ARCHITECT OF DISCREPANCIES OR CONDITIONS INCONSISTENT WITH THE INTENT OF THE CONSTRUCTION DOCUMENTS.
- DIMENSIONS ARE TO FACE OF CONCRETE, FACE OF MASONRY, OR FACE OF STUD, UNLESS OTHERWISE NOTED.
- FINISHED SURFACE OF INFILL OR EXTENSIONS OF EXISTING PARTITIONS SHALL ALIGN WITH ADJACENT EXISTING SURFACES UNLESS OTHERWISE NOTED.
- VERTICAL DIMENSIONS ARE MEASURED FROM STRUCTURAL SLAB, TOP OF STEEL OR TOP OF SHEATHING, UNLESS NOTED OTHERWISE.
- DOORS NOT LOCATED BY DIMENSION ON PLANS SHALL BE SIX INCHES FROM FACE OF ADJOINING PARTITION TO HINGE EDGE OF DOOR OPENING. PROVIDE MINIMUM 18" CLEAR FROM FACE OF ADJOINING PARTITION OR OTHER OBSTRUCTION TO JAMB EDGE OF DOOR OPENING, UNLESS OTHERWISE NOTED. NOTIFY ARCHITECT IF REQUIRED CLEARANCES ARE NOT AVAILABLE.
- WINDOWS ARE DIMENSIONED TO CENTERLINE OF OPENING WITHIN FRAMED WALLS AND TO MASONRY OPENING WITHIN MASONRY WALLS, UNLESS OTHERWISE NOTED.

COORDINATION:

- COORDINATE ALL OPERATIONS WITH OWNER, SUCH AS AREAS USED FOR MATERIAL STORAGE, ACCESS TO AND FROM THE SITE, TIMING OF WORK AND REQUIREMENTS OF NOISE ORDINANCE. INSTALL DUST AND NOISE BARRIERS AS REQUIRED TO PROTECT EXISTING ADJACENT BUILDINGS AND OCCUPANTS AND TO MAINTAIN AN ENVIRONMENT SUITABLE TO PERMIT CONTINUED OCCUPANCY OF SUBJECT AND ADJACENT BUILDINGS.
- REVIEW DEMOLITION DRAWINGS. PATCH AND REPAIR ALL EXISTING SURFACES AFFECTED BY DEMOLITION WORK.
- VERIFY LOCATIONS OF EXISTING UTILITIES. CAP, MARK AND PROTECT AS NECESSARY TO COMPLETE THE WORK.
- REVIEW ARCHITECTURAL AND STRUCTURAL DRAWINGS AND PROVIDE ROUGH-INS THROUGH SLABS, BEAMS, WALLS, CEILINGS, AND ROOFS FOR AS INDICATED OR REQUIRED. VERIFY SIZE AND LOCATION BEFORE PROCEEDING WITH WORK. COORDINATE WITH INSTALLATION REQUIREMENTS. PATCH AND REPAIR EXISTING SURFACES AS NECESSARY TO COMPLETE WORK.
- COORDINATE AND PROVIDE REQUIRED PENETRATIONS AND PATCHING WITH INDIVIDUAL SUBCONTRACTORS TO SUIT NEW WORK.
- "REMOVE" MEANS TO COMPLETELY AND PERMANENTLY REMOVE FROM THE PROJECT.



PROJECT INFORMATION

SDCI PROJECT NUMBER
6802621-CN

SEATTLE LANDMARKS ORDINANCE
111058

PROJECT OWNER:
THE COLONIAL GRAND PACIFIC OWNERS ASSOCIATION
D/B/A COLONIAL GRAND PACIFIC CONDOS
1119 1ST AVENUE, SEATTLE, WA 98101
DOUGLAS STROUD, BOARD PRESIDENT
PATRICK GUILFOY, BOARD TREASURER

PROJECT MANAGER:
KELSEY BLOMMER
OAC SERVICES
2200 1ST AVE S #200
SEATTLE, WA 98134
TEL: 206.601.0583
EMAIL: KBLOMMER@OACSVCS.COM

PROJECT ADDRESS:
1119 1st AVENUE
SEATTLE, WA 98101

SCOPE DESCRIPTION:

- REPLACEMENT OF NON-ORIGINAL EXTERIOR WINDOWS
- CLEANING, REPAIR AND REPOINTING OF EXTERIOR MASONRY
- LIFE SAFETY MODIFICATIONS TO EXISTING BALCONY RAILINGS

DESIGN TEAM

ARCHITECT:
SHKS ARCHITECTS
1050 NORTH 38TH ST
SEATTLE, WA 98103
TEL: 206.224.3328
CONTACT: Matt Hamel
EMAIL: matt@shksarchitects.com

STRUCTURAL ENGINEER:
KPF
1601 FIFTH AVENUE, SUITE 1600
SEATTLE, WA 98101
TEL: 206.622.5822
CONTACT: Jason Black
EMAIL: jason.black@kpf.com

ENVELOPE CONSULTANT:
WETHERHOLT AND ASSOCIATES
14715 NE 95TH STREET, SUITE 100
REDMOND, WA 98052
TEL: 425.822.8397
CONTACT: Don Davis
EMAIL: dond@wetherholt.com

ZONING ANALYSIS

- PROJECT ADDRESS:**
1119 1ST AVE SEATTLE, WA 98101
- PARCEL NUMBER**
169750-0000
- LEGAL DESCRIPTION:**
THE COLONIAL GRAND PACIFIC, A CONDOMINIUM (VOL 108, PGS 41-49)
- LOT AREA:**
16,771 SF
- ZONE:**
DMC 240/290-440 - NO CHANGE
- CURRENT USE:**
CONDOMINIUM (MIXED USE) - NO CHANGE
- YEAR BUILT:**
1902
- (E) BLDG AREA:**
13,035 SF (NO CHANGE)
- (E) LOT COVERAGE:**
77% (NO CHANGE)
- HT LIMIT:** NO CHANGE
- PARKING QUANTITY:** NO CHANGE
- REQUIRED SETBACKS:** NO CHANGE

SHEET INDEX

| | |
|-------|--|
| A0.0 | COVER SHEET |
| A1.0 | SITE PLAN |
| A2.1 | BASEMENT PLAN |
| A2.2 | POST AVENUE PLAN |
| A2.3 | MEZZANINE FLOOR PLAN |
| A2.4 | COLONIAL COMMERCIAL FLOOR PLAN |
| A2.5 | FIRST FLOOR PLAN - FIRST AVENUE |
| A2.6 | SECOND FLOOR PLAN |
| A2.7 | THIRD FLOOR PLAN |
| A2.8 | FOURTH FLOOR PLAN |
| A2.9 | ROOF PLAN |
| A2.10 | SCHEDULES |
| A2.11 | WINDOW TYPES |
| A3.0 | EAST ELEVATION (FIRST AVENUE) |
| A3.1 | NORTH ELEVATION (SENECA STREET) |
| A3.2 | WEST ELEVATION (POST AVENUE) |
| A4.0 | BALCONY TYPE 1A DETAILS |
| A4.1 | BALCONY TYPE 2A DETAILS |
| A4.2 | BALCONY TYPE 3 DETAILS |
| A4.3 | BALCONY TYPE 4 DETAILS |
| A4.6 | MASONRY & PARAPET DETAILS |
| A5.0 | WINDOW DETAILS |
| S0.0 | STRUCTURAL NOTES AND DRAWING LIST (IBC 2015) |
| S0.1 | STATEMENT OF SPECIAL INSPECTIONS (IBC 2015) |
| S4.0 | BALCONY DETAILS |
| S4.1 | BALCONY DETAILS |
| S4.2 | BALCONY DETAILS |

THE COLONIAL GRAND PACIFIC

FACADE REPAIRS

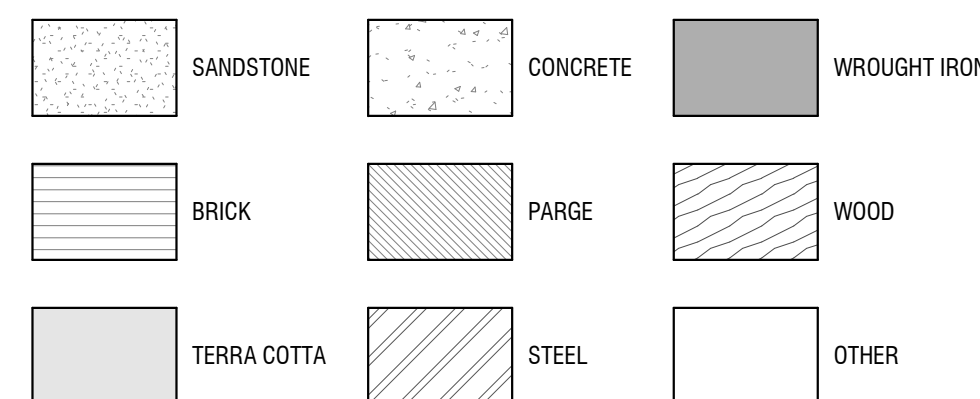
PERMIT SET

1119 1ST AVE, SEATTLE, WA 98101

Drawn by: _____ TD
Checked: _____ MH
Date: _____ 2/16/2021
Scale: _____ As indicated

Revisions:
No. Date Remarks

MATERIAL SYMBOLS




APPLICABLE CODES

- 2015 INTERNATIONAL BUILDING CODE
- 2015 INTERNATIONAL FIRE CODE
- 2010 ADA STANDARDS FOR ACCESSIBLE DESIGN
- 2015 WASHINGTON STATE ENERGY CODE
- 2015 SEATTLE EXISTING BUILDING CODE

DCI APPROVAL STAMPS

NOT FOR CONSTRUCTION

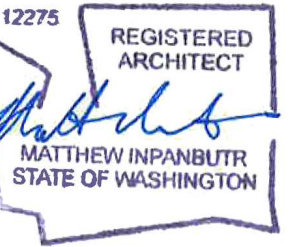COVER SHEET
A0.0



PROJECT INFORMATION

PROJECT OWNER:
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D/B/A COLONIAL GRAND PACIFIC CONDOS
DOUGLAS STROUD, BOARD PRESIDENT
1119 1ST AVENUE, SEATTLE, WA 98101

PROJECT MANAGER:
OAC SERVICES
2200 1ST AVE S #200
SEATTLE, WA 98134
CONTACT: Kelsey Blommer
TEL: 206.601.0583
EMAIL: kblommer@oacsvcs.com

DESIGN TEAM:
SHKS ARCHITECTS
1050 NORTH 38TH ST
SEATTLE, WA 98103
TEL: 206.224.3328
CONTACT: Matt Hamel
EMAIL: math@shksarchitects.com

PROJECT ADDRESS:
1119 1ST AVE
SEATTLE, WA 98101

SCOPE DESCRIPTION:
REPLACEMENT OF EXTERIOR WINDOWS, REPAIR/REPOINTING
OF EXTERIOR MASONRY, AND CODE COMPLIANCE
MODIFICATION OF EXISTING BALCONY RAILINGS

ZONING ANALYSIS

- PROJECT ADDRESS:**
1119 1ST AVE, SEATTLE, WA 98101
- PARCEL NUMBER:**
#169750-0000
- LEGAL DESCRIPTION:**
THE COLONIAL GRAND PACIFIC, A CONDOMINIUM
(VOL. 108, PGS 41-49)
- LOT AREA:**
16,771 SF
- ZONE:**
DMC 240/290-440 - NO CHANGE
LANDMARK
- CURRENT USE:**
CONDOMINIUM & RETAIL (MIXED USE)
EXTERIOR REPAIRS ONLY; NO CHANGE
- YEAR BUILT:**
1902
- (E) BLDG AREA:**
13,035 SF
EXTERIOR REPAIRS ONLY; NO CHANGE
- (E) LOT COVERAGE:**
77%
EXTERIOR REPAIRS ONLY; NO CHANGE
- HT LIMIT:**
EXTERIOR REPAIRS ONLY; NO CHANGE
- PARKING QUANTITY:**
EXTERIOR REPAIRS ONLY; NO CHANGE

THE COLONIAL
GRAND PACIFIC

FACADE
REPAIRS

PERMIT SET


1119 1ST AVE, SEATTLE, WA 98101

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| Checked: | MH | |
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| Scale: | 1" = 10'-0" | |
| Revisions: | | |
| No. | Date | Remarks |

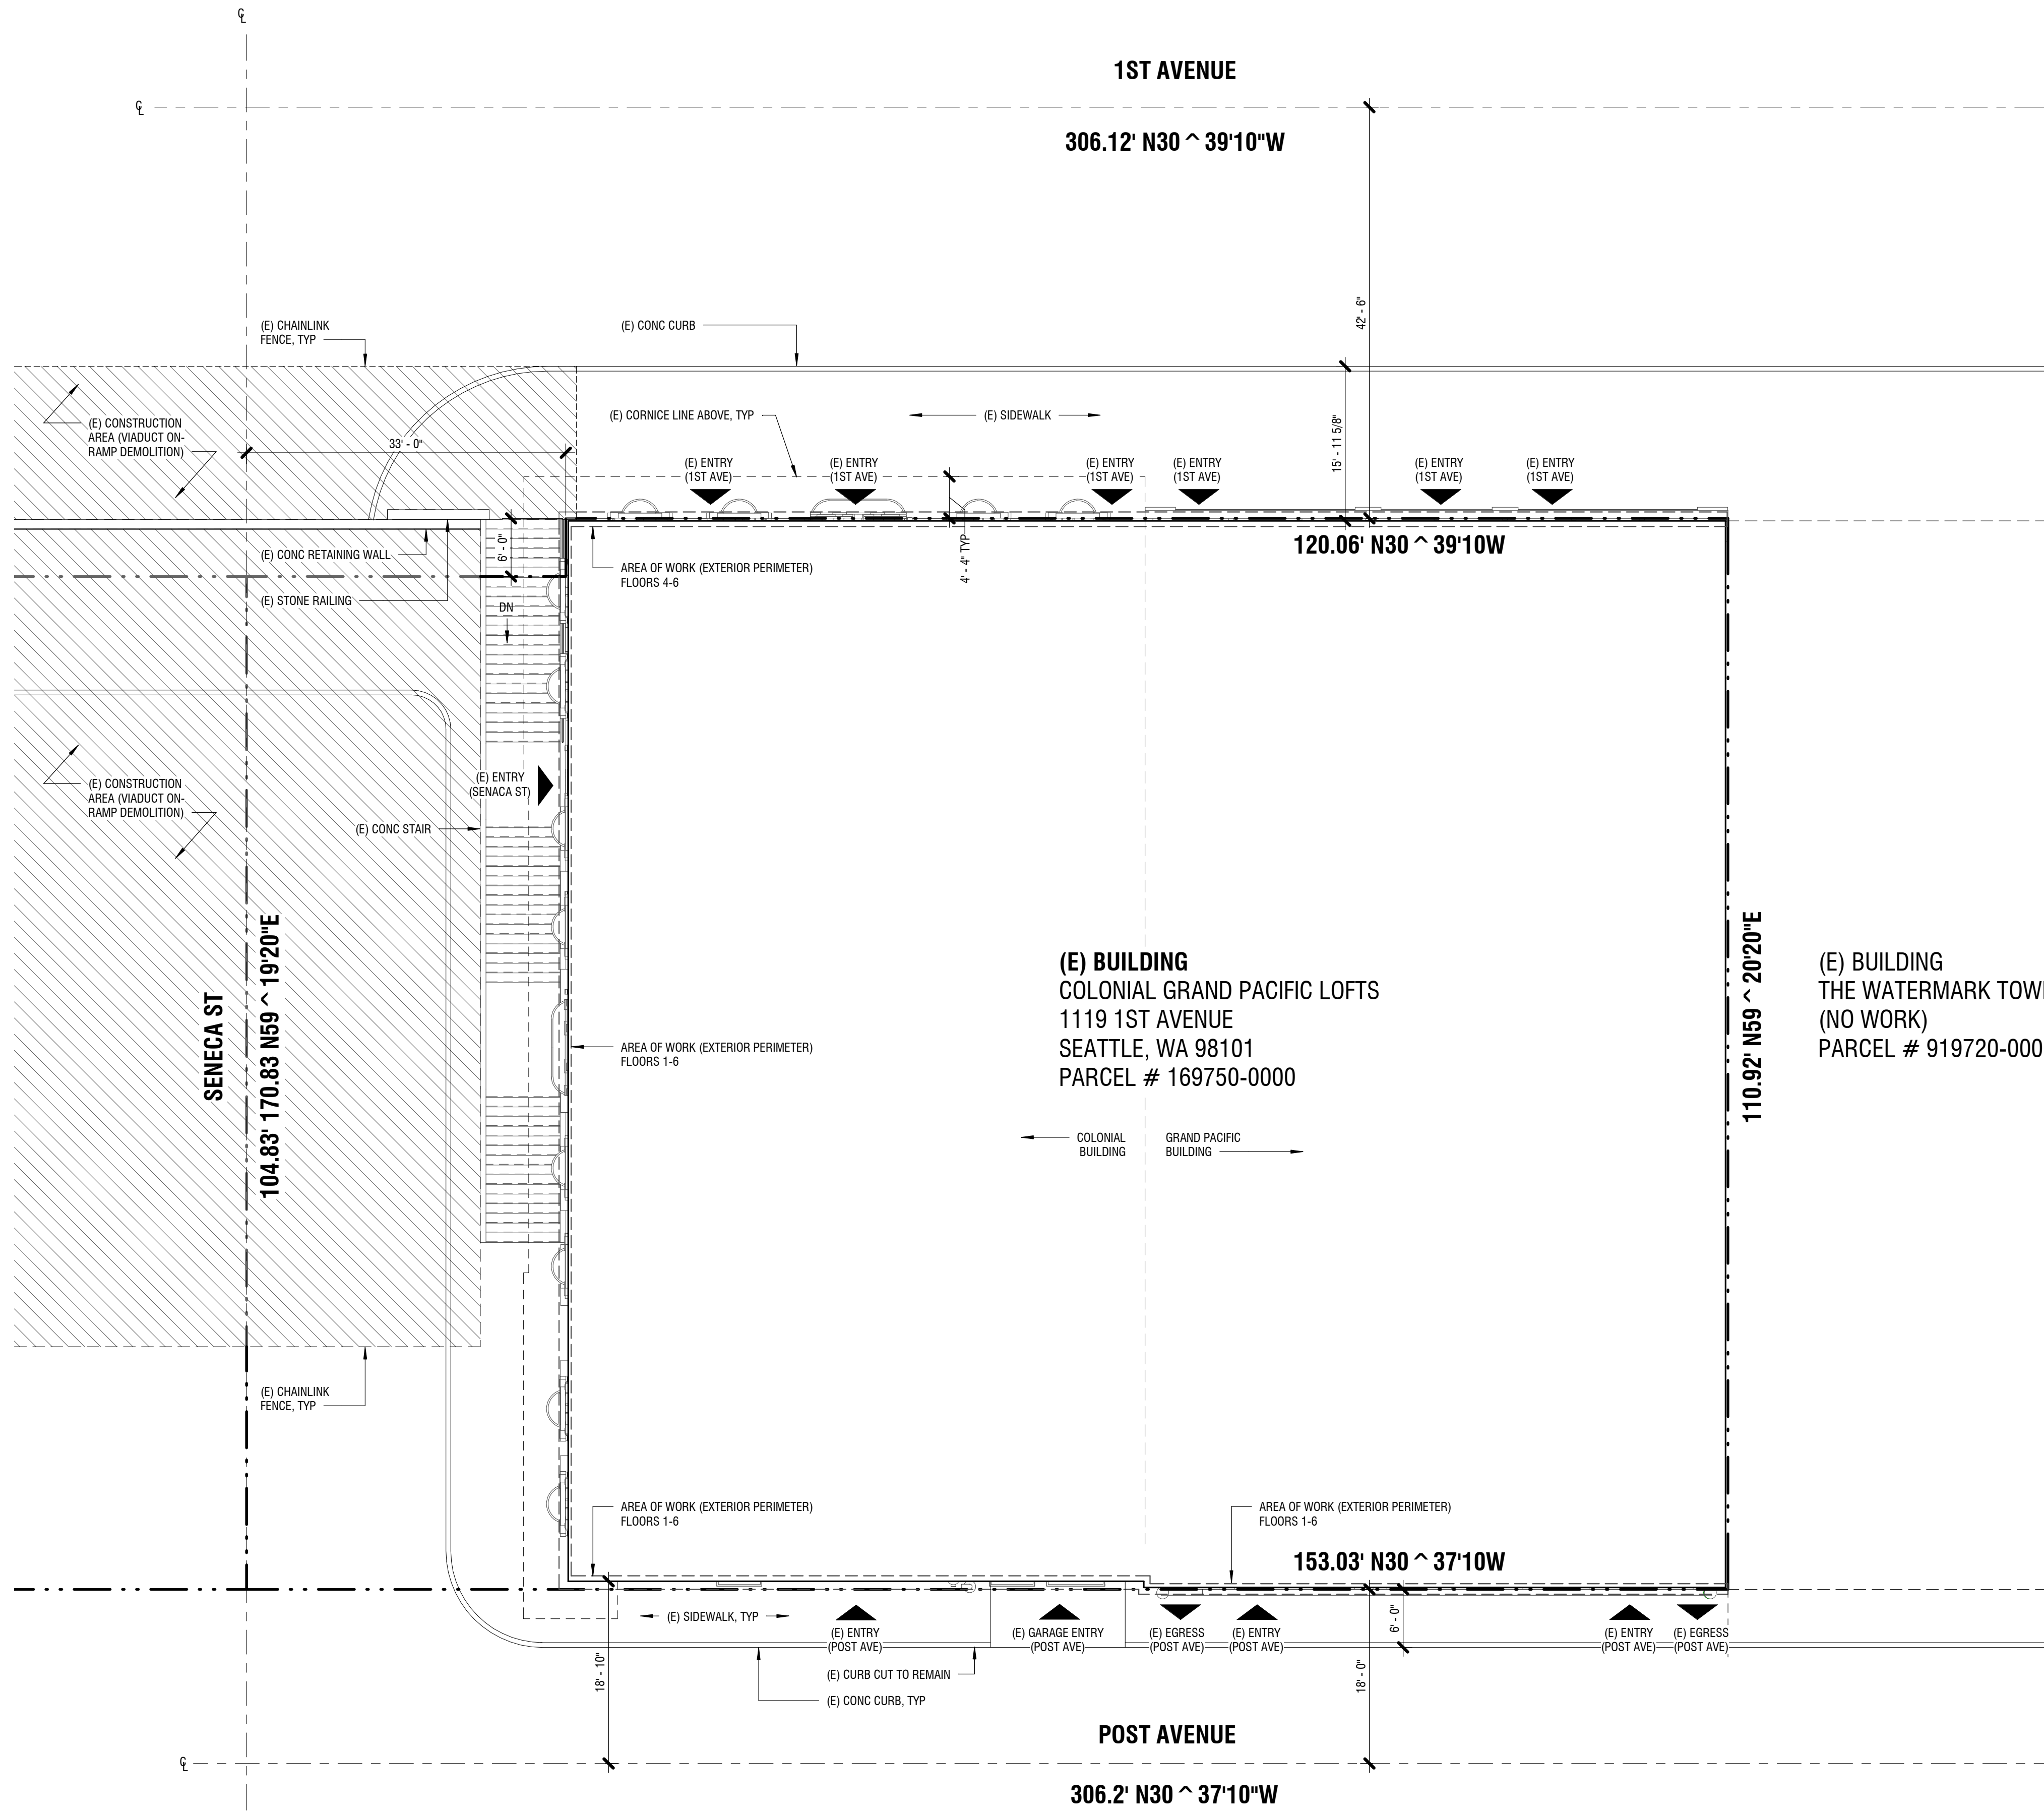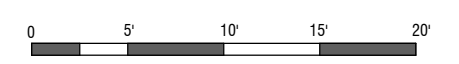
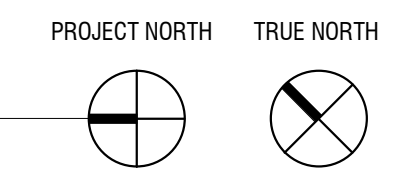
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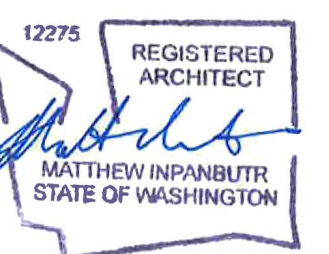
SITE PLAN

A1.0



1 SITE PLAN
1" = 10'-0"



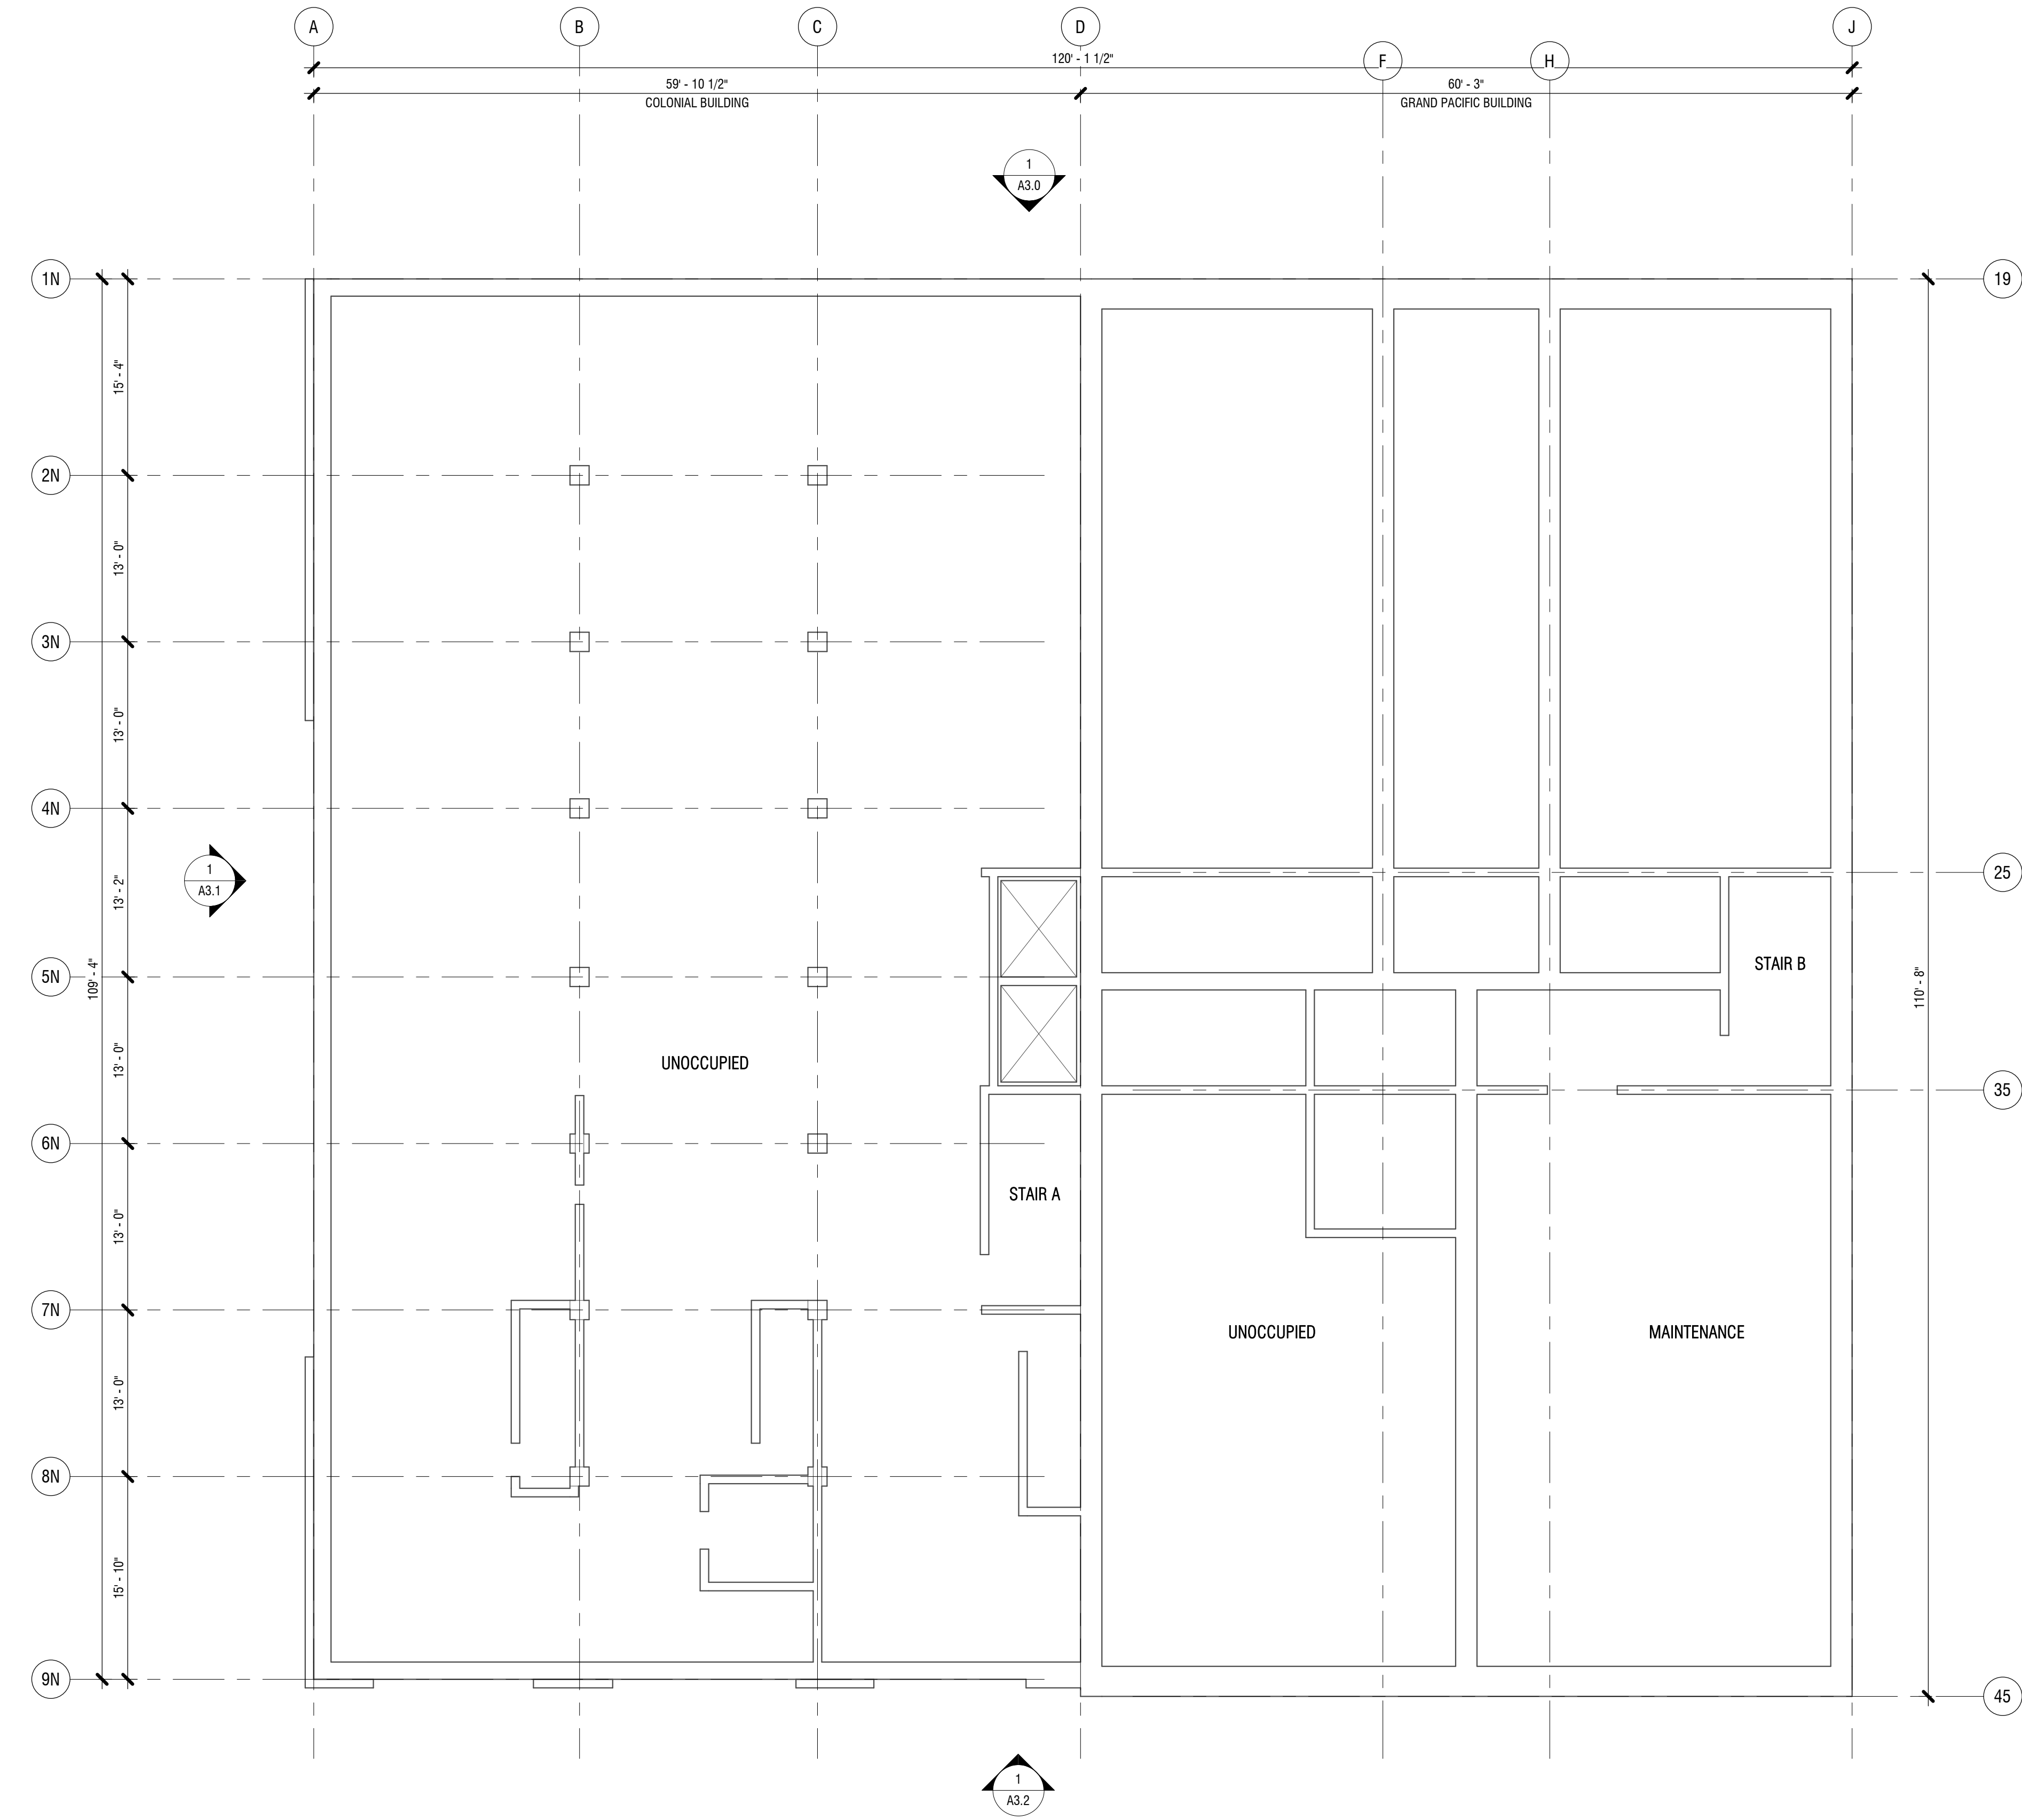


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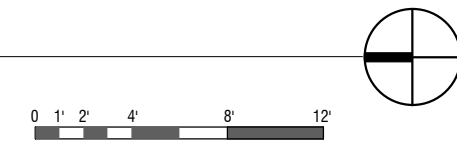
MARK KEYNOTE TEXT

PLAN NOTES:

1. PROTECT LANDSCAPING, SIDEWALKS, AND SITE, TYP.
2. PROTECT EXISTING INTERIOR CIRCULATION ROUTES AND TENANT SPACES WHERE ACCESS IS PERMITTED BY CGP OWNER'S ASSOCIATION, TYP.
3. PROVIDE TEMPORARY PROTECTION AT REMOVED WINDOWS, TO CONTAIN DUST, MINIMIZE OCCUPANT DISRUPTION, AND PREVENT WATER INFILTRATION, TYP.
4. REFER TO SHEETS A2.10 AND A2.11 FOR WINDOW SCHEDULES, TYPES, AND RESTORATION SCOPE OF WORK.
6. REFER TO SHEETS A4.0, A4.1, A4.2 AND A4.3 FOR BALCONY CONDITIONS AND REPAIR TREATMENTS.



1 BASEMENT PLAN
1/8" = 1'-0"




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BASEMENT PLAN
A2.1




| KEYNOTE LEGEND | |
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| MARK | KEYNOTE TEXT |

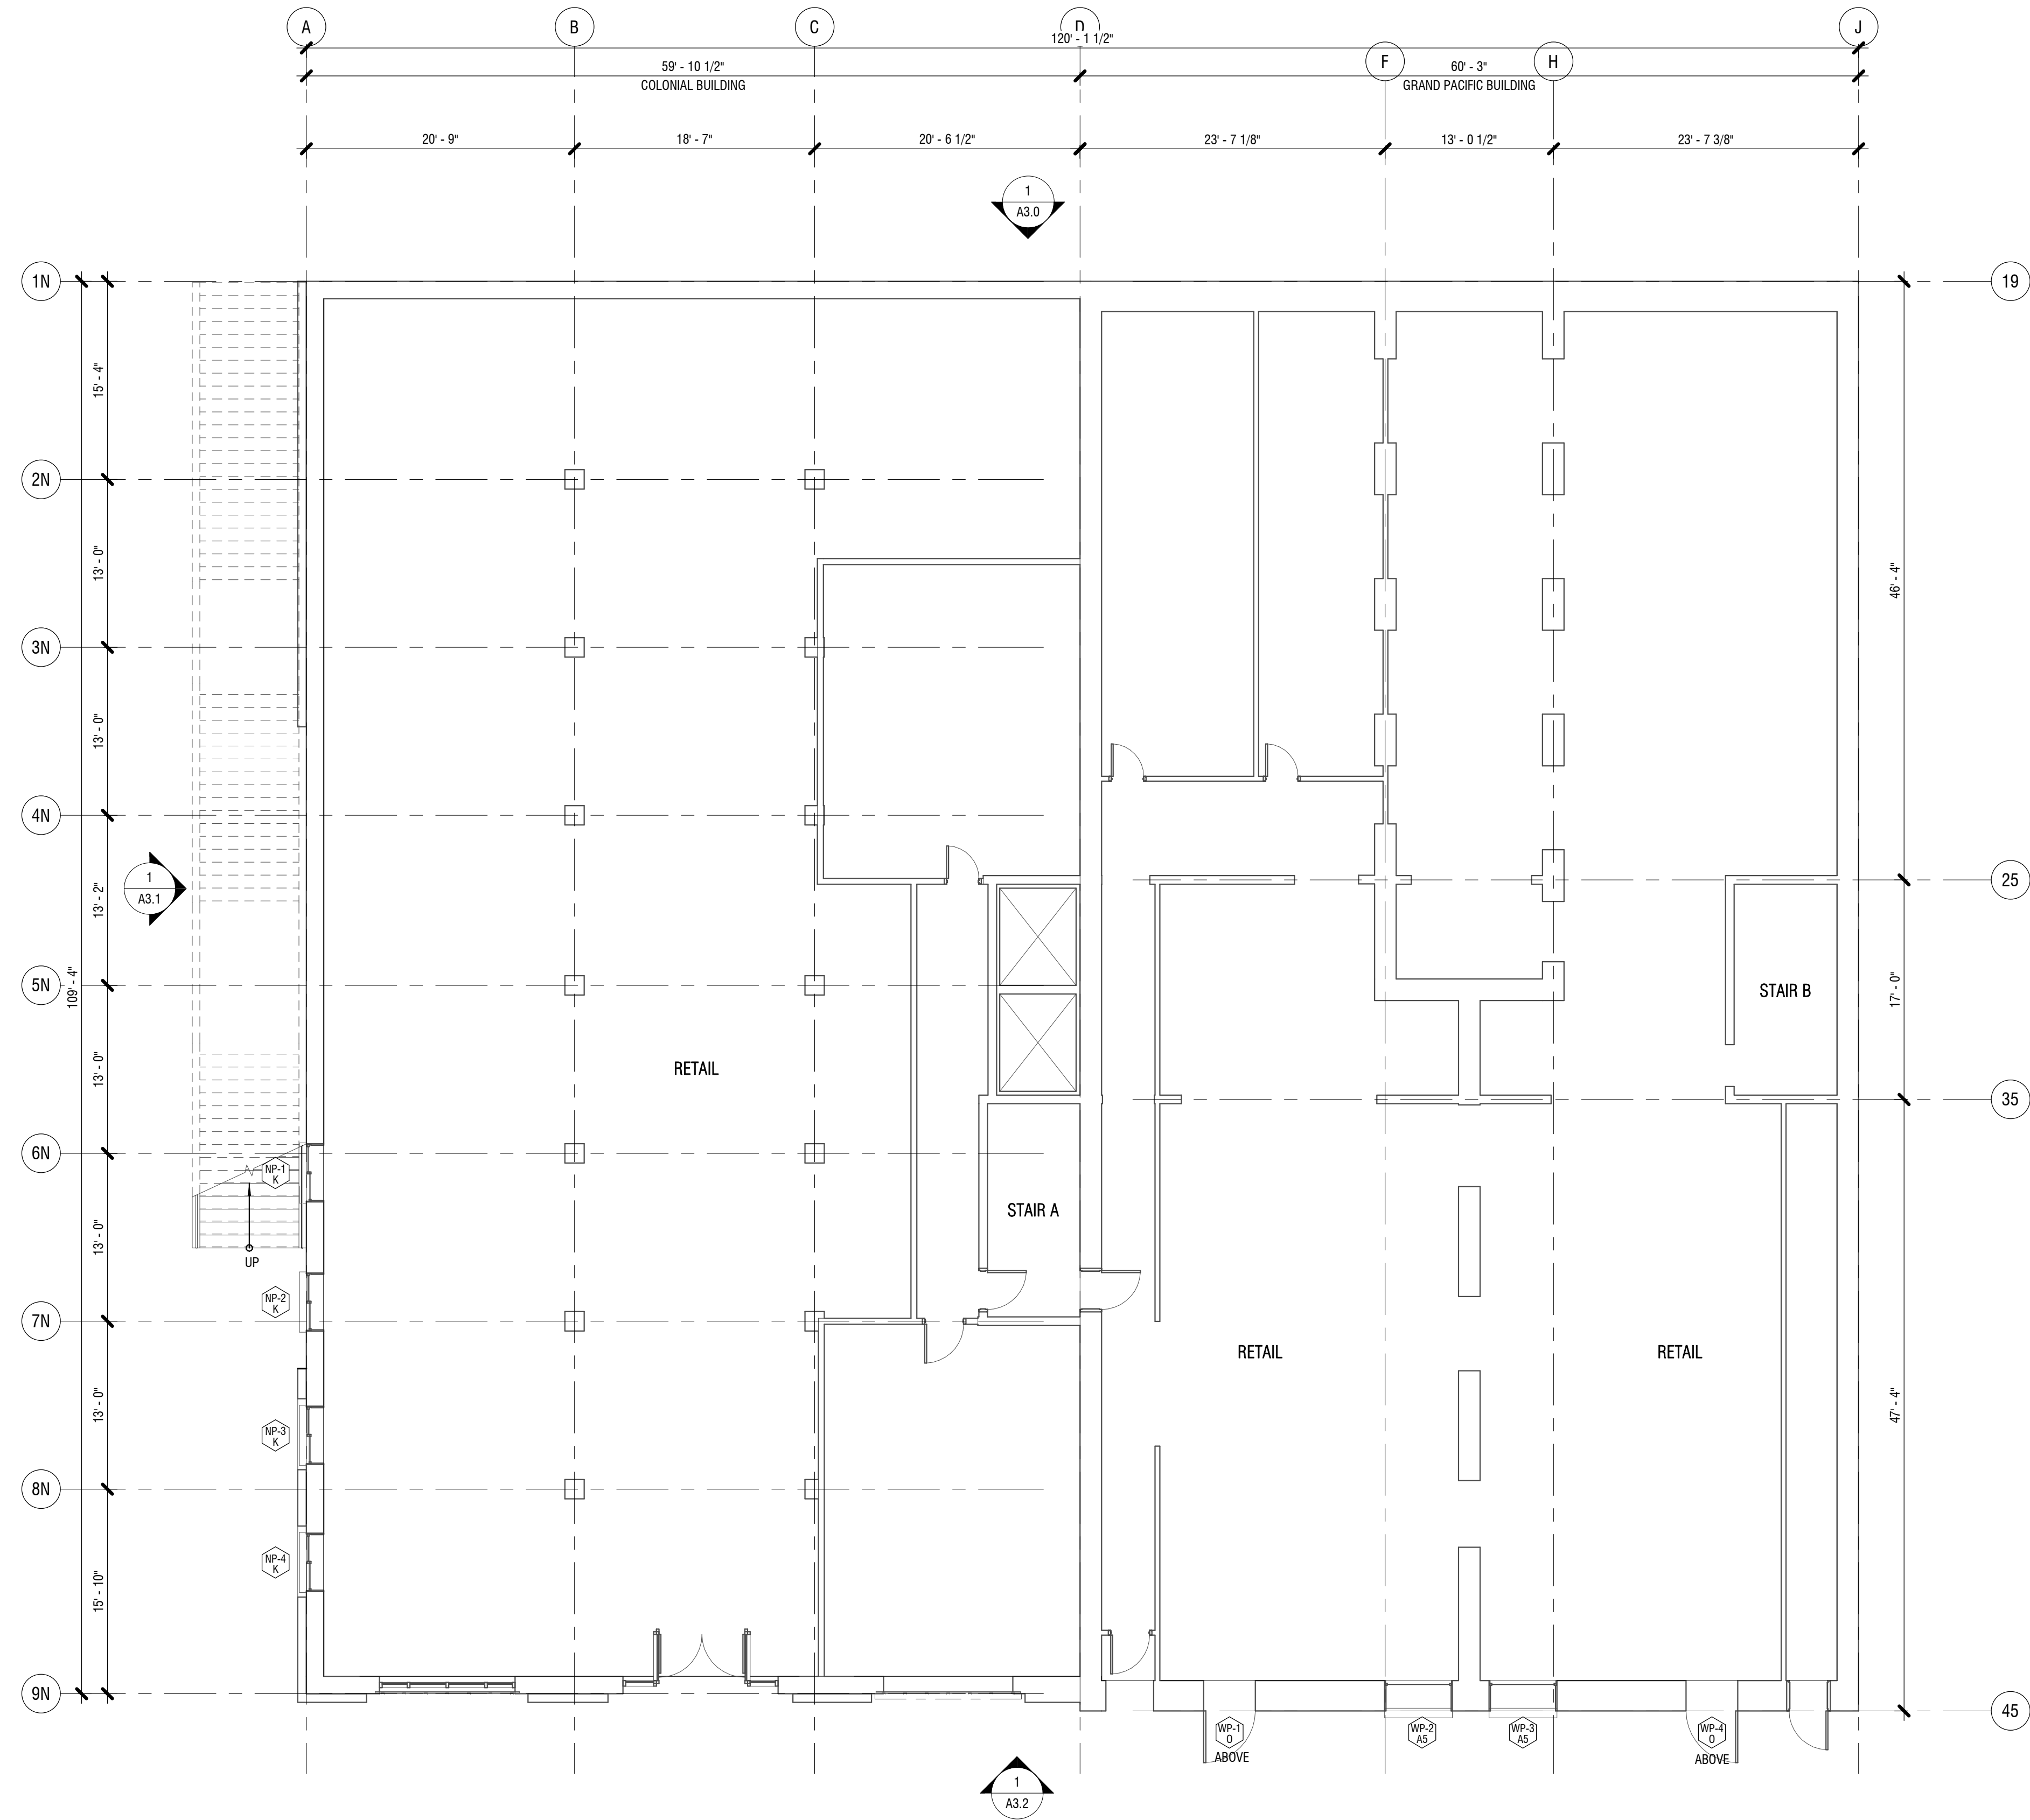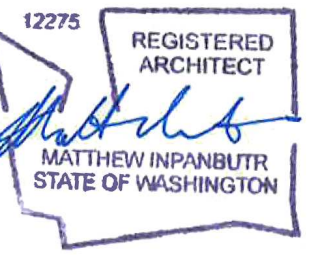PLAN NOTES:

1. PROTECT LANDSCAPING, SIDEWALKS, AND SITE, TYP.
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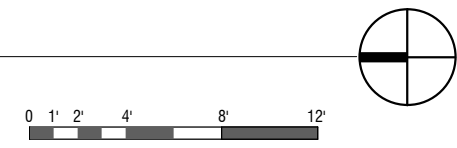
1050 N. 38th St.
Seattle, WA 98103
PH: 206.675.9151
www.shksarchitects.com



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| Revisions: | | |
| No. | Date | Remarks |

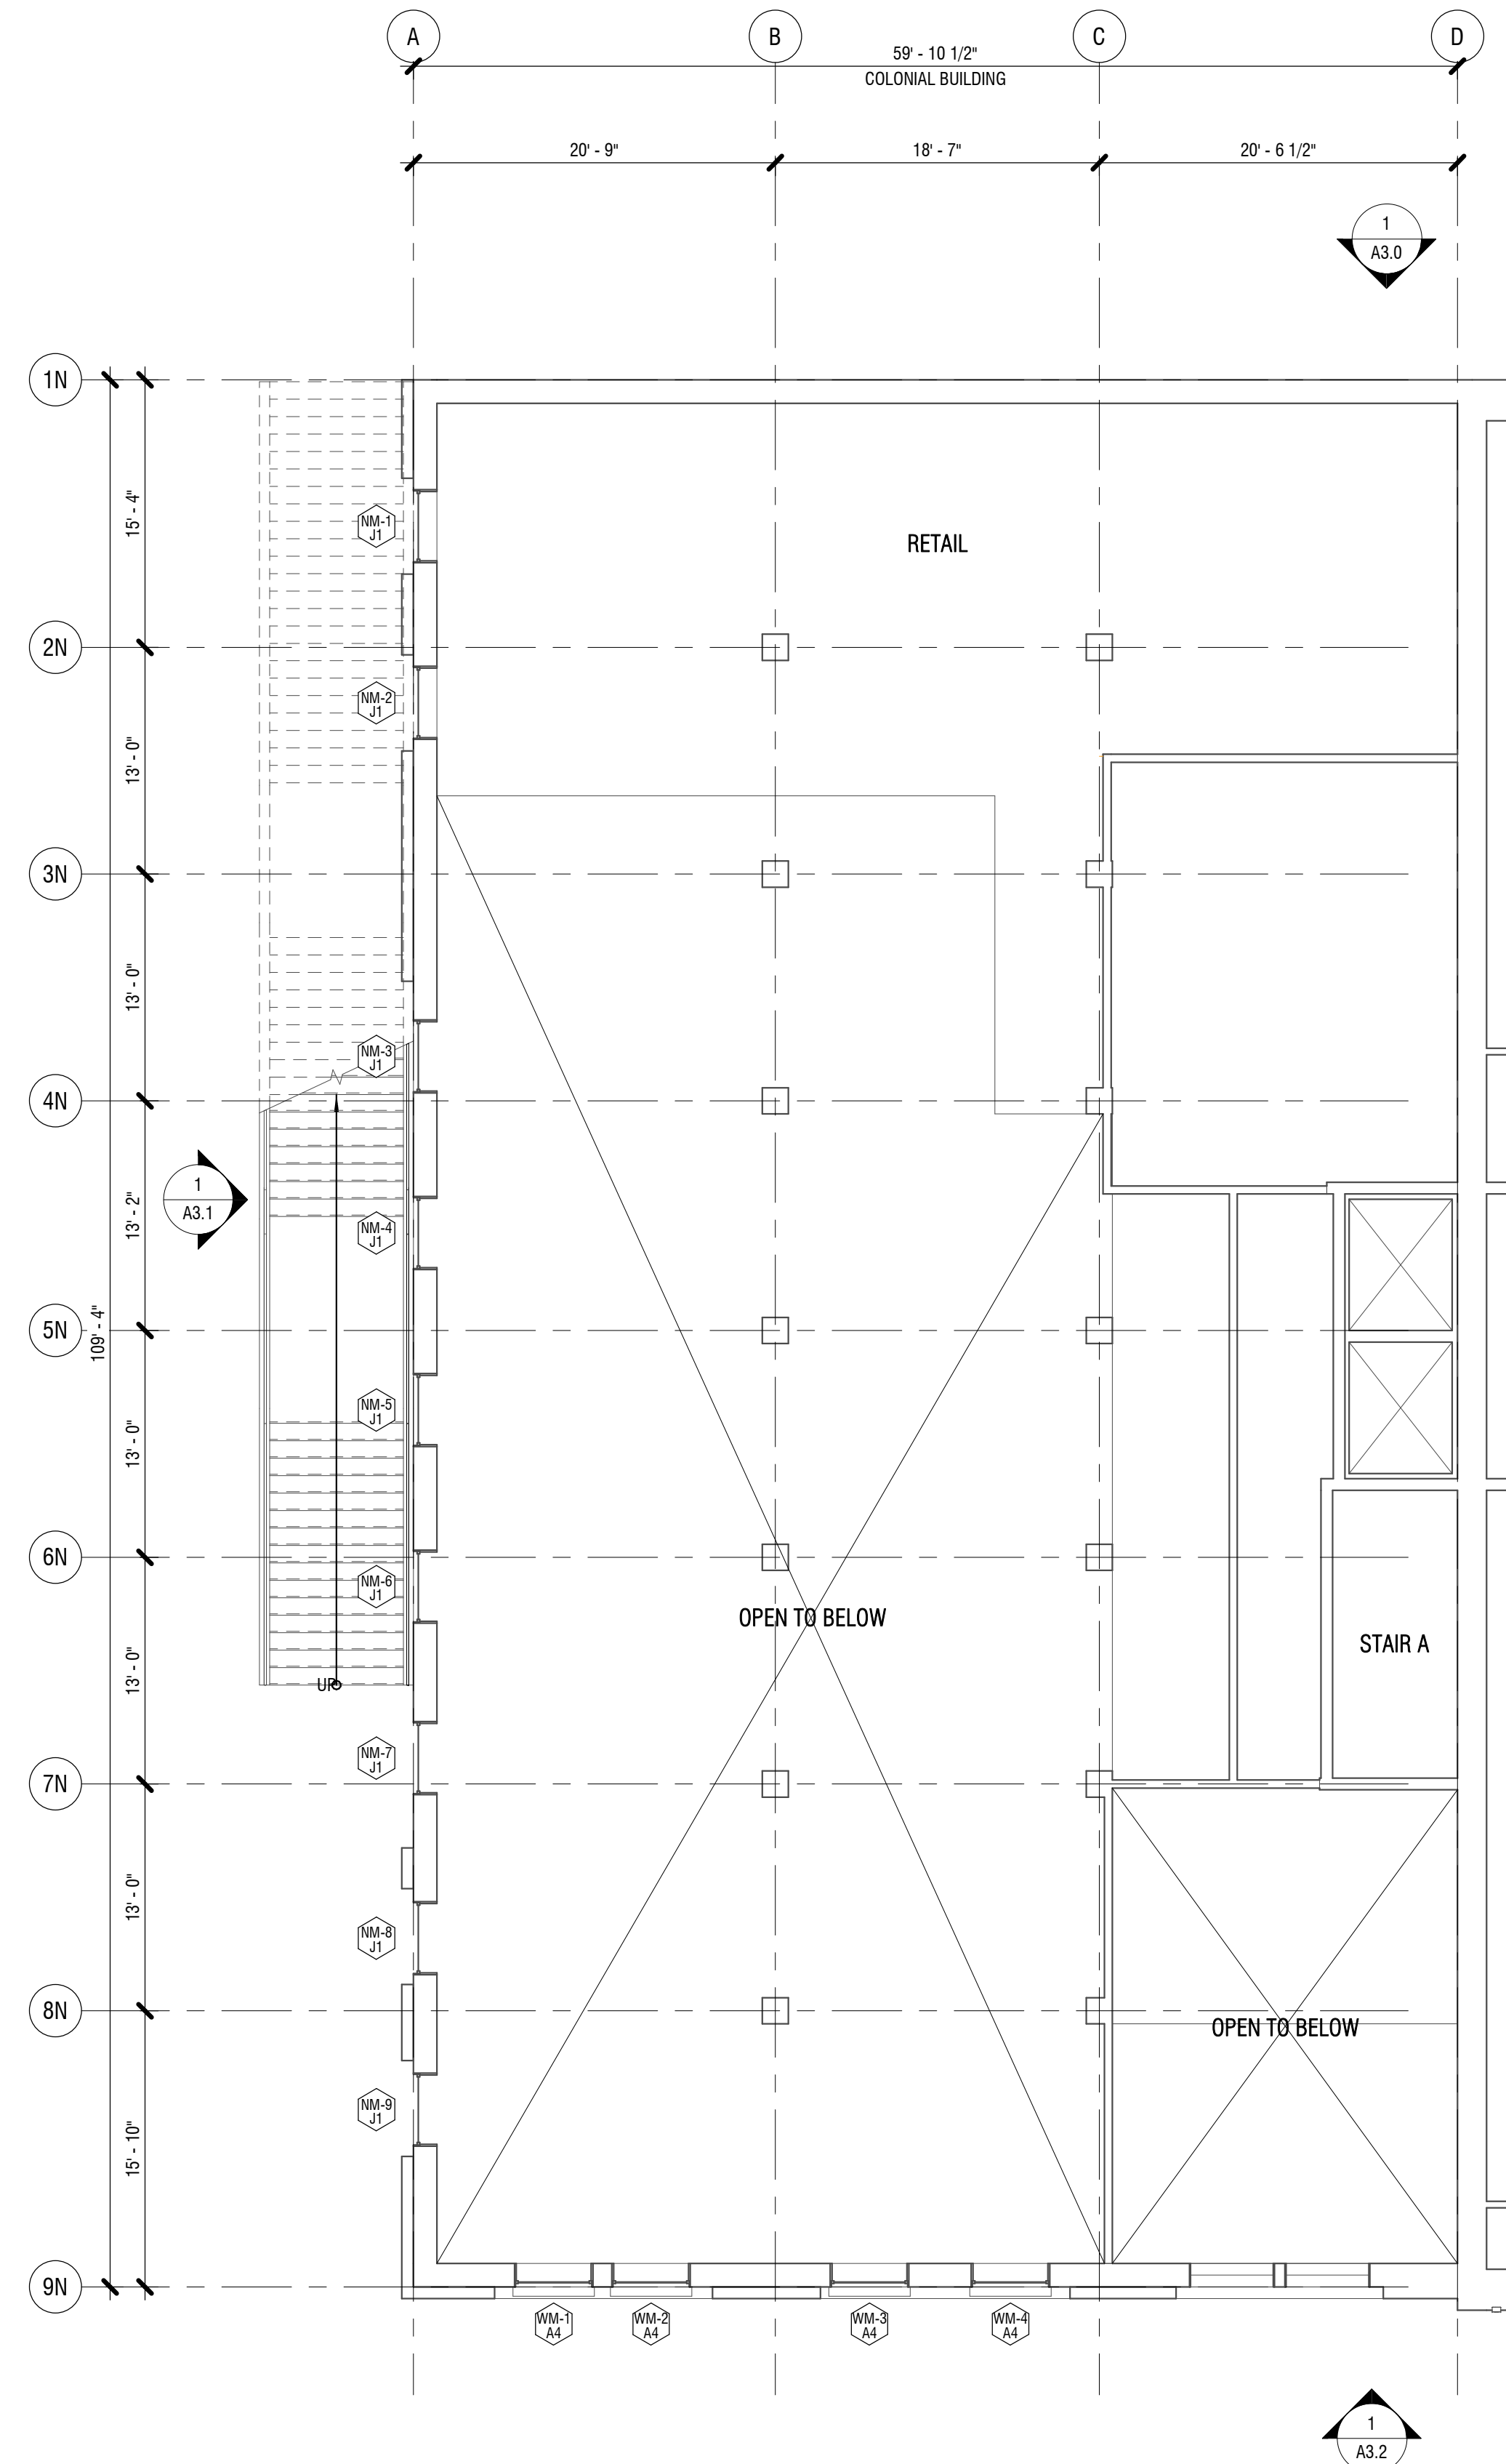
1 POST AVENUE PLAN
1/8" = 1'-0"



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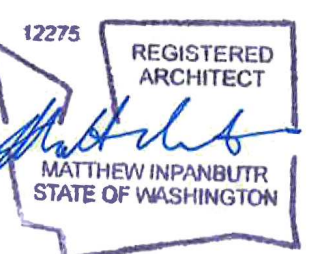
POST AVENUE
PLAN
A2.2



| KEYNOTE LEGEND | |
|----------------|--------------|
| MARK | KEYNOTE TEXT |

- PLAN NOTES:**
1. PROTECT LANDSCAPING, SIDEWALKS, AND SITE, TYP.
 2. PROTECT EXISTING INTERIOR CIRCULATION ROUTES AND TENANT SPACES WHERE ACCESS IS PERMITTED BY CGP OWNER'S ASSOCIATION, TYP.
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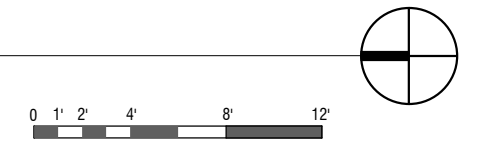
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Seattle, WA 98103
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THE COLONIAL
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| Drawn by: | TD |
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| Date: | 2/16/2021 |
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| No. | Date |
| | Remarks |


1 MEZZANINE FLOOR PLAN
1/8" = 1'-0"



DCI APPROVAL STAMPS

NOT FOR CONSTRUCTION

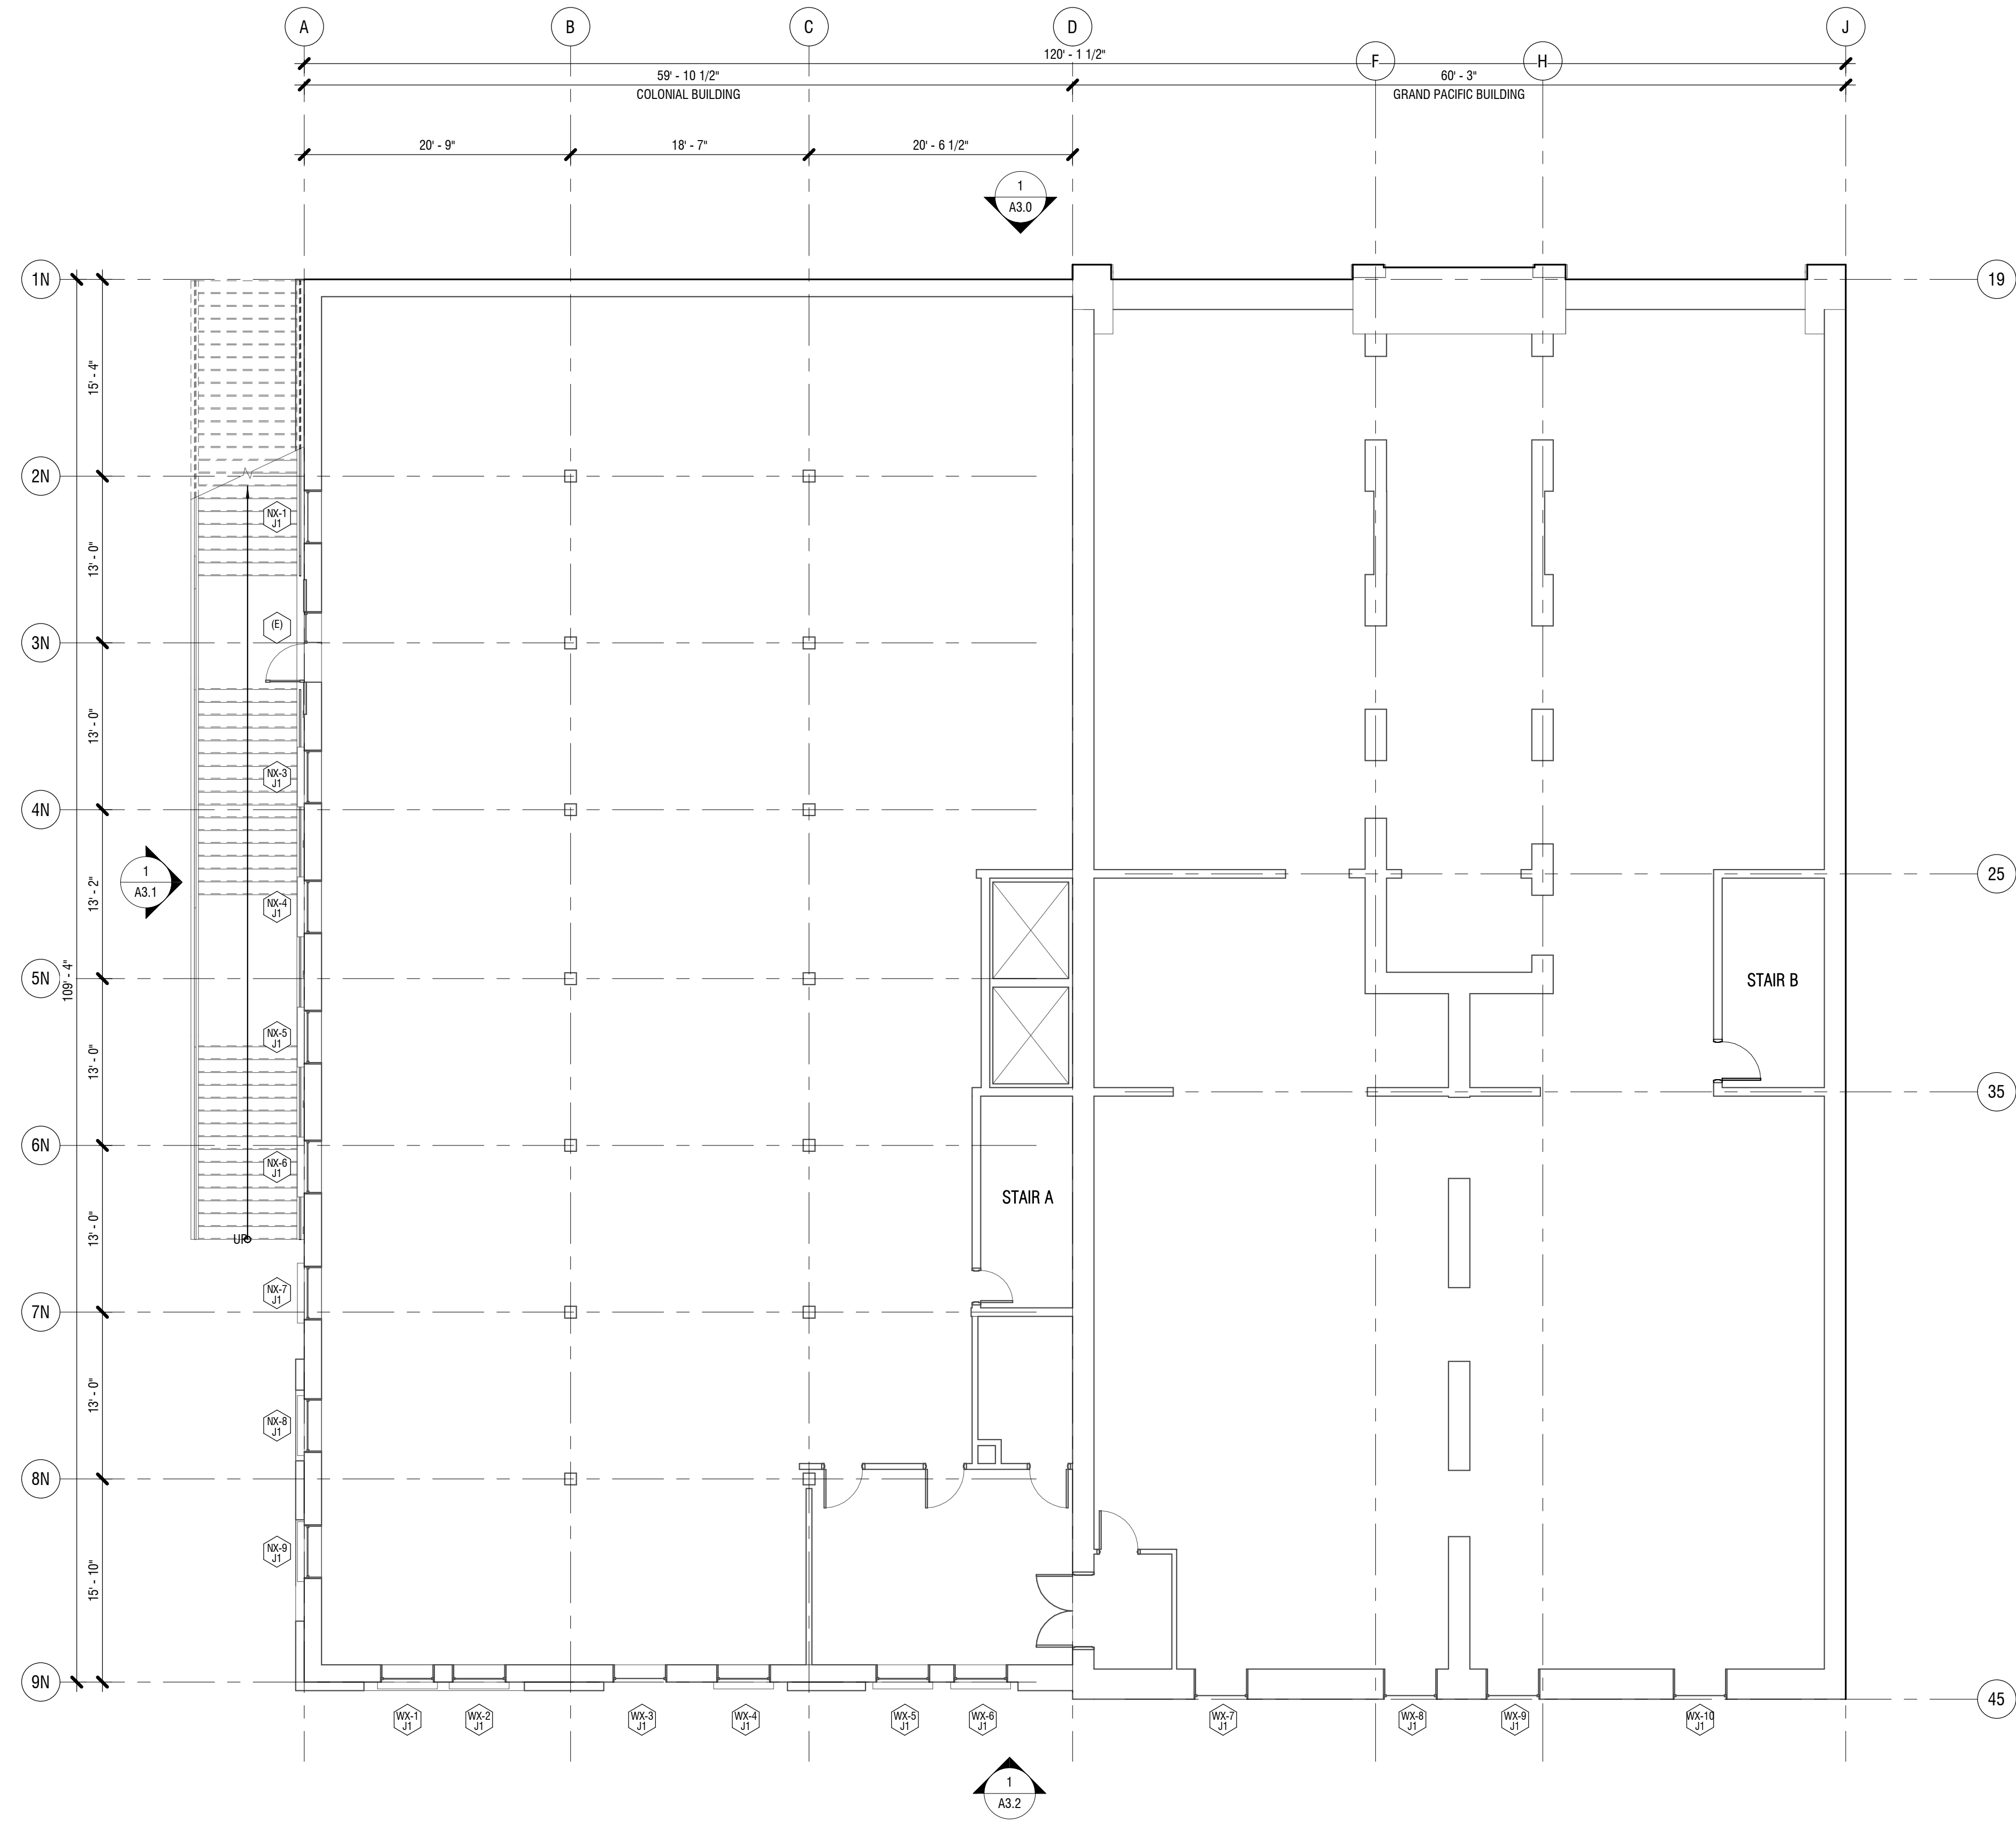MEZZANINE
FLOOR PLAN
A2.3



| KEYNOTE LEGEND | |
|----------------|--------------|
| MARK | KEYNOTE TEXT |

- PLAN NOTES:**
1. PROTECT LANDSCAPING, SIDEWALKS, AND SITE, TYP.
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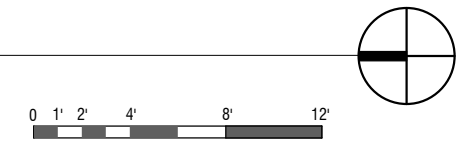
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| Revisions: | |
| No. | Date |
| | Remarks |


1 COLONIAL COMMERCIAL FLOOR PLAN
1/8" = 1'-0"



DCI APPROVAL STAMPS

NOT FOR CONSTRUCTION

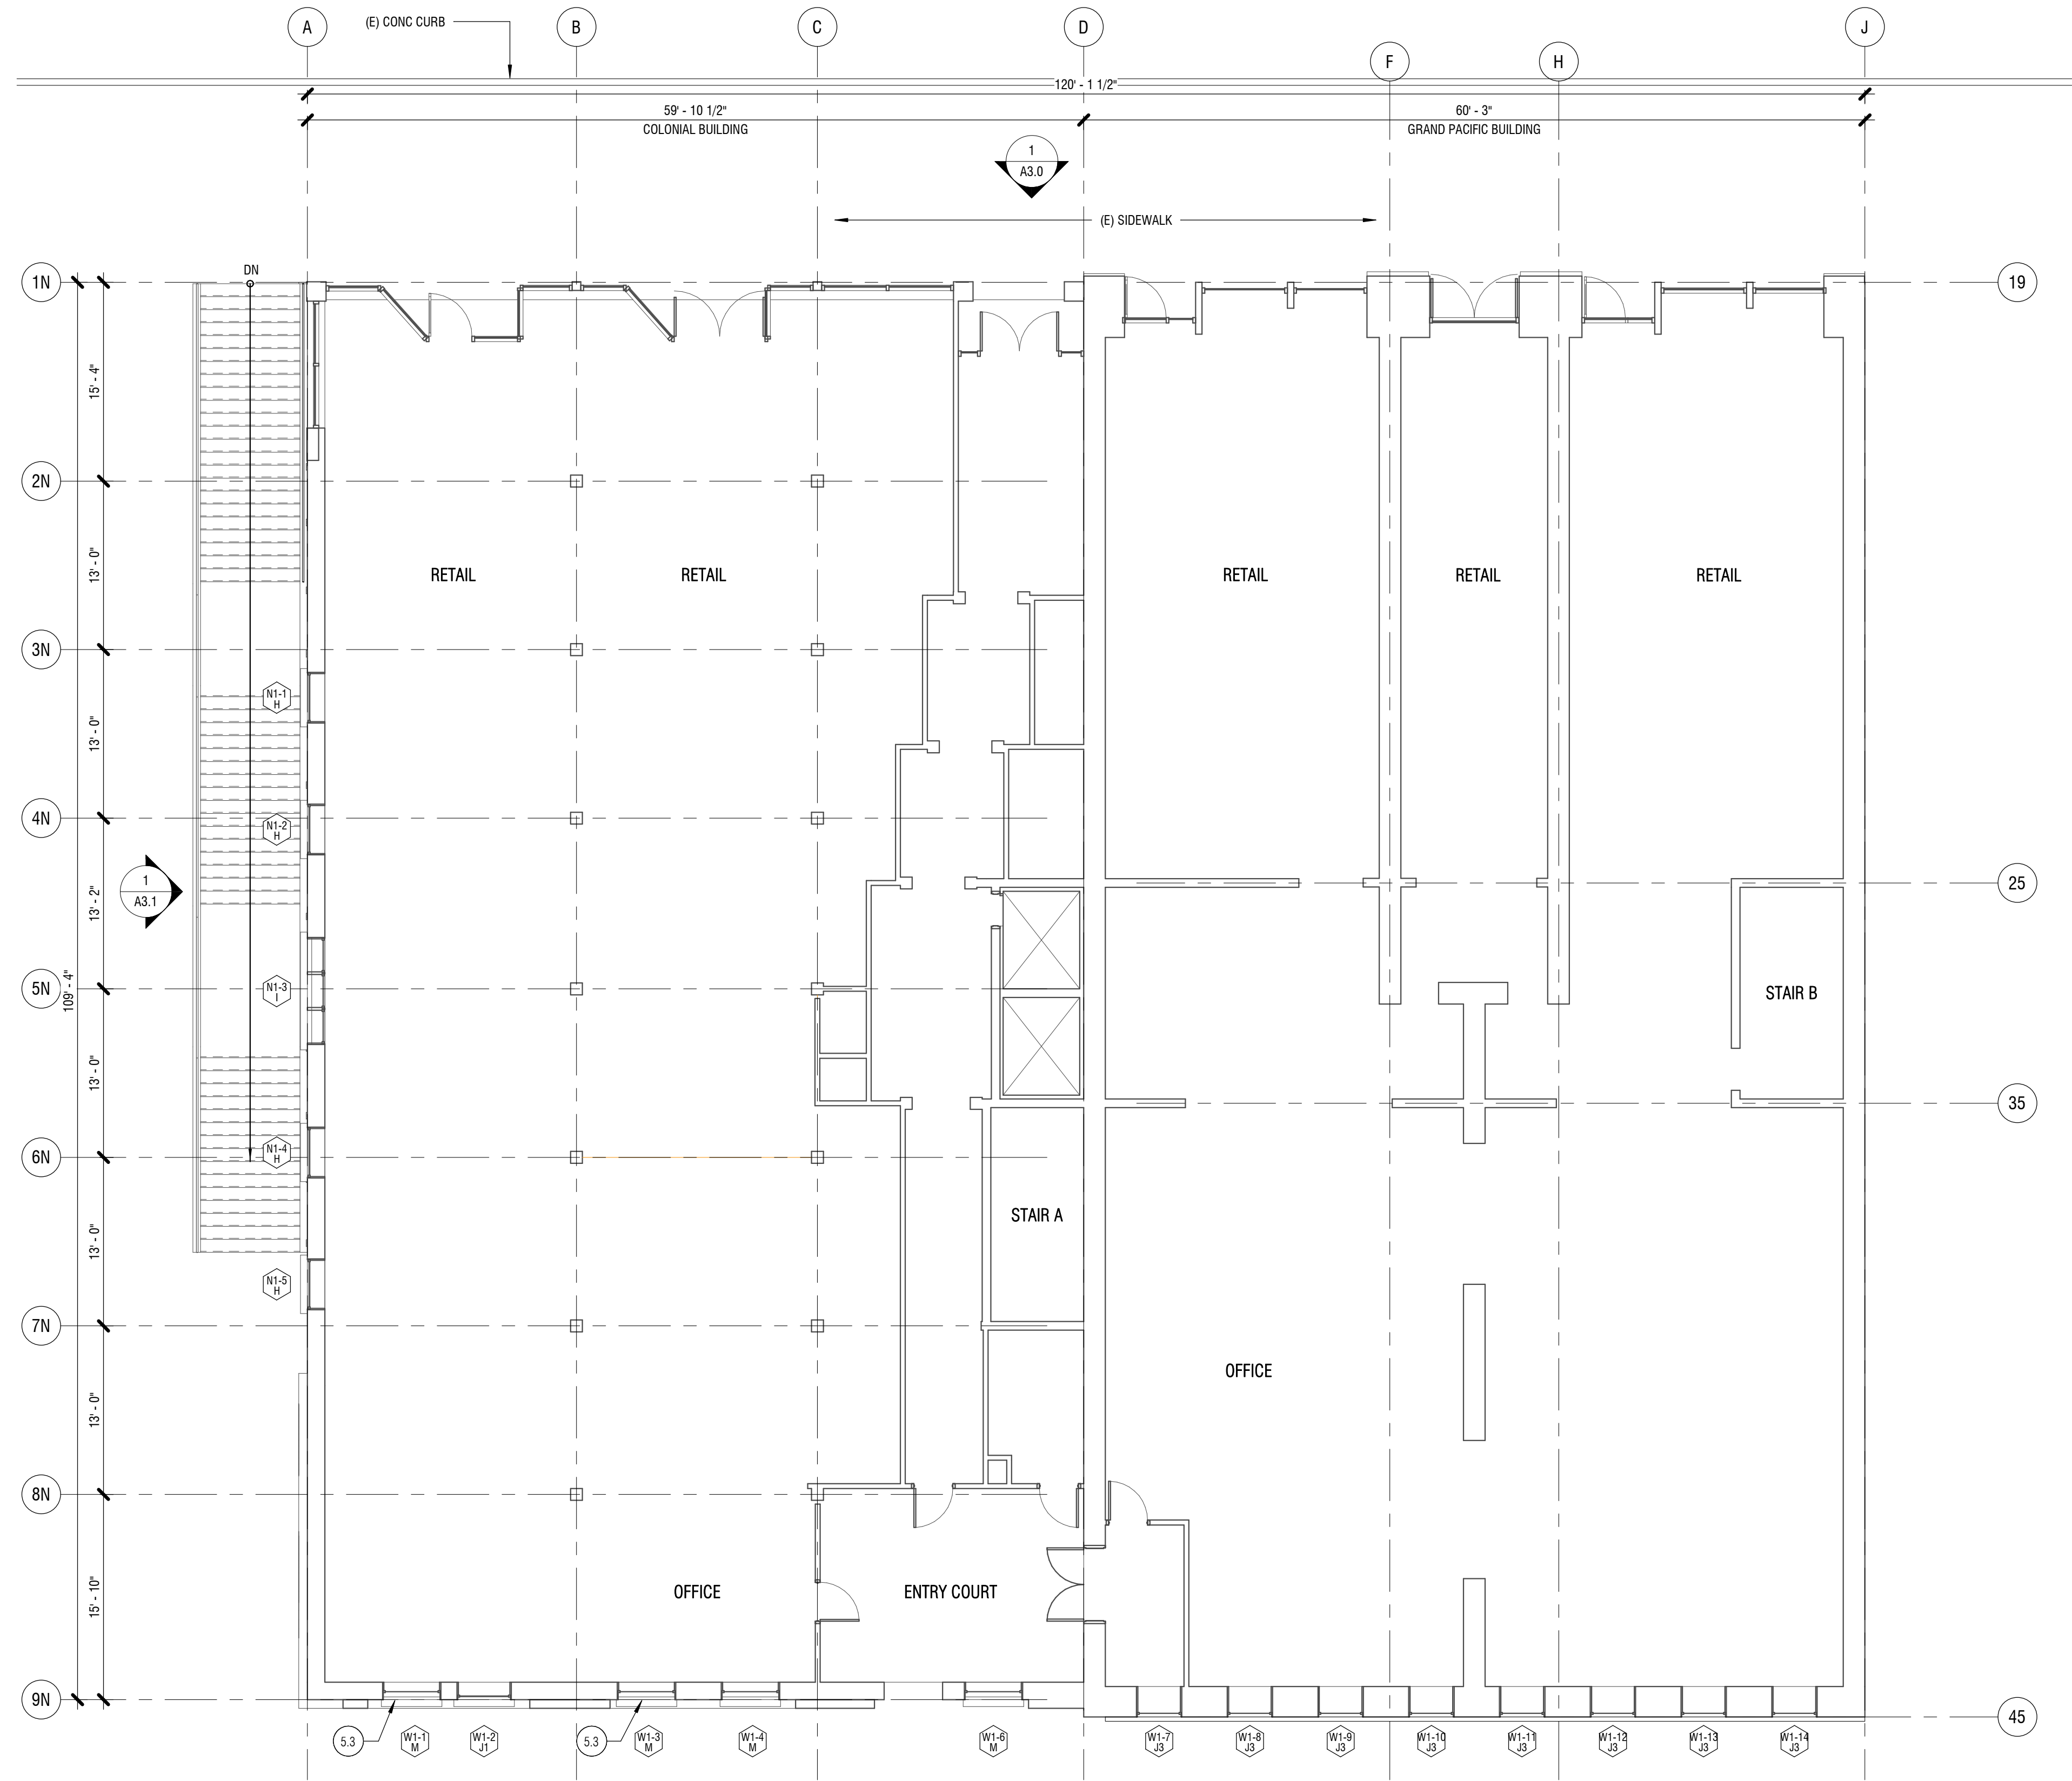COLONIAL
COMMERCIAL
FLOOR PLAN
A2.4



| KEYNOTE LEGEND | |
|----------------|---|
| MARK | KEYNOTE TEXT |
| 5.3 | (E) STEEL PLANT BALCONY: REMOVE, RESTORE, PREP AND PAINT, AND REINSTALL |

- PLAN NOTES:**
1. PROTECT LANDSCAPING, SIDEWALKS, AND SITE, TYP.
 2. PROTECT EXISTING INTERIOR CIRCULATION ROUTES AND TENANT SPACES WHERE ACCESS IS PERMITTED BY CGP OWNER'S ASSOCIATION, TYP.
 3. PROVIDE TEMPORARY PROTECTION AT REMOVED WINDOWS, TO CONTAIN DUST, MINIMIZE OCCUPANT DISRUPTION, AND PREVENT WATER INFILTRATION, TYP.
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 5. REFER TO SHEETS A4.0, A4.1, A4.2 AND A4.3 FOR BALCONY CONDITIONS AND REPAIR TREATMENTS.

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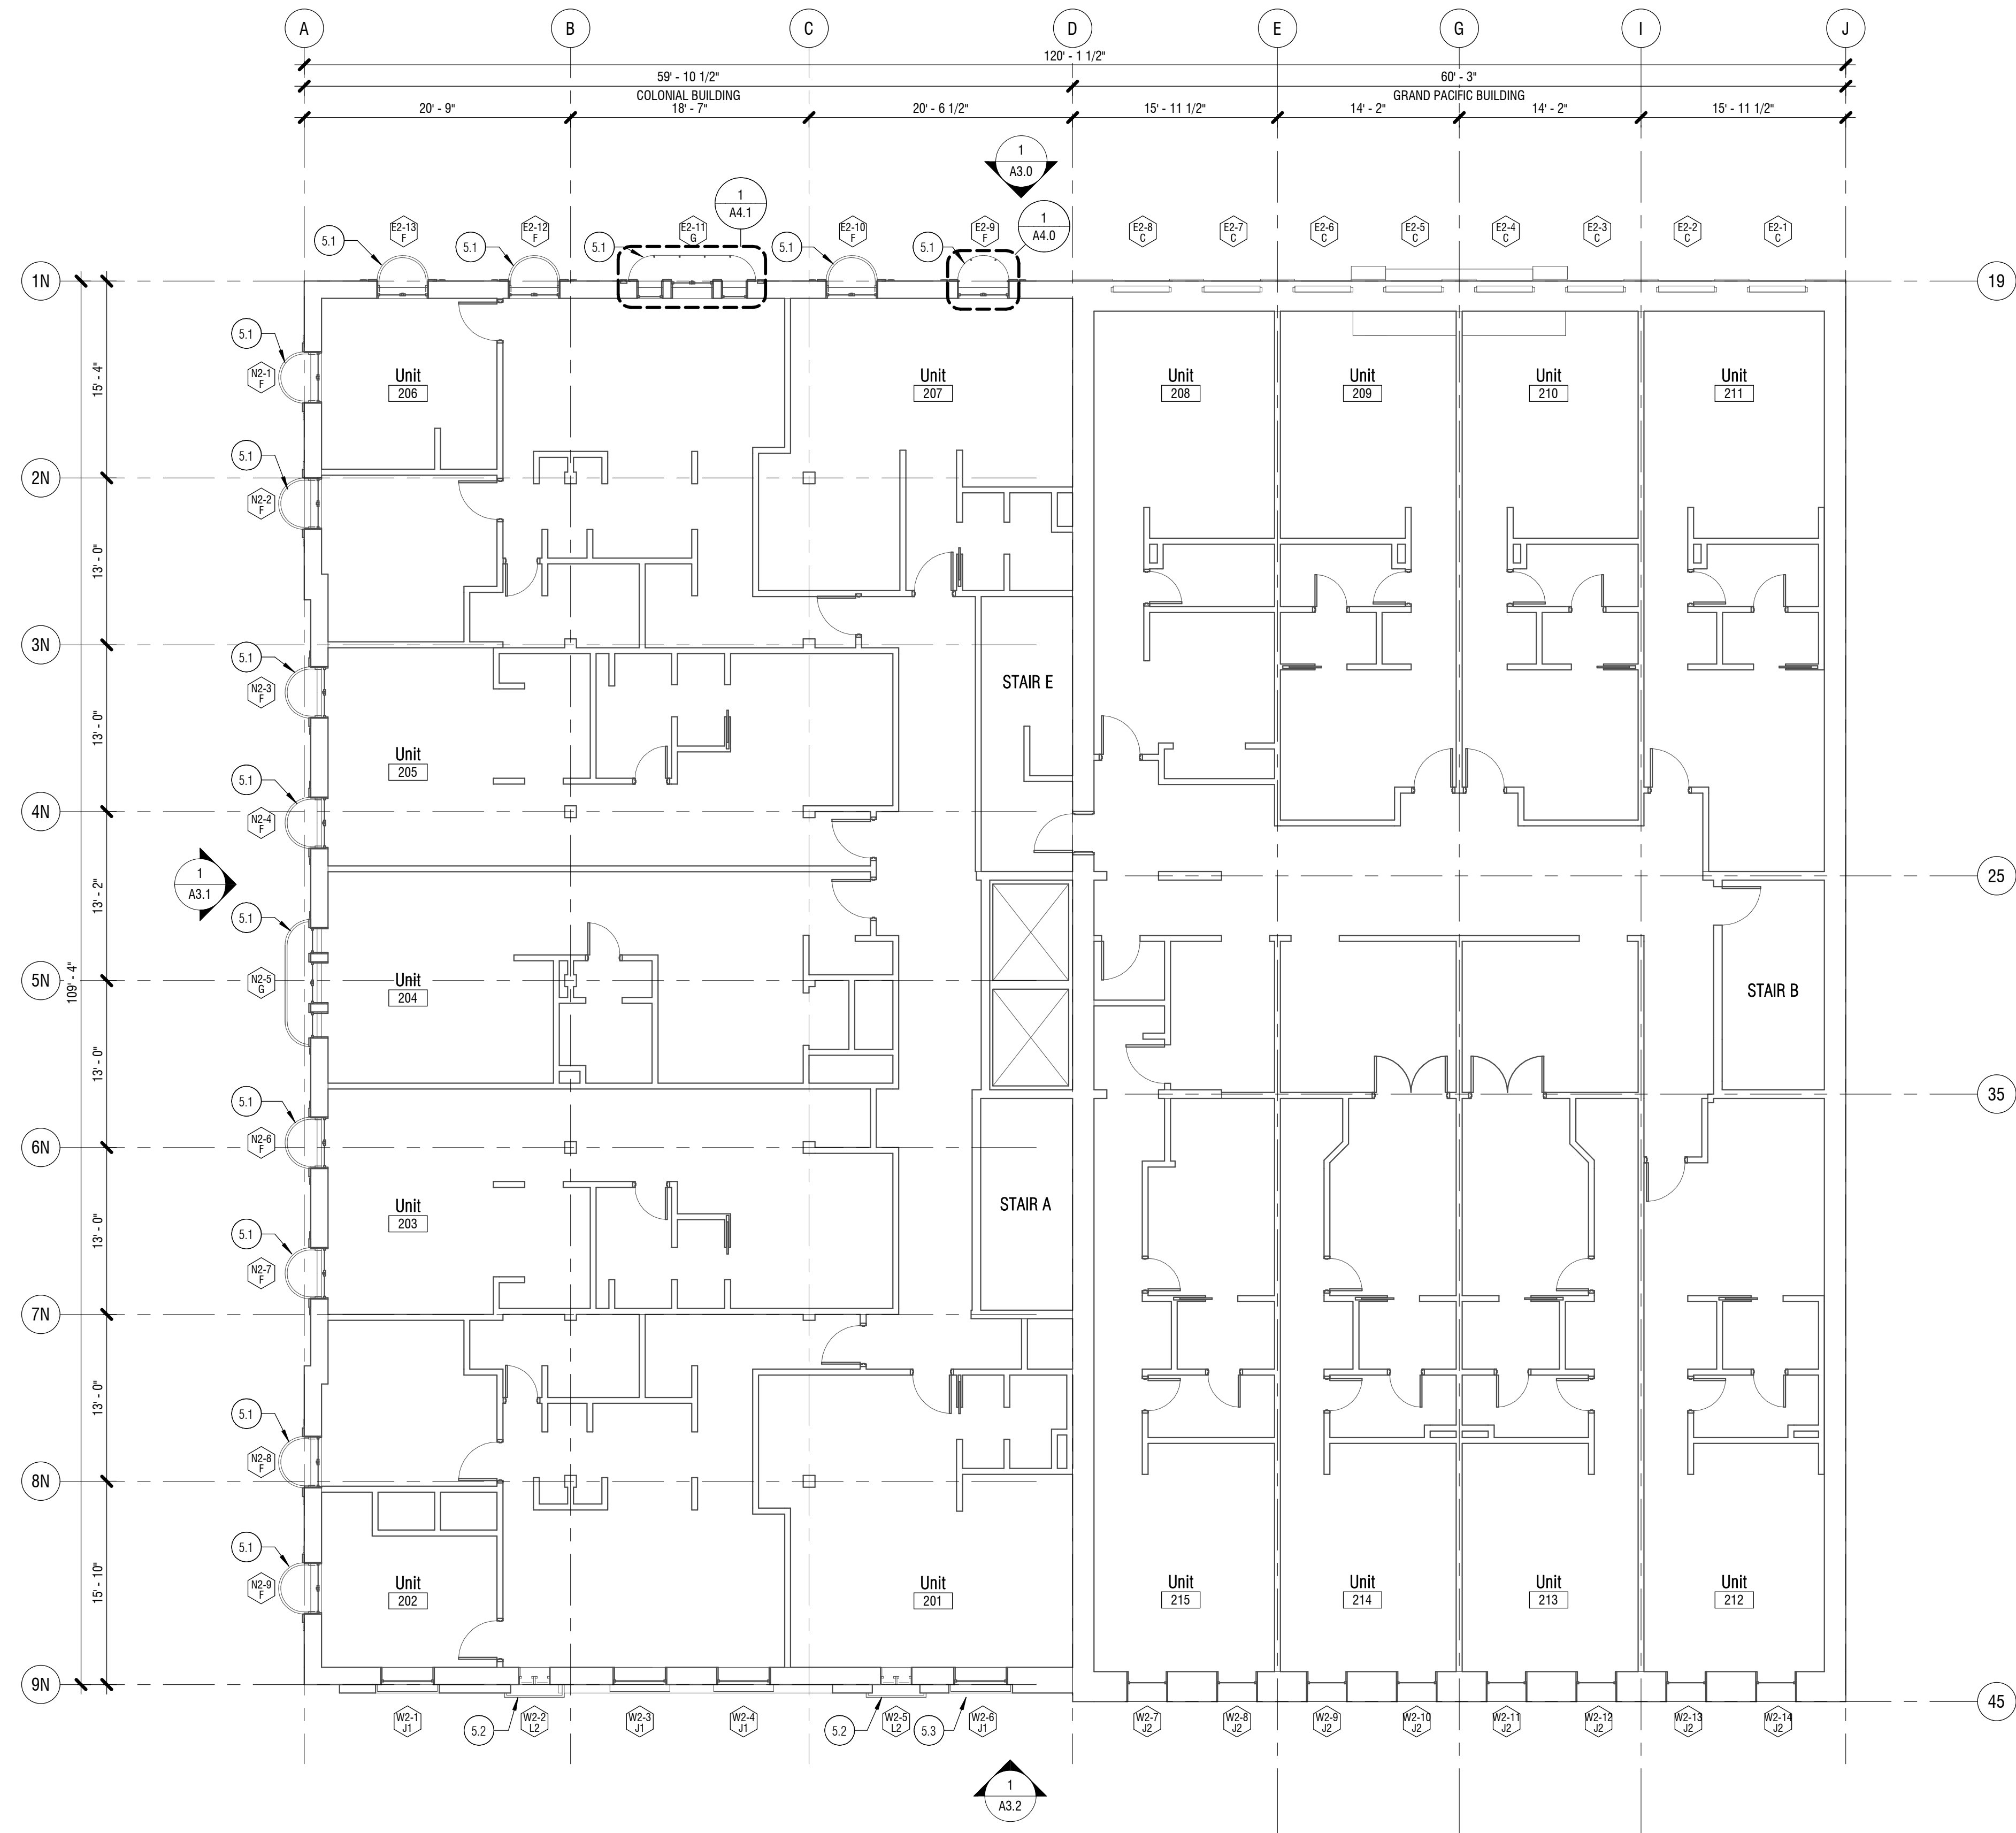
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Checked: MH
Date: 2/16/2021
Scale: As indicated
Revisions: No. Date Remarks

1 FIRST FLOOR PLAN - FIRST AVENUE
1/8" = 1'-0"

DCI APPROVAL STAMPS

NOT FOR CONSTRUCTION


FIRST FLOOR
PLAN - FIRST
AVENUE
A2.5



| MARK | KEYNOTE TEXT |
|------|---|
| 5.1 | (E) JULIET BALCONY: REMOVE, RESTORE, MODIFY PER DETAILS, PREP AND PAINT, AND REINSTALL. |
| 5.2 | (E) STEEL BALCONY: REMOVE, RESTORE, MODIFY PER DETAILS, PREP AND PAINT, AND REINSTALL. |
| 5.3 | (E) STEEL PLANT BALCONY: REMOVE, RESTORE, PREP AND PAINT, AND REINSTALL. |

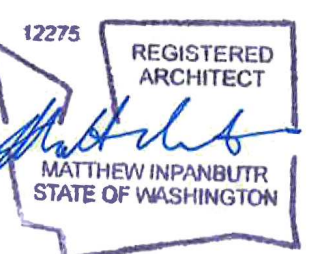- PLAN NOTES:**
- PROTECT LANDSCAPING, SIDEWALKS, AND SITE, TYP.
 - PROTECT EXISTING INTERIOR CIRCULATION ROUTES AND TENANT SPACES WHERE ACCESS IS PERMITTED BY CGP OWNER'S ASSOCIATION, TYP.
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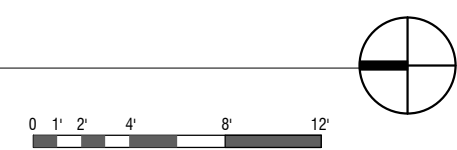
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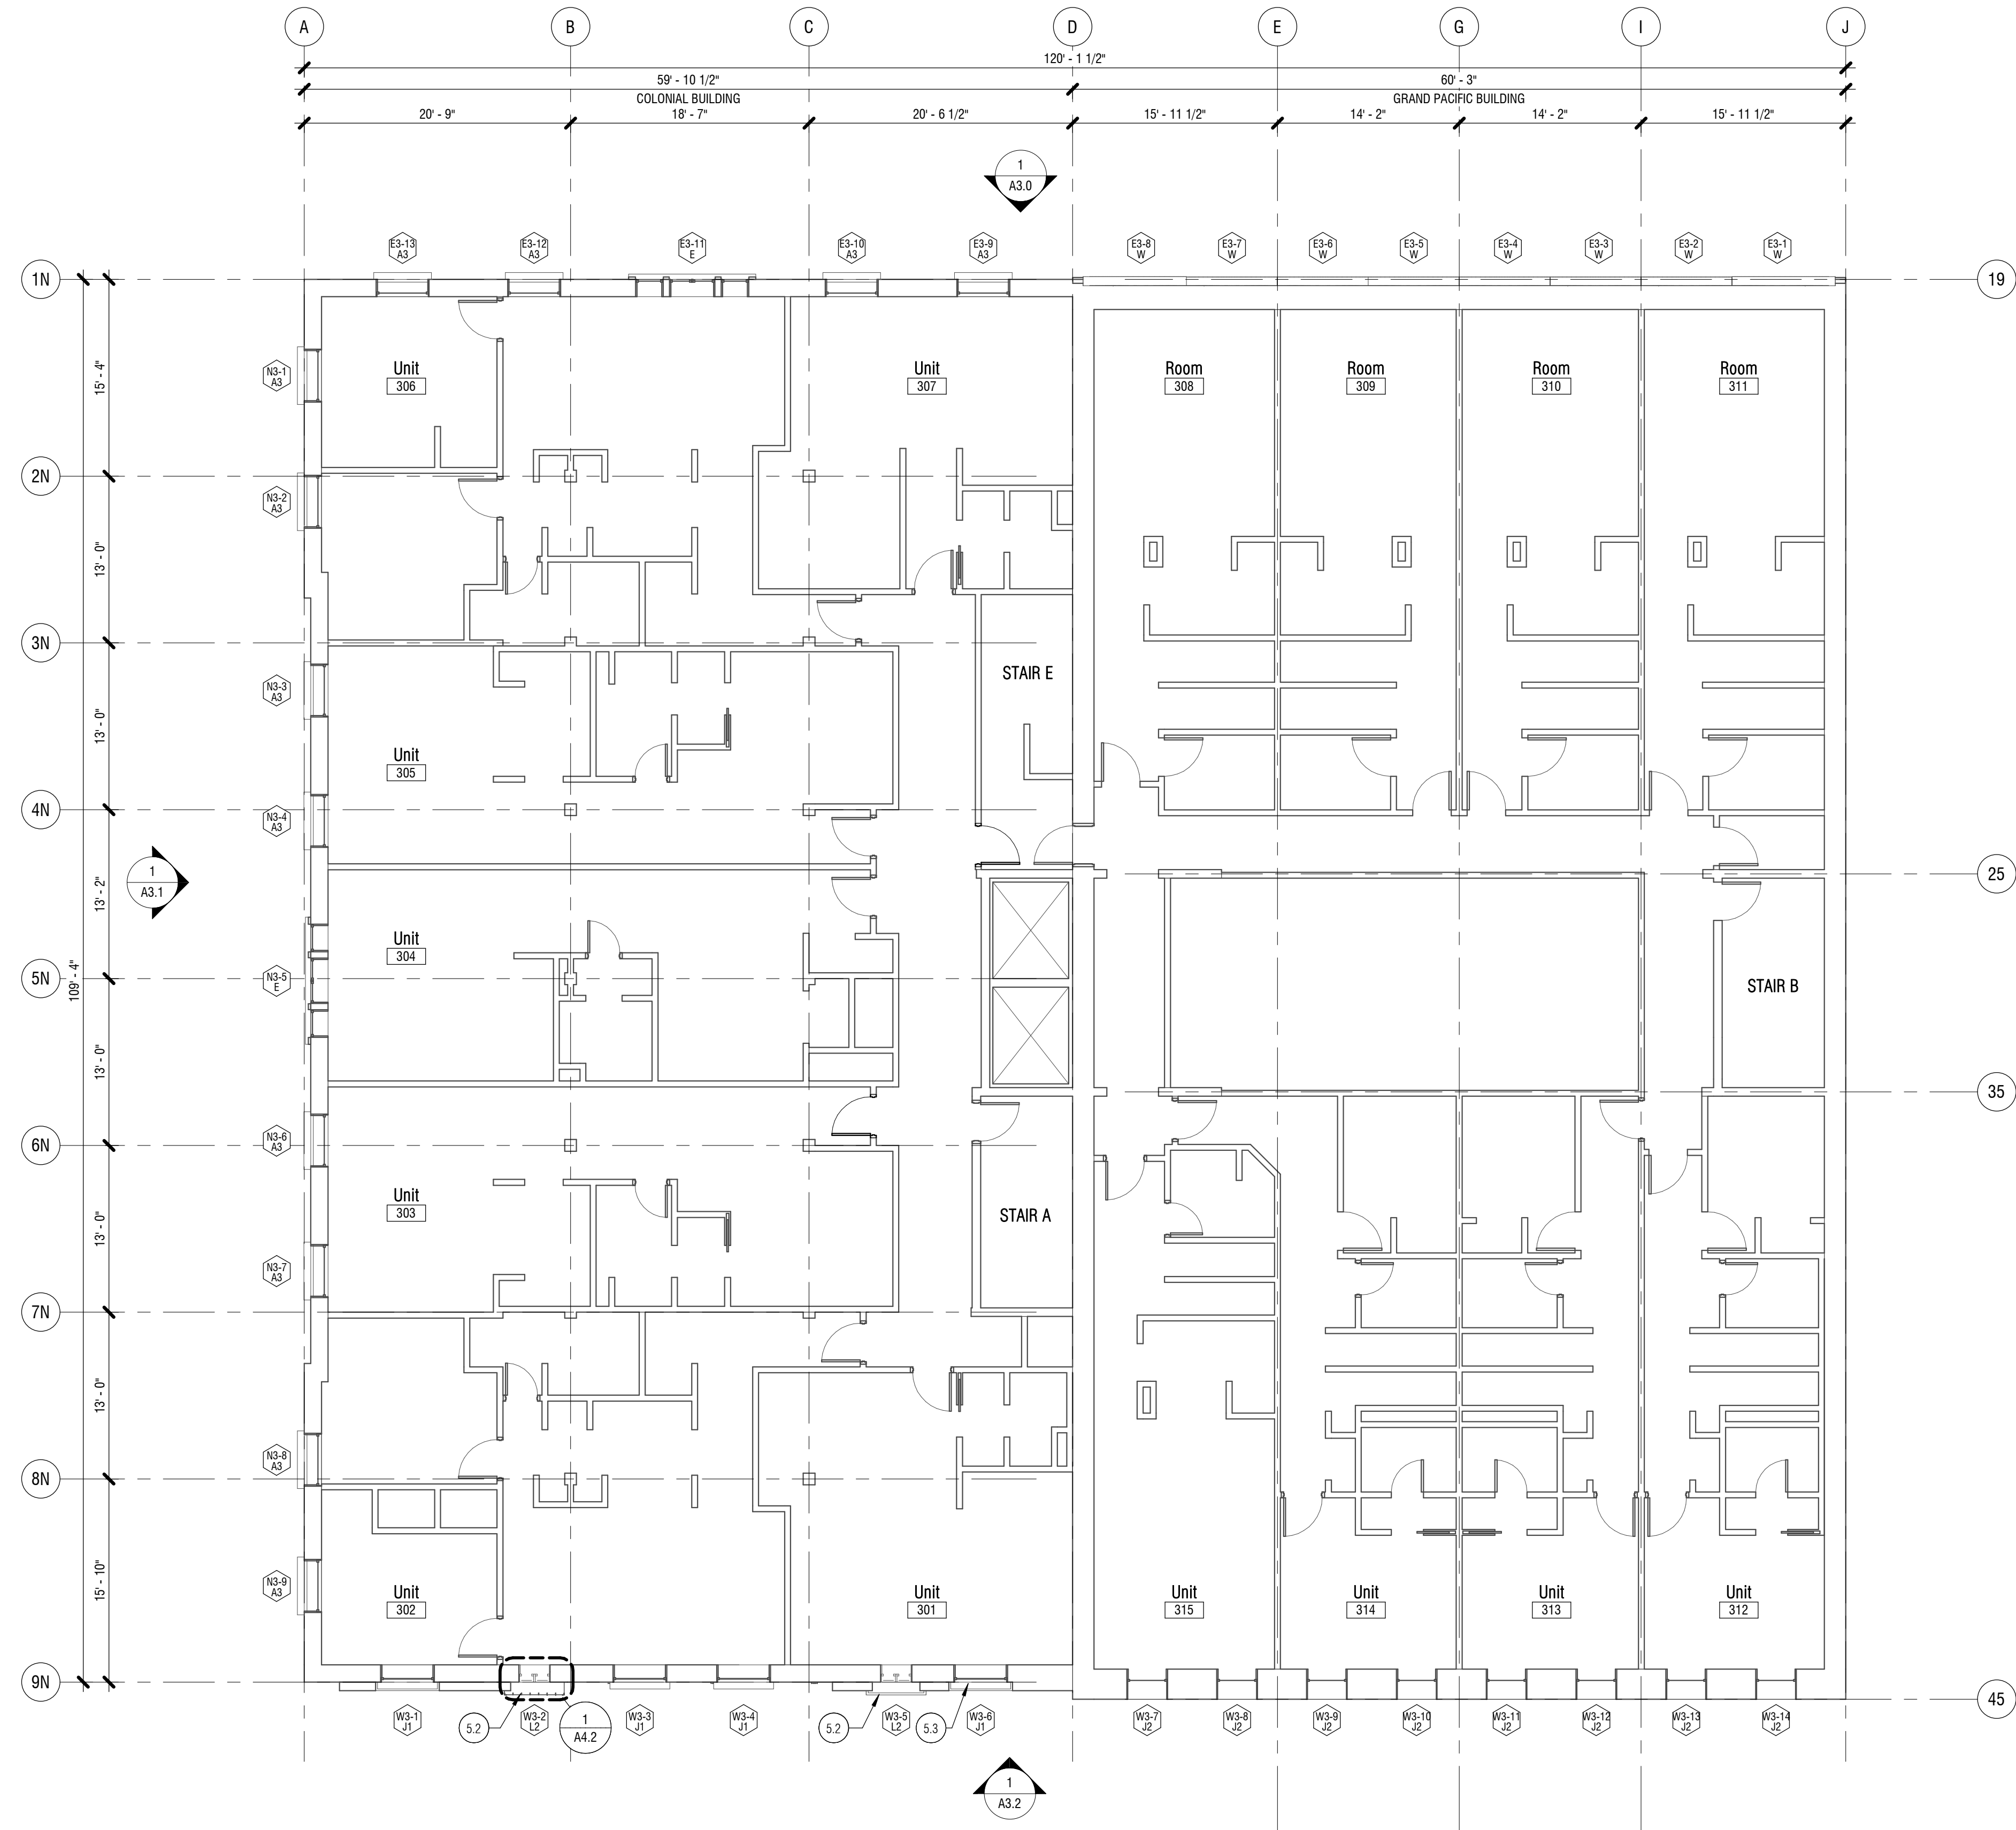
1 SECOND FLOOR PLAN
1/8" = 1'-0"



DCI APPROVAL STAMPS

NOT FOR CONSTRUCTION

SECOND FLOOR
PLAN
A2.6



| KEYNOTE LEGEND | |
|----------------|---|
| MARK | KEYNOTE TEXT |
| 5.2 | (E) STEEL BALCONY: REMOVE, RESTORE, MODIFY PER DETAILS, PREP AND PAINT, AND REINSTALL |
| 5.3 | (E) STEEL PLANT BALCONY: REMOVE, RESTORE, PREP AND PAINT, AND REINSTALL |

- PLAN NOTES:**
1. PROTECT LANDSCAPING, SIDEWALKS, AND SITE, TYP.
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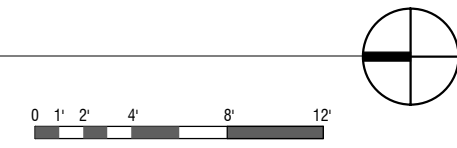
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PH: 206.675.9151
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THE COLONIAL
GRAND PACIFIC
FACADE
REPAIRS
PERMIT SET
1119 1ST AVE, SEATTLE, WA 98101

Drawn by: TD
Checked: MH
Date: 2/16/2021
Scale: As indicated
Revisions: No. Date Remarks

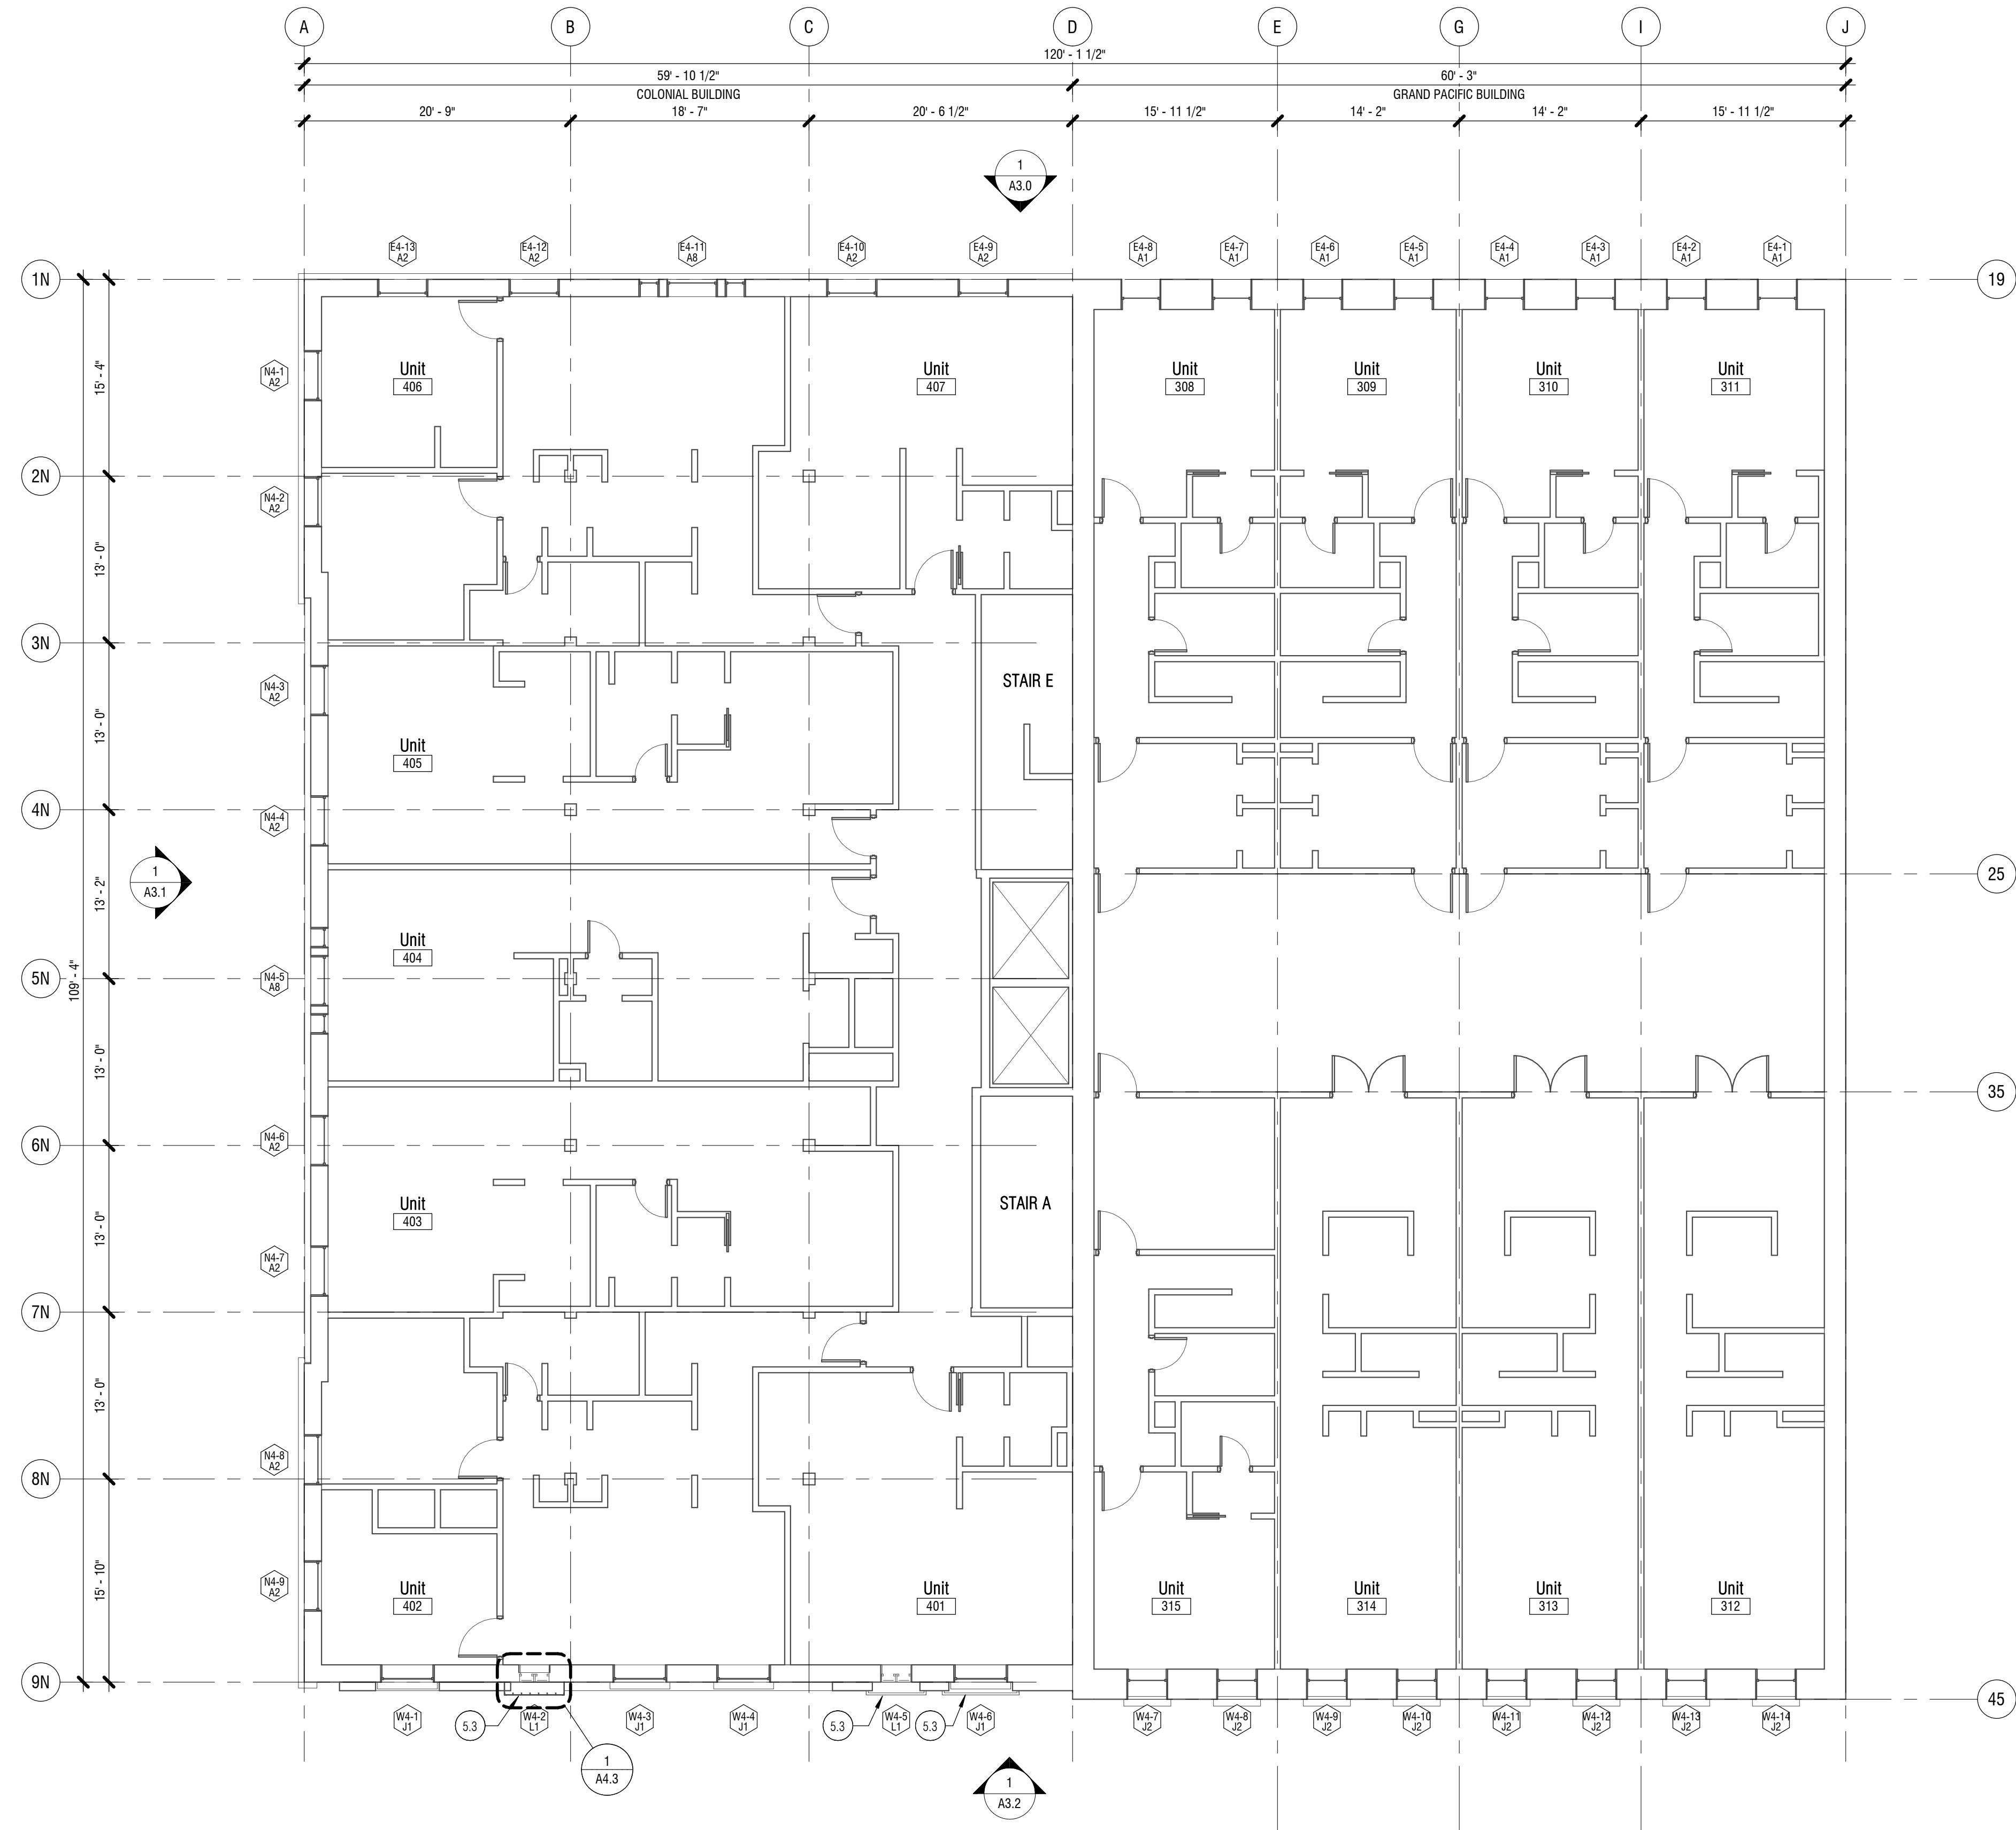
1 THIRD FLOOR PLAN
1/8" = 1'-0"



DCI APPROVAL STAMPS

NOT FOR CONSTRUCTION

THIRD FLOOR
PLAN
A2.7



| KEYNOTE LEGEND | |
|----------------|---|
| MARK | KEYNOTE TEXT |
| 5.3 | (E) STEEL PLANT BALCONY: REMOVE, RESTORE, PREP AND PAINT, AND REINSTALL |

- PLAN NOTES:**
1. PROTECT LANDSCAPING, SIDEWALKS, AND SITE, TYP.
 2. PROTECT EXISTING INTERIOR CIRCULATION ROUTES AND TENANT SPACES WHERE ACCESS IS PERMITTED BY CGP OWNER'S ASSOCIATION, TYP.
 3. PROVIDE TEMPORARY PROTECTION AT REMOVED WINDOWS, TO CONTAIN DUST, MINIMIZE OCCUPANT DISRUPTION, AND PREVENT WATER INFILTRATION, TYP.
 4. REFER TO SHEETS A2.10 AND A2.11 FOR WINDOW SCHEDULES, TYPES, AND RESTORATION SCOPE OF WORK.
 5. REFER TO SHEETS A4.0, A4.1, A4.2 AND A4.3 FOR BALCONY CONDITIONS AND REPAIR TREATMENTS.

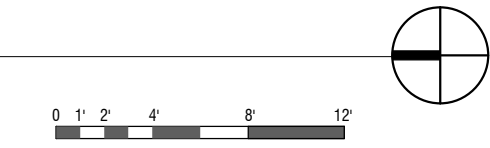
1050 N. 38th St.
Seattle, WA 98103
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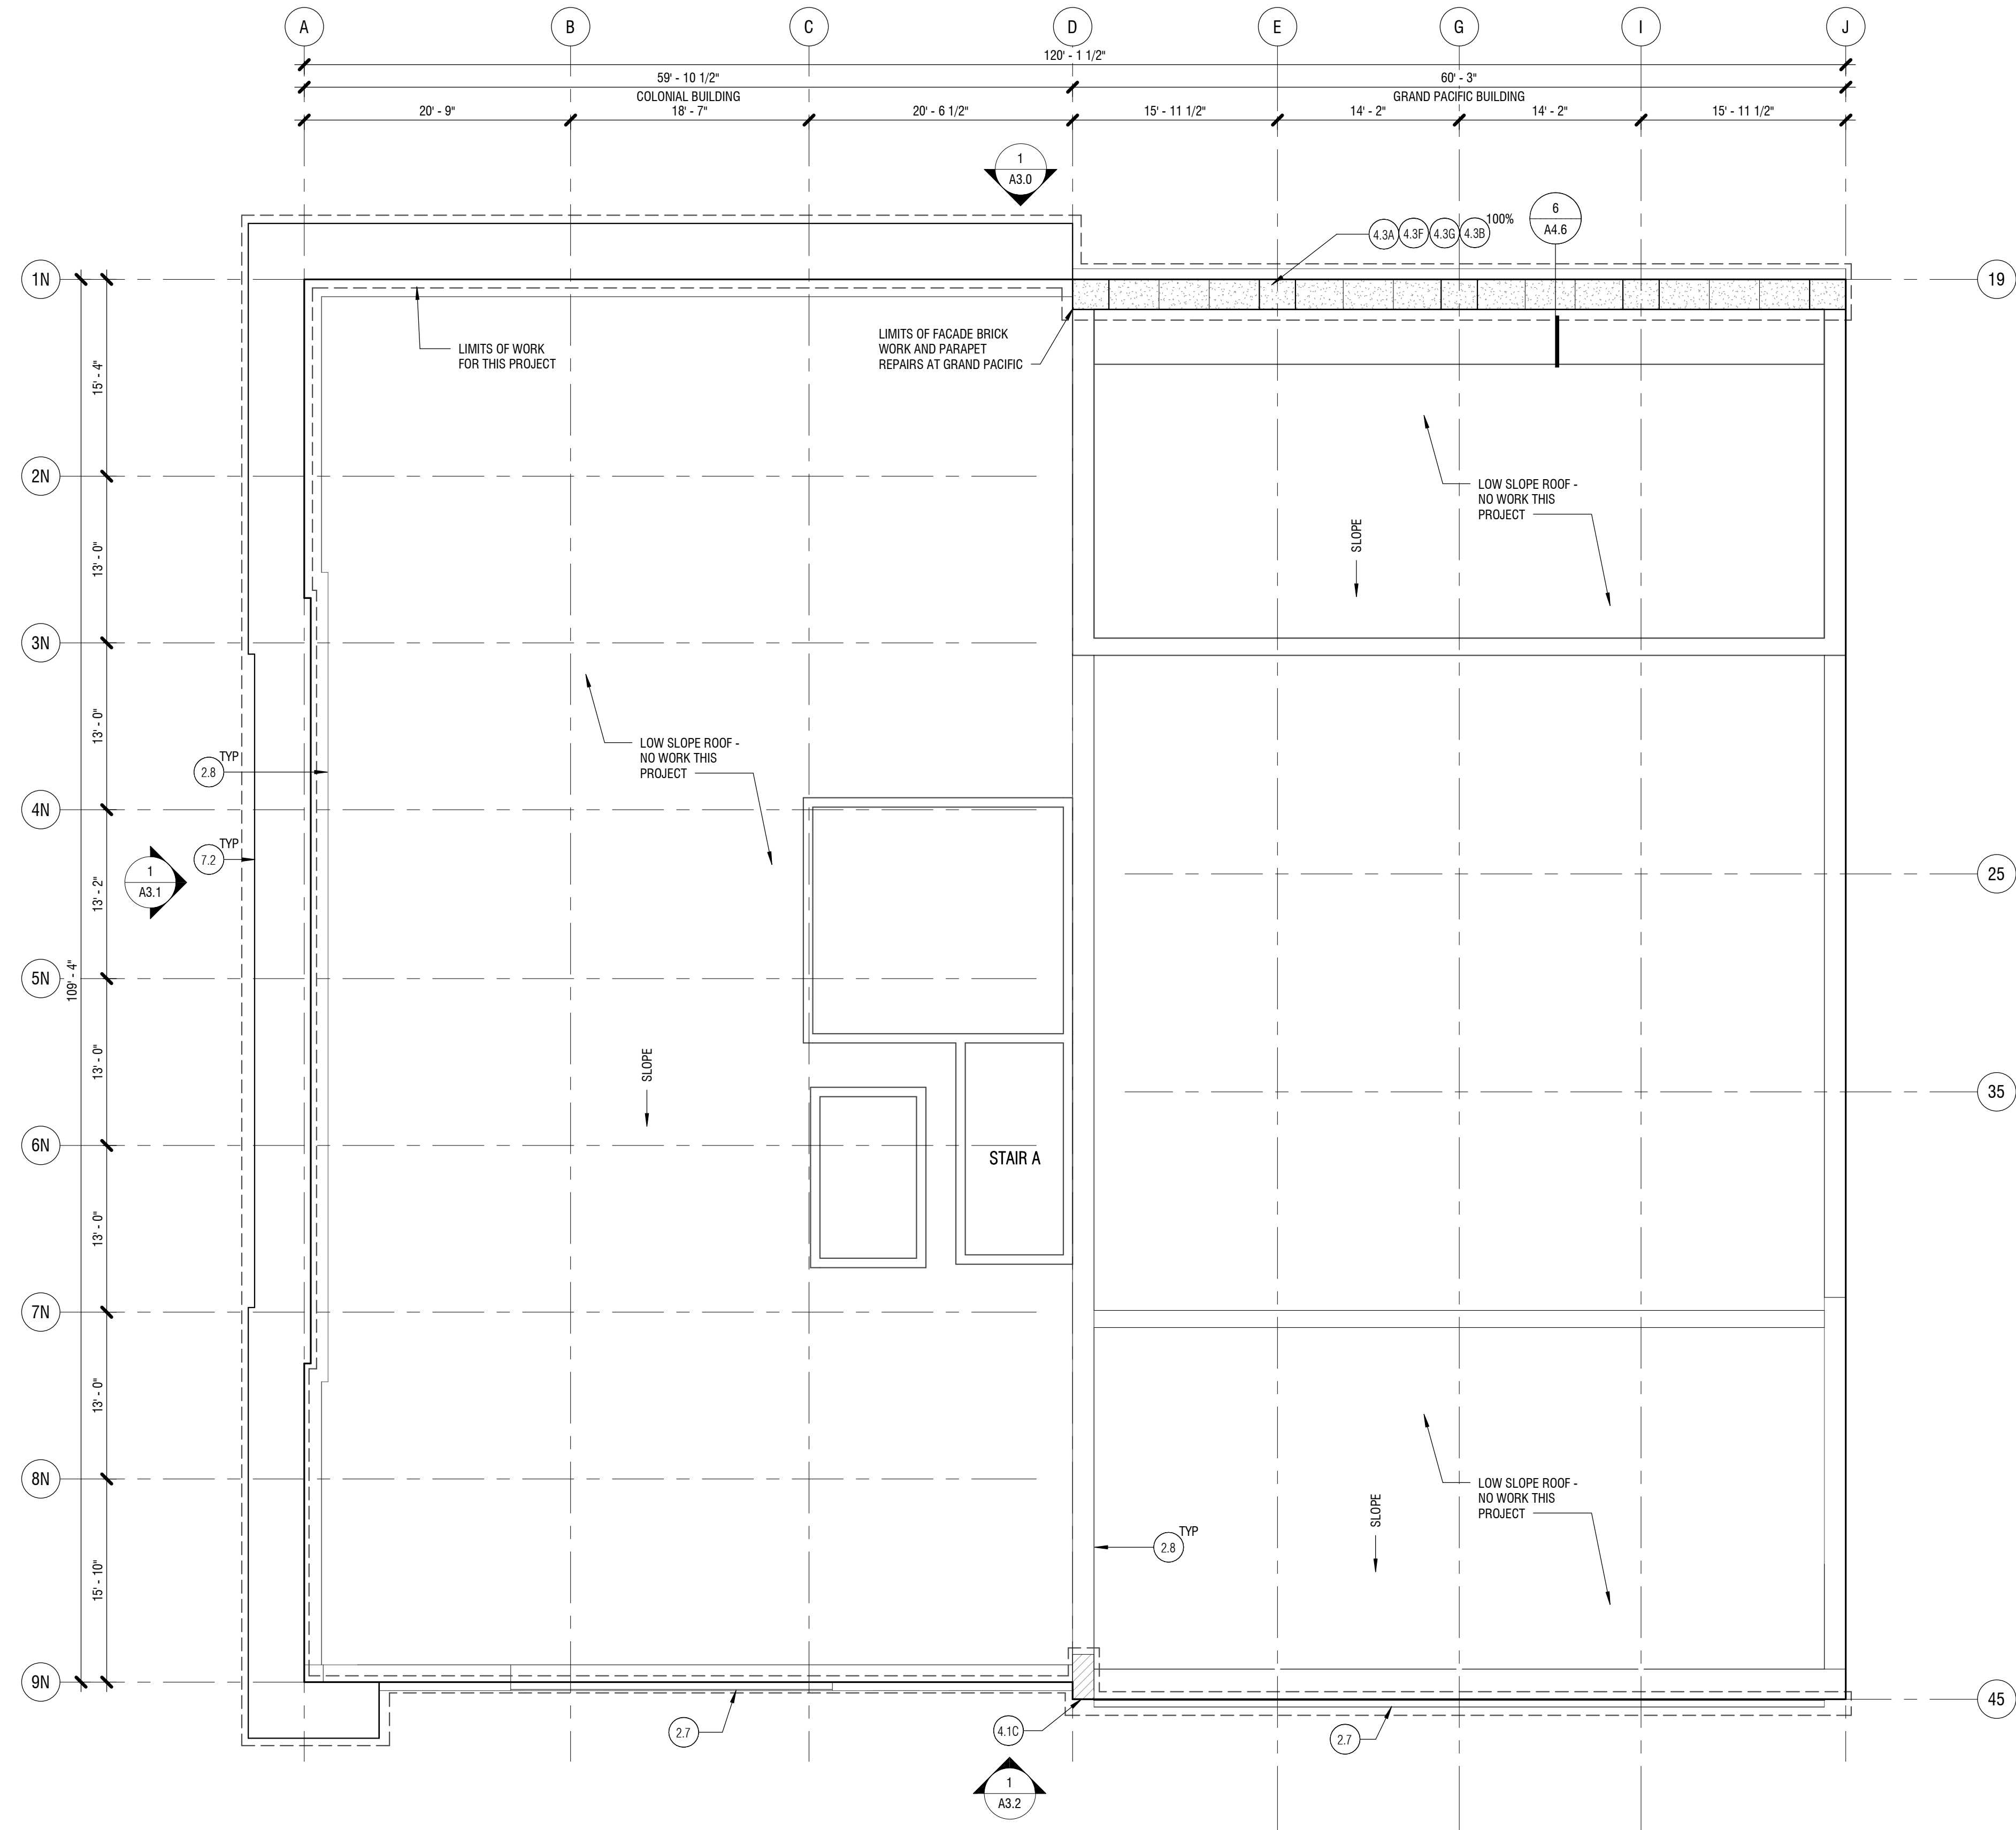
1 FOURTH FLOOR PLAN
1/8" = 1'-0"



DCI APPROVAL STAMPS


NOT FOR CONSTRUCTION

FOURTH FLOOR
PLAN
A2.8



| MARK | KEYNOTE TEXT |
|------|--|
| 2.7 | (E) METAL GUTTER: PROTECT |
| 2.8 | (E) METAL PARAPET COPING: PROTECT |
| 4.1C | (E) BRICK MASONRY: REMOVE AND REBUILD CORBELLED PARAPET END |
| 4.3A | (E) SANDSTONE: CLEAN 100% |
| 4.3B | (E) SANDSTONE: REPOINT (SEE KEYNOTE AREA FOR ASSUMED %) |
| 4.3F | (E) SANDSTONE: MODIFY COPING TO PROVIDE POSITIVE DRAINAGE AND PROTECT SKYFACING JOINTS |
| 4.3G | (E) SANDSTONE: APPLY LEAVE-ON BIOCIDES, TYP |
| 7.2 | (E) SHEET METAL CORNICE: SEAL AND REAFFIX OPENED JOINTS, PREP AND PAINT |


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Drawn by: TD
Checked: MH
Date: 2/16/2021
Scale: 1/8" = 1'-0"
Revisions: No. Date Remarks

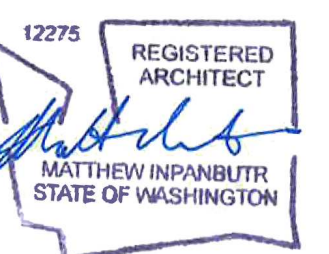1 ROOF PLAN
1/8" = 1'-0"



DCI APPROVAL STAMPS

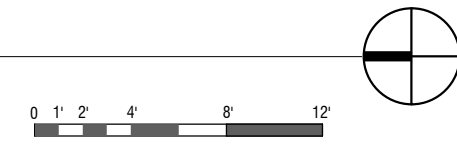NOT FOR CONSTRUCTION

ROOF PLAN
A2.9

EAST ELEVATION



WINDOW SCHEDULE

| WINDOW ID | WINDOW TYPE | UNIT # | NEW / RESTORED | OPERATION | WIDTH | HEIGHT | U-FACTOR | SHGC | INTERIOR WALL FINISH |
|-----------|-------------|--------|-----------------------|----------------------------|------------|-----------|----------|------|----------------------|
| (E) | Louvers NIC | - | Not In Scope | Louvers NIC | 4'-9" | 4'-9" | | | |
| (E) | Louvers NIC | - | Not In Scope | Louvers NIC | 4'-9" | 4'-9" | | | |
| (E) | Fixed NIC | - | Not In Scope | Fixed NIC | 2'-6" | 7'-0" | | | Brick, Common |
| E2-1 | C - A | 211 | New | Fixed Transom | 2'-0 1/4" | 2'-0 1/4" | 0.3 | 0.38 | Gypsum Wall Board |
| E2-1 | C - B | 211 | New | Fixed Transom | 2'-0 1/4" | 2'-0 1/4" | 0.3 | 0.38 | Gypsum Wall Board |
| E2-1 | C - D | 211 | New | Casement Outswing | 2'-0 1/4" | 5'-3 1/4" | 0.28 | 0.38 | Gypsum Wall Board |
| E2-1 | C - C | 211 | New | Casement Outswing | 2'-0 1/4" | 5'-3 1/4" | 0.28 | 0.38 | Gypsum Wall Board |
| E2-2 | C - A | 211 | New | Fixed Transom | 2'-0 1/4" | 2'-0 1/4" | 0.3 | 0.38 | Gypsum Wall Board |
| E2-2 | C - B | 211 | New | Fixed Transom | 2'-0 1/4" | 2'-0 1/4" | 0.3 | 0.38 | Gypsum Wall Board |
| E2-2 | C - D | 211 | New | Casement Outswing | 2'-0 1/4" | 5'-3 1/4" | 0.28 | 0.38 | Gypsum Wall Board |
| E2-2 | C - C | 211 | New | Casement Outswing | 2'-0 1/4" | 5'-3 1/4" | 0.28 | 0.38 | Gypsum Wall Board |
| E2-3 | C - A | 210 | New | Fixed Transom | 2'-0 1/4" | 2'-0 1/4" | 0.3 | 0.38 | |
| E2-3 | C - B | 210 | New | Fixed Transom | 2'-0 1/4" | 2'-0 1/4" | 0.3 | 0.38 | |
| E2-3 | C - D | 210 | New | Casement Outswing | 2'-0 1/4" | 5'-3 1/4" | 0.28 | 0.38 | |
| E2-3 | C - C | 210 | New | Casement Outswing | 2'-0 1/4" | 5'-3 1/4" | 0.28 | 0.38 | |
| E2-4 | C - A | 210 | New | Fixed Transom | 2'-0 1/4" | 2'-0 1/4" | 0.3 | 0.38 | |
| E2-4 | C - B | 210 | New | Fixed Transom | 2'-0 1/4" | 2'-0 1/4" | 0.3 | 0.38 | |
| E2-4 | C - D | 210 | New | Casement Outswing | 2'-0 1/4" | 5'-3 1/4" | 0.28 | 0.38 | |
| E2-4 | C - C | 210 | New | Casement Outswing | 2'-0 1/4" | 5'-3 1/4" | 0.28 | 0.38 | |
| E2-5 | C - A | 209 | New | Fixed Transom | 2'-0 1/4" | 2'-0 1/4" | 0.3 | 0.38 | |
| E2-5 | C - B | 209 | New | Fixed Transom | 2'-0 1/4" | 2'-0 1/4" | 0.3 | 0.38 | |
| E2-5 | C - D | 209 | New | Casement Outswing | 2'-0 1/4" | 5'-3 1/4" | 0.28 | 0.38 | |
| E2-5 | C - C | 209 | New | Casement Outswing | 2'-0 1/4" | 5'-3 1/4" | 0.28 | 0.38 | |
| E2-6 | C - A | 209 | New | Fixed Transom | 2'-0 1/4" | 2'-0 1/4" | 0.3 | 0.38 | |
| E2-6 | C - B | 209 | New | Fixed Transom | 2'-0 1/4" | 2'-0 1/4" | 0.3 | 0.38 | |
| E2-6 | C - D | 209 | New | Casement Outswing | 2'-0 1/4" | 5'-3 1/4" | 0.28 | 0.38 | |
| E2-6 | C - C | 209 | New | Casement Outswing | 2'-0 1/4" | 5'-3 1/4" | 0.28 | 0.38 | |
| E2-7 | C - A | 208 | New | Fixed Transom | 2'-0 1/4" | 2'-0 1/4" | 0.3 | 0.38 | |
| E2-7 | C - B | 208 | New | Fixed Transom | 2'-0 1/4" | 2'-0 1/4" | 0.3 | 0.38 | |
| E2-7 | C - D | 208 | New | Casement Outswing | 2'-0 1/4" | 5'-3 1/4" | 0.28 | 0.38 | |
| E2-7 | C - C | 208 | New | Casement Outswing | 2'-0 1/4" | 5'-3 1/4" | 0.28 | 0.38 | |
| E2-8 | C - A | 208 | New | Fixed Transom | 2'-0 1/4" | 2'-0 1/4" | 0.3 | 0.38 | |
| E2-8 | C - B | 208 | New | Fixed Transom | 2'-0 1/4" | 2'-0 1/4" | 0.3 | 0.38 | |
| E2-8 | C - D | 208 | New | Casement Outswing | 2'-0 1/4" | 5'-3 1/4" | 0.28 | 0.38 | |
| E2-8 | C - C | 208 | New | Casement Outswing | 2'-0 1/4" | 5'-3 1/4" | 0.28 | 0.38 | |
| E2-9 | F - C | 207 | New | French Door Pair Inswing | 4'-0 1/4" | 6'-7 1/4" | 0.28 | 0.38 | Gypsum Wall Board |
| E2-9 | F - A | 207 | New | Transom Hopper | 1'-11 3/4" | 2'-0 1/4" | 0.28 | 0.38 | Gypsum Wall Board |
| E2-9 | F - B | 207 | New | Fixed Transom | 1'-11 3/4" | 2'-0 1/4" | 0.3 | 0.38 | Gypsum Wall Board |
| E2-10 | F - C | 207 | New | French Door Pair Inswing | 4'-0 1/4" | 6'-7 1/4" | 0.28 | 0.38 | Gypsum Wall Board |
| E2-10 | F - A | 207 | New | Transom Hopper | 1'-11 3/4" | 2'-0 1/4" | 0.28 | 0.38 | Gypsum Wall Board |
| E2-10 | F - B | 207 | New | Fixed Transom | 1'-11 3/4" | 2'-0 1/4" | 0.3 | 0.38 | Gypsum Wall Board |
| E2-11 | G - A | 206 | New | Fixed Transom | 2'-0 1/2" | 2'-1" | 0.28 | 0.38 | Gypsum Wall Board |
| E2-11 | G - D | 206 | New | Fixed Transom | 1'-11 3/4" | 2'-1" | 0.3 | 0.38 | Gypsum Wall Board |
| E2-11 | G - E | 206 | New | Fixed | 2'-0 1/2" | 6'-8 1/2" | 0.3 | 0.38 | Gypsum Wall Board |
| E2-11 | G - G | 206 | New | Fixed | 2'-0 1/2" | 6'-8 1/2" | 0.3 | 0.38 | Gypsum Wall Board |
| E2-11 | G - B | 206 | New | Fixed Transom | 1'-7 3/4" | 2'-1" | 0.3 | 0.38 | Gypsum Wall Board |
| E2-11 | G - C | 206 | New | Fixed Transom | 1'-7 3/4" | 2'-1" | 0.3 | 0.38 | Gypsum Wall Board |
| E2-11 | G - F | 206 | New | French Door Pair Inswing | 3'-3 1/2" | 6'-8 1/2" | 0.28 | 0.38 | Gypsum Wall Board |
| E2-12 | F - C | 206 | New | French Door Pair Inswing | 4'-0 1/4" | 6'-7 1/4" | 0.28 | 0.38 | Gypsum Wall Board |
| E2-12 | F - A | 206 | New | Transom Hopper | 1'-11 3/4" | 2'-0 1/4" | 0.28 | 0.38 | Gypsum Wall Board |
| E2-12 | F - B | 206 | New | Fixed Transom | 1'-11 3/4" | 2'-0 1/4" | 0.3 | 0.38 | Gypsum Wall Board |
| E2-13 | F - C | 206 | New | French Door Pair Inswing | 4'-0 1/4" | 6'-7 1/4" | 0.28 | 0.38 | Gypsum Wall Board |
| E2-13 | F - A | 206 | New | Transom Hopper | 1'-11 3/4" | 2'-0 1/4" | 0.28 | 0.38 | Gypsum Wall Board |
| E2-13 | F - B | 206 | New | Fixed Transom | 1'-11 3/4" | 2'-0 1/4" | 0.3 | 0.38 | Gypsum Wall Board |
| E3-1 | B - C | 311 | New | Casement Outswing | 2'-2" | 3'-11" | 0.28 | 0.38 | Gypsum Wall Board |
| E3-1 | B - B | 311 | New | Casement Outswing | 2'-2" | 3'-11" | 0.28 | 0.38 | Gypsum Wall Board |
| E3-1 | B - A | 311 | New | Fixed Transom Arched | 4'-4" | 2'-8 1/4" | 0.3 | 0.38 | Gypsum Wall Board |
| E3-2 | B - B | 311 | New | Casement Outswing | 2'-2" | 3'-11" | 0.28 | 0.38 | Gypsum Wall Board |
| E3-2 | B - C | 311 | New | Casement Outswing | 2'-2" | 3'-11" | 0.28 | 0.38 | Gypsum Wall Board |
| E3-2 | B - A | 311 | New | Fixed Transom Arched | 4'-4" | 2'-8 1/4" | 0.3 | 0.38 | Gypsum Wall Board |
| E3-3 | B - B | 310 | New | Casement Outswing | 2'-2" | 3'-11" | 0.28 | 0.38 | Gypsum Wall Board |
| E3-3 | B - C | 310 | New | Casement Outswing | 2'-2" | 3'-11" | 0.28 | 0.38 | Gypsum Wall Board |
| E3-3 | B - A | 310 | New | Fixed Transom Arched | 4'-4" | 2'-8 1/4" | 0.3 | 0.38 | Gypsum Wall Board |
| E3-4 | B - B | 310 | New | Casement Outswing | 2'-2" | 3'-11" | 0.28 | 0.38 | Gypsum Wall Board |
| E3-4 | B - C | 310 | New | Casement Outswing | 2'-2" | 3'-11" | 0.28 | 0.38 | Gypsum Wall Board |
| E3-4 | B - A | 310 | New | Fixed Transom Arched | 4'-4" | 2'-8 1/4" | 0.3 | 0.38 | Gypsum Wall Board |
| E3-5 | B - B | 309 | New | Casement Outswing | 2'-2" | 3'-11" | 0.28 | 0.38 | Gypsum Wall Board |
| E3-5 | B - C | 309 | New | Casement Outswing | 2'-2" | 3'-11" | 0.28 | 0.38 | Gypsum Wall Board |
| E3-5 | B - A | 309 | New | Fixed Transom Arched | 4'-4" | 2'-8 1/4" | 0.3 | 0.38 | Gypsum Wall Board |
| E3-6 | B - B | 309 | New | Casement Outswing | 2'-2" | 3'-11" | 0.28 | 0.38 | Gypsum Wall Board |
| E3-6 | B - C | 309 | New | Casement Outswing | 2'-2" | 3'-11" | 0.28 | 0.38 | Gypsum Wall Board |
| E3-6 | B - A | 309 | New | Fixed Transom Arched | 4'-4" | 2'-8 1/4" | 0.3 | 0.38 | Gypsum Wall Board |
| E3-7 | B - B | 308 | New | Casement Outswing | 2'-2" | 3'-11" | 0.28 | 0.38 | Gypsum Wall Board |
| E3-7 | B - C | 308 | New | Casement Outswing | 2'-2" | 3'-11" | 0.28 | 0.38 | Gypsum Wall Board |
| E3-7 | B - A | 308 | New | Fixed Transom Arched | 4'-4" | 2'-8 1/4" | 0.3 | 0.38 | Gypsum Wall Board |
| E3-8 | B - B | 308 | New | Casement Outswing | 2'-2" | 3'-11" | 0.28 | 0.38 | Gypsum Wall Board |
| E3-8 | B - C | 308 | New | Casement Outswing | 2'-2" | 3'-11" | 0.28 | 0.38 | Gypsum Wall Board |
| E3-8 | B - A | 308 | New | Fixed Transom Arched | 4'-4" | 2'-8 1/4" | 0.3 | 0.38 | Gypsum Wall Board |
| E3-9 | A3 | 307 | New | Double Hung | 4'-1 1/2" | 6'-7" | 0.28 | 0.38 | |
| E3-10 | A3 | 307 | New | Double Hung | 4'-1 1/2" | 6'-7" | 0.28 | 0.38 | |
| E3-11 | E - B | 306 | Restored W/ Int Storm | Leaded Glass Fixed Transom | 3'-0" | 6'-0" | | 0.38 | Gypsum Wall Board |
| E3-11 | E - D | 306 | Restored W/ Int Storm | Leaded Glass Fixed | 2'-1 3/4" | 4'-6 3/4" | | 0.38 | Gypsum Wall Board |
| E3-11 | E - F | 306 | Restored W/ Int Storm | Leaded Glass Fixed | 2'-1 3/4" | 4'-6 3/4" | | 0.38 | Gypsum Wall Board |
| E3-11 | E - A | 306 | Restored W/ Int Storm | Leaded Glass Fixed Transom | 4'-0" | | | 0.38 | Gypsum Wall Board |
| E3-11 | E - C | 306 | Restored W/ Int Storm | Leaded Glass Fixed Transom | 4'-0" | | | 0.38 | Gypsum Wall Board |
| E3-11 | E - E | 306 | New | Casement Pair Outswing | 3'-6 1/2" | 4'-6 3/4" | 0.28 | 0.38 | Gypsum Wall Board |
| E3-12 | A3 | 306 | New | Double Hung | 4'-1 1/2" | 6'-7" | 0.28 | 0.38 | |
| E3-13 | A3 | 306 | New | Double Hung | 4'-1 1/2" | 6'-7" | 0.28 | 0.38 | Gypsum Wall Board |
| E4-1 | A1 | 311 | New | Double Hung | 3'-1 1/4" | 7'-2" | 0.28 | 0.38 | |
| E4-3 | A1 | 310 | New | Double Hung | 3'-1 1/4" | 7'-2" | 0.28 | 0.38 | |
| E4-4 | A1 | 310 | New | Double Hung | 3'-1 1/4" | 7'-2" | 0.28 | 0.38 | |
| E4-5 | A1 | 309 | New | Double Hung | 3'-1 1/4" | 7'-2" | 0.28 | 0.38 | Gypsum Wall Board |
| E4-6 | A1 | 309 | New | Double Hung | 3'-1 1/4" | 7'-2" | 0.28 | 0.38 | Gypsum Wall Board |
| E4-7 | A1 | 308 | New | Double Hung | 3'-1 1/4" | 7'-2" | 0.28 | 0.38 | |
| E4-8 | A1 | 308 | New | Double Hung | 3'-1 1/4" | 7'-2" | 0.28 | 0.38 | |
| E4-9 | A2 | 407 | New | Double Hung | 3'-11" | 5'-5 1/2" | 0.28 | 0.38 | |
| E4-10 | A2 | 407 | New | Double Hung | 3'-11" | 5'-5 1/2" | 0.28 | 0.38 | |
| E4-11 | D - C | 406 | New | Double Hung | 1'-7" | 5'-5" | 0.28 | 0.38 | Gypsum Wall Board |
| E4-11 | D - A | 406 | New | Double Hung | 1'-7" | 5'-5" | 0.28 | 0.38 | Gypsum Wall Board |
| E4-11 | D - B | 406 | New | Double Hung | 3'-11 1/4" | 5'-5" | 0.28 | 0.38 | Gypsum Wall Board |
| E4-12 | A2 | 406 | New | Double Hung | 3'-11" | 5'-5 1/2" | 0.28 | 0.38 | Gypsum Wall Board |
| E4-13 | A2 | 406 | New | Double Hung | 3'-11" | 5'-5 1/2" | 0.28 | 0.38 | Gypsum Wall Board |


NORTH ELEVATION

WINDOW SCHEDULE


| WINDOW ID | WINDOW TYPE | UNIT # | NEW / RESTORED | OPERATION | WIDTH | HEIGHT | U-FACTOR | SHGC | INTERIOR WALL FINISH |
|-----------|-------------|--------|----------------|--------------------------|------------|-----------|----------|------|----------------------|
| N1-1 | H | COMM | New | Fixed | 3'-11" | 4'-6" | 0.3 | 0.51 | Brick, Common |
| N1-2 | H | COMM | New | Fixed | 3'-11" | 4'-6" | 0.3 | 0.51 | Brick, Common |
| N1-3 | I - A | COMM | New | Fixed | 2'-9" | 4'-6" | 0.3 | 0.51 | Brick, Common |
| N1-3 | I - B | COMM | New | Fixed | 2'-9" | 4'-6" | 0.3 | 0.51 | Brick, Common |
| N1-3 | I - C | COMM | New | Fixed | 2'-9" | 4'-6" | 0.3 | 0.51 | Brick, Common |
| N1-4 | H | COMM | New | Fixed | 3'-11" | 4'-6" | 0.3 | 0.51 | Brick, Common |
| N1-5 | H | COMM | New | Fixed | 3'-11" | 4'-6" | 0.3 | 0.51 | Brick, Common |
| N2-1 | F - A | 206 | New | Transom Hopper | 1'-11 3/4" | 2'-0 1/4" | 0.3 | 0.51 | Gypsum Wall Board |
| N2-1 | F - B | 206 | New | Fixed Transom | 1'-11 3/4" | 2'-0 1/4" | 0.28 | 0.51 | Gypsum Wall Board |
| N2-1 | F - C | 206 | New | French Door Pair Inswing | 4'-0 1/4" | 6'-7 1/4" | 0.28 | 0.51 | Gypsum Wall Board |
| N2-2 | F - A | 206 | New | Transom Hopper | 1'-11 3/4" | 2'-0 1/4" | 0.28 | 0.51 | Gypsum Wall Board |
| N2-2 | F - B | 206 | New | Fixed Transom | 1'-11 3/4" | 2'-0 1/4" | 0.3 | 0.51 | Gypsum Wall Board |
| N2-2 | F - C | 206 | New | French Door Pair Inswing | 4'-0 1/4" | 6'-7 1/4" | 0.28 | 0.51 | Gypsum Wall Board |
| N2-3 | F - A | 205 | New | Transom Hopper | 1'-11 3/4" | 2'-0 1/4" | 0.28 | 0.51 | Brick, Common |
| N2-3 | F - B | 205 | New | Fixed Transom | 1'-11 3/4" | 2'-0 1/4" | 0.3 | 0.51 | Brick, Common |
| N2-3 | F - C | 205 | New | French Door Pair Inswing | 4'-0 1/4" | 6'-7 1/4" | 0.28 | 0.51 | Brick, Common |
| N2-4 | F - A | 205 | New | Transom Hopper | 1'-11 3/4" | 2'-0 1/4" | 0.28 | 0.51 | Brick, Common |
| N2-4 | F - B | 205 | New | Fixed Transom | 1'-11 3/4" | 2'-0 1/4" | 0.3 | 0.51 | Brick, Common |
| N2-4 | F - C | 205</ | | | | | | | |

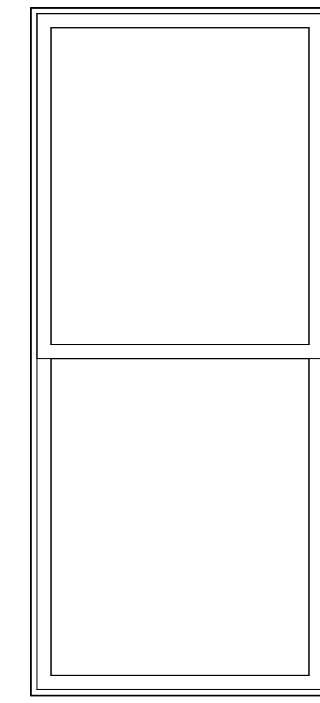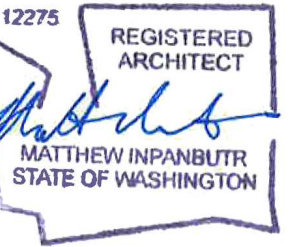


DOUBLE HUNG

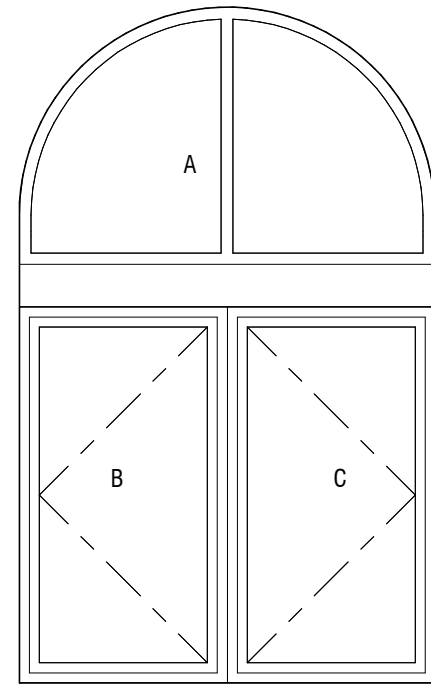

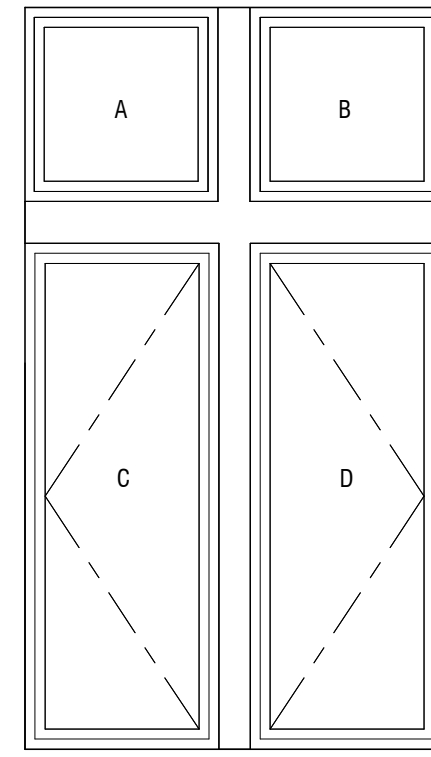
A - FIXED ARCHTOP
B - CASEMENT
C - CASEMENT



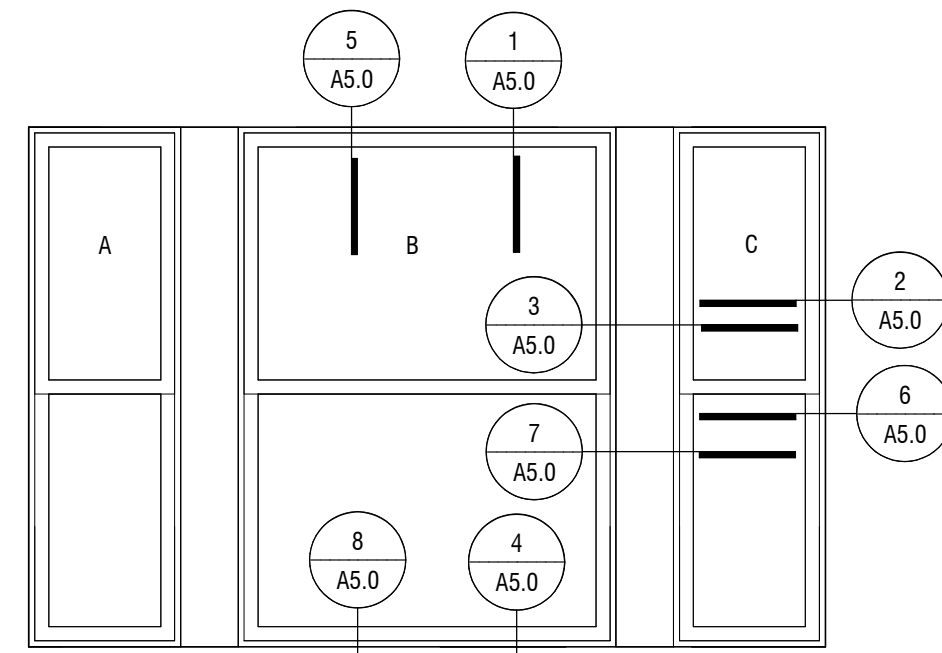
A - FIXED TRANSOM
B - FIXED TRANSOM
C - CASEMENT
D - CASEMENT



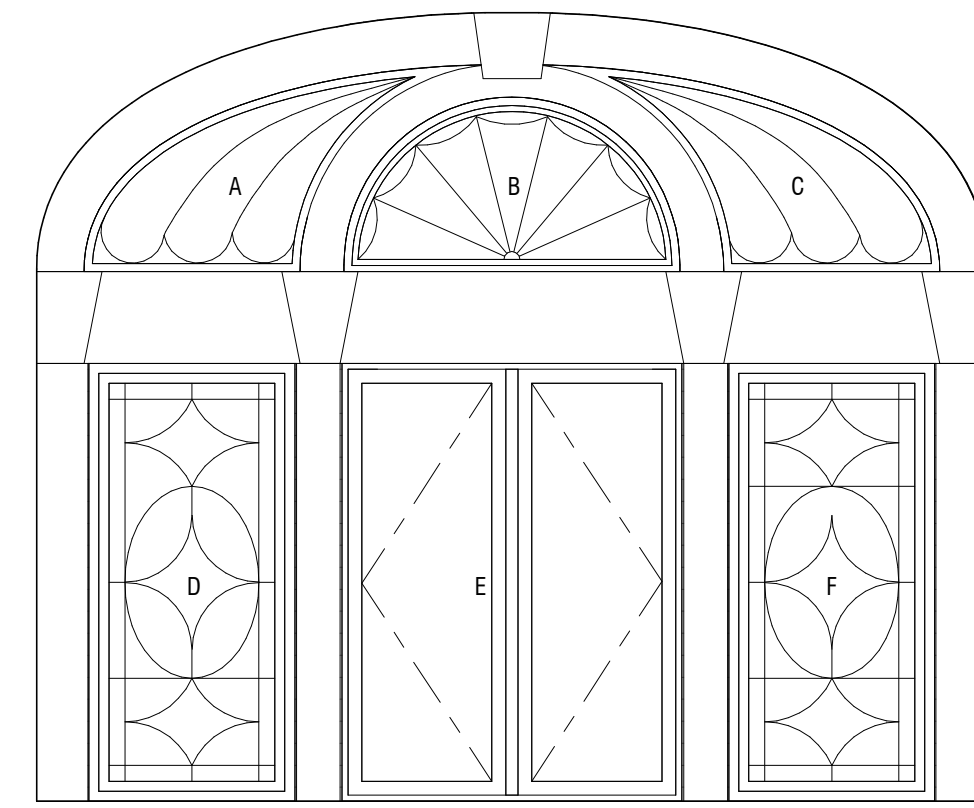A - DOUBLE HUNG
B - DOUBLE HUNG
C - DOUBLE HUNG



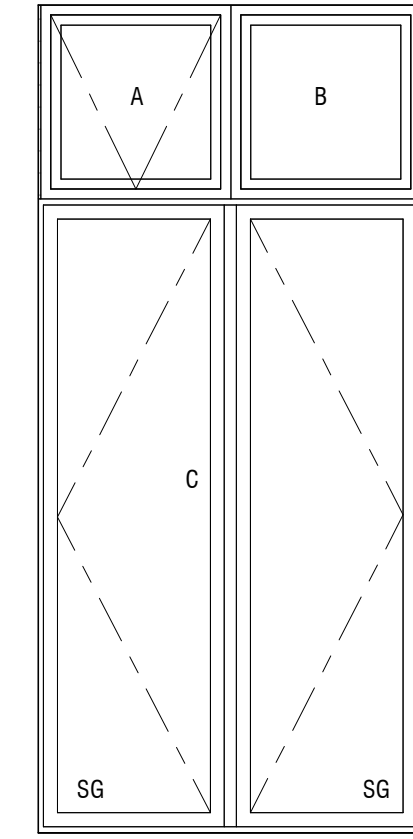A - FIXED ARCH LEADED GLASS - RESTORE
B - FIXED ARCH LEADED GLASS - RESTORE
C - FIXED ARCH LEADED GLASS - RESTORE
D - FIXED LEADED GLASS - RESTORE
E - CASEMENT PAIR
F - FIXED LEADED GLASS - RESTORE



A - HOPPER TRANSOM
B - FIXED TRANSOM
C - CASEMENT PAIR

1 WINDOW TYPE A1-A5
1/2" = 1'-0"

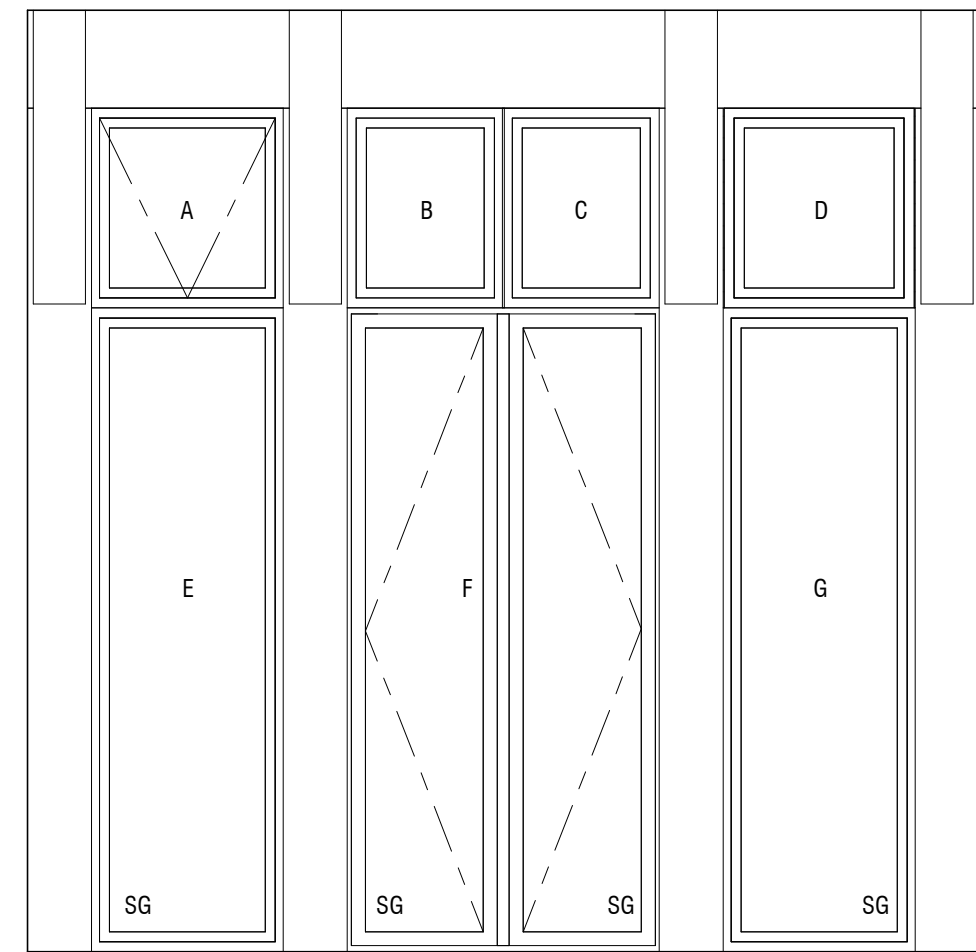
2 WINDOW TYPE B
1/2" = 1'-0"

3 WINDOW TYPE C
1/2" = 1'-0"


4 WINDOW TYPE D
1/2" = 1'-0"

5 WINDOW TYPE E
1/2" = 1'-0"


6 WINDOW TYPE F
1/2" = 1'-0"



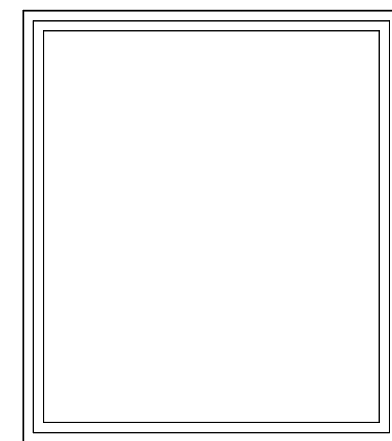
A - HOPPER TRANSOM
B - FIXED TRANSOM
C - FIXED TRANSOM
D - FIXED TRANSOM
E - FIXED
F - CASEMENT PAIR
G - FIXED




FIXED

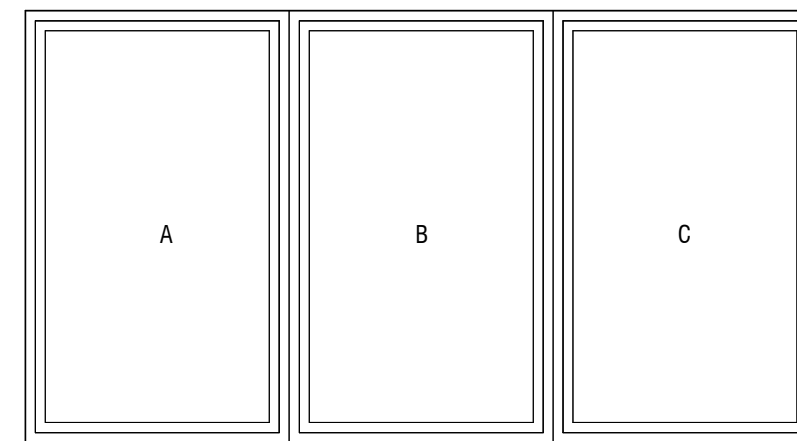


A - FIXED
B - FIXED
C - FIXED

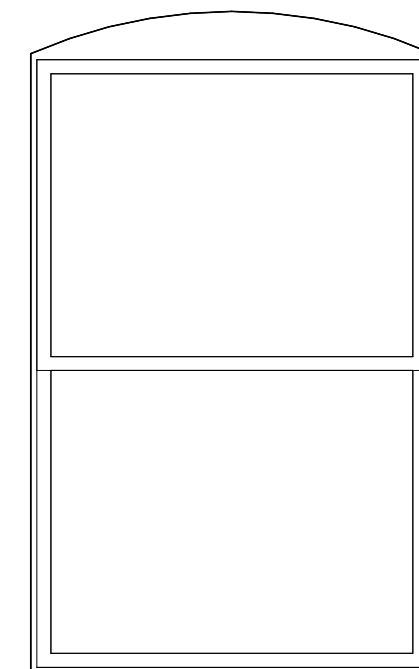

DOUBLE HUNG WITH ARCH TOP

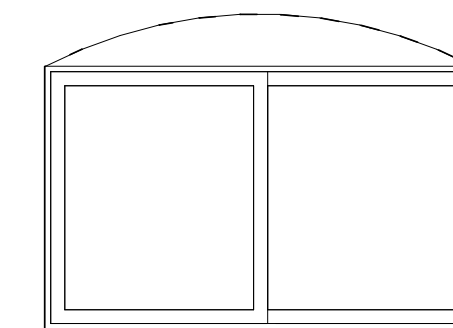

FIXED WITH ARCH TOP

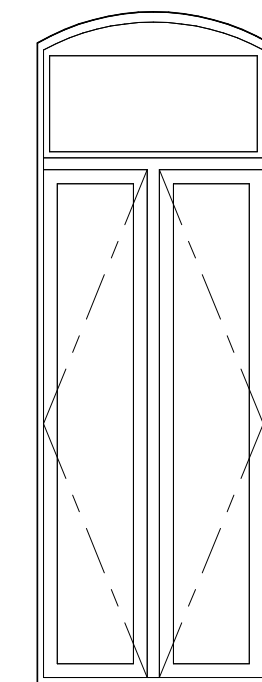

FIXED TRANSOM WITH ARCH TOP OVER CASEMENT PAIR

7 WINDOW TYPE G
1/2" = 1'-0"

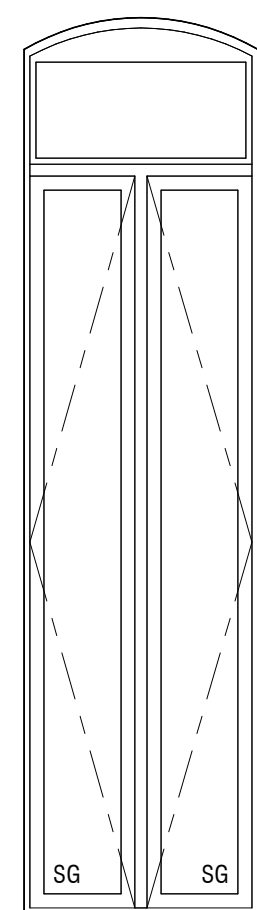
8 WINDOW TYPE H
1/2" = 1'-0"

9 WINDOW TYPE I
1/2" = 1'-0"


10 WINDOW TYPE J1-J3
1/2" = 1'-0"

11 WINDOW TYPE K
1/2" = 1'-0"


12 WINDOW TYPE L1
1/2" = 1'-0"



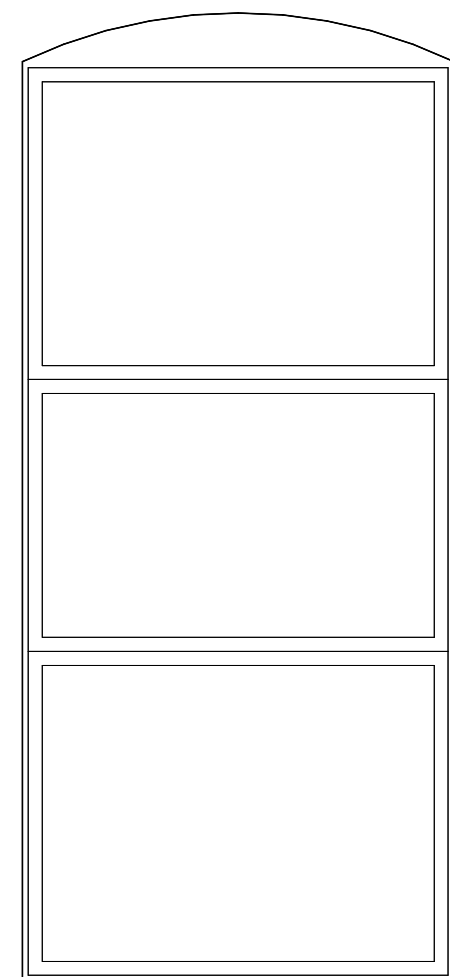
FIXED TRANSOM WITH ARCH TOP OVER CASEMENT PAIR



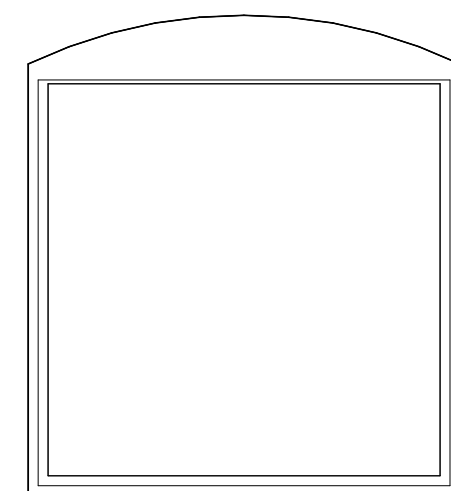FIXED TRANSOM WITH ARCH TOP OVER DOUBLE HUNG



FIXED WITH ARCH TOP

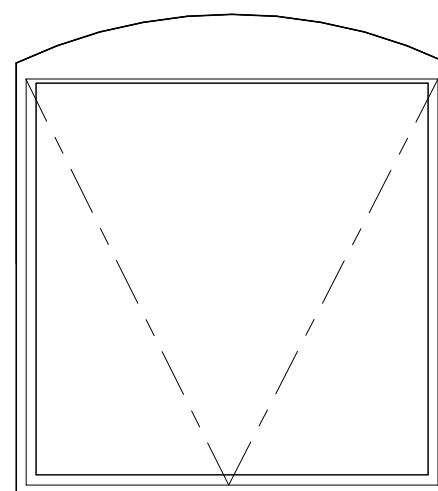

HOPPER WITH ARCH TOP

13 WINDOW TYPE L2
1/2" = 1'-0"

14 WINDOW TYPE M
1/2" = 1'-0"

15 WINDOW TYPE N
1/2" = 1'-0"

16 WINDOW TYPE O
1/2" = 1'-0"

WINDOW SCOPE TREATMENTS

TYPICAL WINDOW SCOPE (ALL TYPES, UNO)

1. REMOVE (E) PERIMETER SEALANT
2. REMOVE (E) WOOD SASH OR DOOR LEAF, HARDWARE, AND WEATHERSTRIPPING U.N.O.
3. RETAIN (E) WOOD FRAME, SILL AND TRIM. INSPECT FOR ROT AND DETERIORATION
4. PATCH (E) FASTENER HOLES, REPAIR ROT AND DAMAGE TO FRAME, SILL AND TRIM WITH APPROVED WOOD RESTORATION MATERIALS
5. PREP AND PAINT FRAME, SILL AND TRIM
6. INSTALL NEW PERIMETER SEALANT
7. INSTALL NEW SASH AND FRAME OR DOOR LEAF AS INDICATED
8. PAINT SASH INTERIOR

WINDOW SCOPE AT JULIET BALCONIES (TYPES F & G)

1. REMOVE (E) PERIMETER SEALANT
2. REMOVE (E) WOOD SASH, HARDWARE, AND WEATHERSTRIPPING U.N.O.
3. REMOVE AND SALVAGE (E) WOOD FRAME, SILL AND TRIM AS REQUIRED TO INSTALL JULIET BALCONY. INSPECT FOR ROT AND DETERIORATION
4. PATCH (E) FASTENER HOLES, REPAIR ROT AND DAMAGE TO FRAME, SILL AND TRIM WITH WOOD RESTORATION MATERIALS. MODIFY FRAME AS REQUIRED TO INSTALL JULIET BALCONY ATTACHMENTS
5. REINSTALL (E) FRAME, SILL AND TRIM
6. PREP AND PAINT FRAME, SILL AND TRIM
7. INSTALL NEW PERIMETER SEALANT
8. INSTALL NEW SASH AND FRAME OR DOOR LEAF AS INDICATED
9. PAINT SASH INTERIOR

LEADED GLASS WOOD WINDOW SCOPE (TYPE E)

1. REMOVE (E) PERIMETER SEALANT
2. RETAIN (E) WOOD SASH. INSPECT FOR LOOSE OR DAMAGED LEAD CAMING AND GLASS, RESTORE AS REQUIRED
3. RETAIN (E) WOOD FRAME AND TRIM. INSPECT (E) WOOD FRAME, SILL, SASH AND TRIM FOR ROT AND DETERIORATION
4. REPAIR ROT AND DAMAGE TO (E) WOOD FRAME, SILL, SASH AND TRIM WITH WOOD RESTORATION MATERIALS
5. PREP AND PAINT (E) WOOD FRAME, SASH, SILL AND TRIM
6. INSTALL NEW PERIMETER SEALANT
7. PAINT SASH INTERIOR
8. INSTALL NEW INTERIOR STORM SASH PANEL

LEGEND
SG SAFETY GLASS

THE COLONIAL GRAND PACIFIC

FACADE REPAIRS

PERMIT SET

1119 1ST AVE, SEATTLE, WA 98101

Drawn by: TD

Checked: MH

Date: 2/16/2021

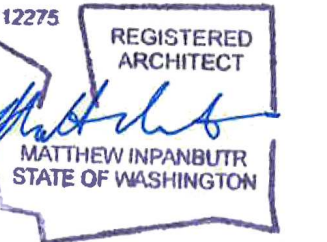
Scale: 1/2" = 1'-0"

Revisions: No. Date Remarks

NOT FOR CONSTRUCTION

DCI APPROVAL STAMPS

WINDOW TYPES
A2.11



- ELEVATION NOTES:**
- PROTECT LANDSCAPING, SIDEWALKS, AND SITE. TYP.
 - PROTECT EXISTING STOREFRONTS, CAST IRON COLUMNS, EXTERIOR LIGHTING FIXTURES, EXTERIOR SIGNAGE, LOUVERS, DOORS, SKYBRIDGE, METAL ROSETTES, CAST IRON SHUTTER BRACKETS, GUTTERS AND OTHER APPURTENANCES NOT SCHEDULED FOR WORK DURING CLEANING AND MASONRY RESTORATION, TYP.
 - PROTECT WINDOW FRAMES, GLAZING AND BALCONIES DURING CLEANING AND MASONRY RESTORATION, TYP.
 - REFER TO SHEETS A2.10 AND A2.11 FOR WINDOW SCHEDULES, TYPES, AND RESTORATION SCOPE OF WORK.
 - REFER TO SHEETS A4.0, A4.1, A4.2 AND A4.3 FOR BALCONY CONDITIONS AND REPAIR TREATMENTS.

KEYNOTE LEGEND

| MARK | KEYNOTE TEXT |
|------|--|
| 2.1 | (E) STOREFRONT: PROTECT, TYP. |
| 2.2 | (E) CAST IRON COLUMN: PROTECT, TYP. |
| 2.3 | (E) ENTRY DOOR: PROTECT, TYP. |
| 4.1A | (E) BRICK MASONRY: CLEAN 100% |
| 4.1B | (E) BRICK MASONRY: REPOINT (SEE KEYNOTE AREA FOR ASSUMED %) |
| 4.1G | (E) BRICK MASONRY: APPLY LEAVE-ON BIOCIDES, TYP. |
| 4.2A | (E) TERRA COTTA: CLEAN 100% |
| 4.2B | (E) TERRA COTTA: REPOINT (SEE KEYNOTE AREA FOR ASSUMED %) |
| 4.2C | (E) TERRA COTTA: CLEAN ORANGE BIOLOGICAL GROWTH |
| 4.2D | (E) TERRA COTTA: REPAIR CRACK WITH REPAIR MATERIALS |
| 4.2H | (E) TERRA COTTA: APPLY LEAVE-ON BIOCIDES, TYP. |
| 4.2I | (E) TERRA COTTA: REPAIR SOFFIT AT DAMAGED AREA PER DETAILS & REMOVE TIMBER SHORING |
| 4.3A | (E) SANDSTONE: CLEAN 100% |
| 4.3B | (E) SANDSTONE: REPOINT (SEE KEYNOTE AREA FOR ASSUMED %) |
| 4.3C | (E) SANDSTONE: REPAIR CRACK WITH REPAIR MATERIALS |
| 4.3D | (E) SANDSTONE: REPAIR / RESTORE ERODED AREA WITH RESTORATION MATERIALS |
| 4.3E | (E) SANDSTONE: INSTALL LEAD TEE WEATHERCAPS AT SKYFACING JOINTS, TYP. |
| 4.3F | (E) SANDSTONE: MODIFY COPING TO PROVIDE POSITIVE DRAINAGE AND PROTECT SKYFACING JOINTS |
| 4.3G | (E) SANDSTONE: APPLY LEAVE-ON BIOCIDES, TYP. |
| 5.1 | (E) JULIET BALCONY: REMOVE, RESTORE, MODIFY PER DETAILS, PREP AND PAINT, AND REINSTALL |
| 7.1 | (E) PERIMETER SEALANT: REMOVE AND REPLACE AT MASONRY OPENING, TYP |
| 7.2 | (E) SHEET METAL CORNICE: SEAL AND REAFFIX OPENED JOINTS; PREP AND PAINT |
| 7.3 | (E) SHEET METAL CORNICE: REMOVE AND REPLACE (E) REGLET SEALANTS, TYP. |
| 8.1 | (E) WOOD WINDOW AND FRAME: SEE SHEETS A2.10 AND A2.11 FOR SCOPE |
| 8.2 | (E) LEADED GLASS WOOD WINDOW: RESTORE PER DETAILS |
| D1 | REMOVE (E) METAL FLASHING |

ELEVATION MATERIAL LEGEND

| | | | |
|--|-------------|--|--------------|
| | SANDSTONE | | CONCRETE |
| | BRICK | | PARGE |
| | TERRA COTTA | | CERAMIC TILE |

BRICK TYPE LEGEND

BT-1 - BRICK TYPE 1: RED COMMON BRICK
 BT-2 - BRICK TYPE 2: RED PRESSED BRICK
 BT-3 - BRICK TYPE 3: TAN PRESSED BRICK

SYMBOL LEGEND

| | | |
|--|-------------|---|
| | WINDOW | SEE WINDOW SCHEDULE ON SHEET A2.10 AND WINDOW TYPES ONSHEET A2.11 |
| | WINDOW MARK | |
| | WINDOW TYPE | |
| | UNIT # | |

THE COLONIAL
GRAND PACIFIC
FACADE
REPAIRS
PERMIT SET

1119 1ST AVE, SEATTLE, WA 98101

Drawn by: TD
 Checked: MH
 Date: 2/16/2021
 Scale: As indicated
 Revisions: No. Date Remarks

1 EAST ELEVATION
1/8" = 1'-0"



DCI APPROVAL STAMPS

NOT FOR CONSTRUCTION

EAST ELEVATION
(FIRST AVENUE)
A3.0



- ELEVATION NOTES:**
1. PROTECT LANDSCAPING, SIDEWALKS, AND SITE, TYP.
 2. PROTECT EXISTING STOREFRONTS, CAST IRON COLUMNS, EXTERIOR LIGHTING FIXTURES, EXTERIOR SIGNAGE, LOUVERS, DOORS, SKYBRIDGE, METAL ROSETTES, CAST IRON SHUTTER BRACKETS, GUTTERS AND OTHER APPURTENANCES NOT SCHEDULED FOR WORK DURING CLEANING AND MASONRY RESTORATION, TYP.
 3. PROTECT WINDOW FRAMES, GLAZING AND BALCONIES DURING CLEANING AND MASONRY RESTORATION, TYP.
 4. REFER TO SHEETS A2.10 AND A2.11 FOR WINDOW SCHEDULES, TYPES, AND RESTORATION SCOPE OF WORK.
 6. REFER TO SHEETS A4.0, A4.1, A4.2 AND A4.3 FOR BALCONY CONDITIONS AND REPAIR TREATMENTS.

KEYNOTE LEGEND

| MARK | KEYNOTE TEXT |
|------|---|
| 2.1 | (E) STOREFRONT: PROTECT, TYP. |
| 2.2 | (E) CAST IRON COLUMN: PROTECT, TYP. |
| 2.4 | (E) CONC STAIR: PROTECT |
| 2.5 | (E) METAL HANDRAIL: PROTECT |
| 4.1A | (E) BRICK MASONRY: CLEAN 100% |
| 4.1B | (E) BRICK MASONRY: REPOINT (SEE KEYNOTE AREA FOR ASSUMED %) |
| 4.1G | (E) BRICK MASONRY: APPLY LEAVE-ON BIOCIDES, TYP. |
| 4.2A | (E) TERRA COTTA: CLEAN 100% |
| 4.2B | (E) TERRA COTTA: REPOINT (SEE KEYNOTE AREA FOR ASSUMED %) |
| 4.2C | (E) TERRA COTTA: CLEAN ORANGE BIOLOGICAL GROWTH |
| 4.2H | (E) TERRA COTTA: APPLY LEAVE-ON BIOCIDES, TYP. |
| 4.2I | (E) TERRA COTTA: REPAIR SOFFIT AT DAMAGED AREA PER DETAILS & REMOVE TIMBER SHORING |
| 5.1 | (E) JULIET BALCONY: REMOVE, RESTORE, MODIFY PER DETAILS, PREP AND PAINT, AND REINSTALL |
| 7.1 | (E) PERIMETER SEALANT: REMOVE AND REPLACE AT MASONRY OPENING, TYP. |
| 7.2 | (E) SHEET METAL CORNICHE: SEAL AND REAFFIX OPENED JOINTS; PREP AND PAINT |
| 8.1 | (E) WOOD WINDOW AND FRAME: SEE SHEETS A2.10 AND A2.11 FOR SCOPE |
| 8.2 | (E) LEADED GLASS WOOD WINDOW: RESTORE PER DETAILS |
| 8.3 | (E) METAL WINDOW GRILLE: REMOVE, SALVAGE AND REINSTALL AFTER WINDOW REPLACEMENT; PREP AND PAINT |
| 9.4 | PREP AND PAINT (E) CONCRETE SHEAR WALL |
| 9.7 | (E) CEMENTITIOUS PARING: REPAIR DELAMINATION / MISSING MATERIAL |
| 9.8 | (E) CERAMIC TILE CLADDING: REPLACE CRACKED TILES IN-KIND |

ELEVATION MATERIAL LEGEND

| | | | |
|--|-------------|--|--------------|
| | SANDSTONE | | CONCRETE |
| | BRICK | | PARGE |
| | TERRA COTTA | | CERAMIC TILE |

BRICK TYPE LEGEND

BT-1 - BRICK TYPE 1: RED COMMON BRICK
 BT-2 - BRICK TYPE 2: RED PRESSED BRICK
 BT-3 - BRICK TYPE 3: TAN PRESSED BRICK

SYMBOL LEGEND

| | | |
|--|-------------|--|
| | WINDOW | SEE WINDOW SCHEDULE ON SHEET A2.10 AND WINDOW TYPES ON SHEET A2.11 |
| | WINDOW MARK | |
| | WINDOW TYPE | |
| | UNIT # | |



1 NORTH ELEVATION
1/8" = 1'-0"

DCI APPROVAL STAMPS


NOT FOR CONSTRUCTION

THE COLONIAL
GRAND PACIFIC
FACADE
REPAIRS
PERMIT SET
1119 1ST AVE, SEATTLE, WA 98101

Drawn by: TD
 Checked: MH
 Date: 2/16/2021
 Scale: As Indicated

| Revisions: | No. | Date | Remarks |
|------------|-----|------|---------|
| | | | |

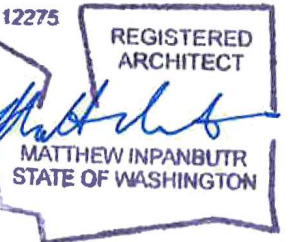NORTH
ELEVATION
(SENECA STREET)
A3.1



ELEVATION NOTES:

- PROTECT LANDSCAPING, SIDEWALKS, AND SITE, TYP.
- PROTECT EXISTING STOREFRONTS, CAST IRON COLUMNS, EXTERIOR LIGHTING FIXTURES, EXTERIOR SIGNAGE, LOUVERS, DOORS, SKYBRIDGE, METAL ROSETTES, CAST IRON SHUTTER BRACKETS, GUTTERS AND OTHER APPURTENANCES NOT SCHEDULED FOR WORK DURING CLEANING AND MASONRY RESTORATION, TYP.
- PROTECT WINDOW FRAMES, GLAZING AND BALCONIES DURING CLEANING AND MASONRY RESTORATION, TYP.
- REFER TO SHEETS A2.10 AND A2.11 FOR WINDOW SCHEDULES, TYPES, AND RESTORATION SCOPE OF WORK.
- REFER TO SHEETS A4.0, A4.1, A4.2 AND A4.3 FOR BALCONY CONDITIONS AND REPAIR TREATMENTS.

KEYNOTE LEGEND

| MARK | KEYNOTE TEXT |
|------|---|
| 2.3 | (E) ENTRY DOOR: PROTECT, TYP. |
| 2.6 | (E) METAL DOWNSPOUT: REMOVE, SALVAGE AND REINSTALL AS REQ'D FOR MASONRY WORK |
| 2.7 | (E) METAL GUTTER: PROTECT |
| 2.9 | (E) GAS LINE: PROTECT |
| 4.1A | (E) BRICK MASONRY: CLEAN 100% |
| 4.1B | (E) BRICK MASONRY: REPOINT (SEE KEYNOTE AREA FOR ASSUMED %) |
| 4.1C | (E) BRICK MASONRY: REMOVE AND REBUILD CORBELLED PARAPET END |
| 4.1D | (E) BRICK MASONRY: REPAIR (E) CRACK BY BRICK REPLACEMENT AND REPOINTING |
| 4.1G | (E) BRICK MASONRY: APPLY LEAVE-ON BIOCIDICIDE, TYP. |
| 5.2 | (E) STEEL BALCONY: REMOVE, RESTORE, MODIFY PER DETAILS, PREP AND PAINT, AND REINSTALL |
| 5.3 | (E) STEEL PLANT BALCONY: REMOVE, RESTORE, PREP AND PAINT, AND REINSTALL |
| 7.1 | (E) PERIMETER SEALANT: REMOVE AND REPLACE AT MASONRY OPENING, TYP |
| 7.2 | (E) SHEET METAL CORNICE: SEAL AND REAFFIX OPENED JOINTS; PREP AND PAINT |
| 8.1 | (E) WOOD WINDOW AND FRAME: SEE SHEETS A2.10 AND A2.11 FOR SCOPE |
| 9.4 | PREP AND PAINT (E) CONCRETE SHEAR WALL |
| 9.5 | PREP AND PAINT (E) METAL PLANT GUARD |
| 9.6 | (E) CEMENTITIOUS PARING: REPAIR CRACK |

ELEVATION MATERIAL LEGEND

| | | | |
|--|-------------|--|--------------|
| | SANDSTONE | | CONCRETE |
| | BRICK | | PARGE |
| | TERRA COTTA | | CERAMIC TILE |

BRICK TYPE LEGEND

- BT-1 - BRICK TYPE 1: RED COMMON BRICK
- BT-2 - BRICK TYPE 2: RED PRESSED BRICK
- BT-3 - BRICK TYPE 3: TAN PRESSED BRICK

SYMBOL LEGEND

| | | |
|--|-------------|---|
| | WINDOW | SEE WINDOW SCHEDULE ON SHEET A2.10 AND WINDOW TYPES ONSHEET A2.11 |
| | WINDOW MARK | |
| | WINDOW TYPE | |
| | UNIT # | |



ELEVATION MATERIAL LEGEND

| | | | |
|--|-------------|--|--------------|
| | SANDSTONE | | CONCRETE |
| | BRICK | | PARGE |
| | TERRA COTTA | | CERAMIC TILE |

BRICK TYPE LEGEND

- BT-1 - BRICK TYPE 1: RED COMMON BRICK
- BT-2 - BRICK TYPE 2: RED PRESSED BRICK
- BT-3 - BRICK TYPE 3: TAN PRESSED BRICK

SYMBOL LEGEND

| | | |
|--|-------------|---|
| | WINDOW | SEE WINDOW SCHEDULE ON SHEET A2.10 AND WINDOW TYPES ONSHEET A2.11 |
| | WINDOW MARK | |
| | WINDOW TYPE | |
| | UNIT # | |

THE COLONIAL
GRAND PACIFIC

FACADE
REPAIRS

PERMIT SET

1119 1ST AVE, SEATTLE, WA 98101

Drawn by: TD
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Date: 2/16/2021
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Revisions:
No. Date Remarks

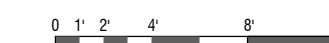
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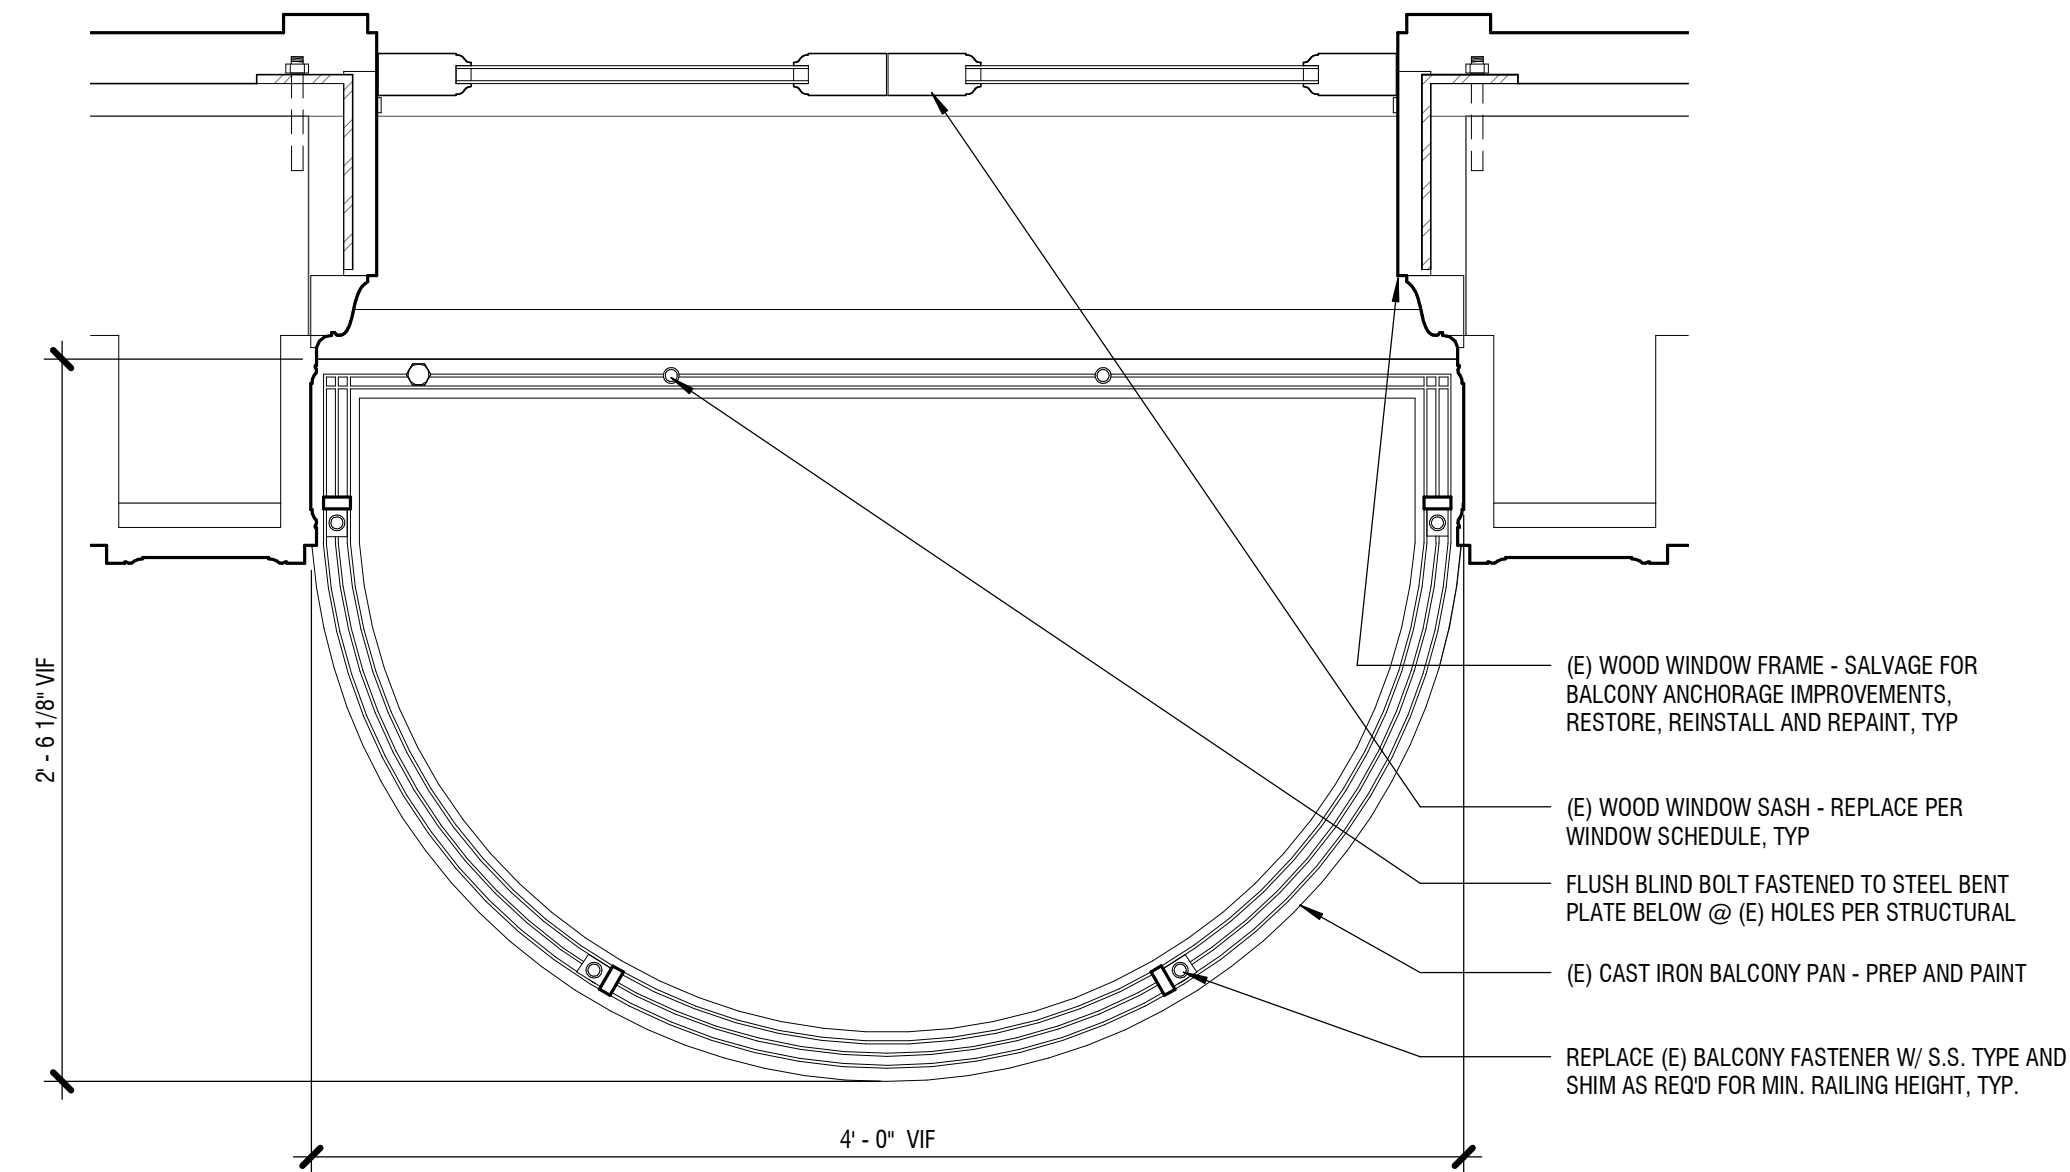
WEST ELEVATION
(POST AVENUE)

A3.2

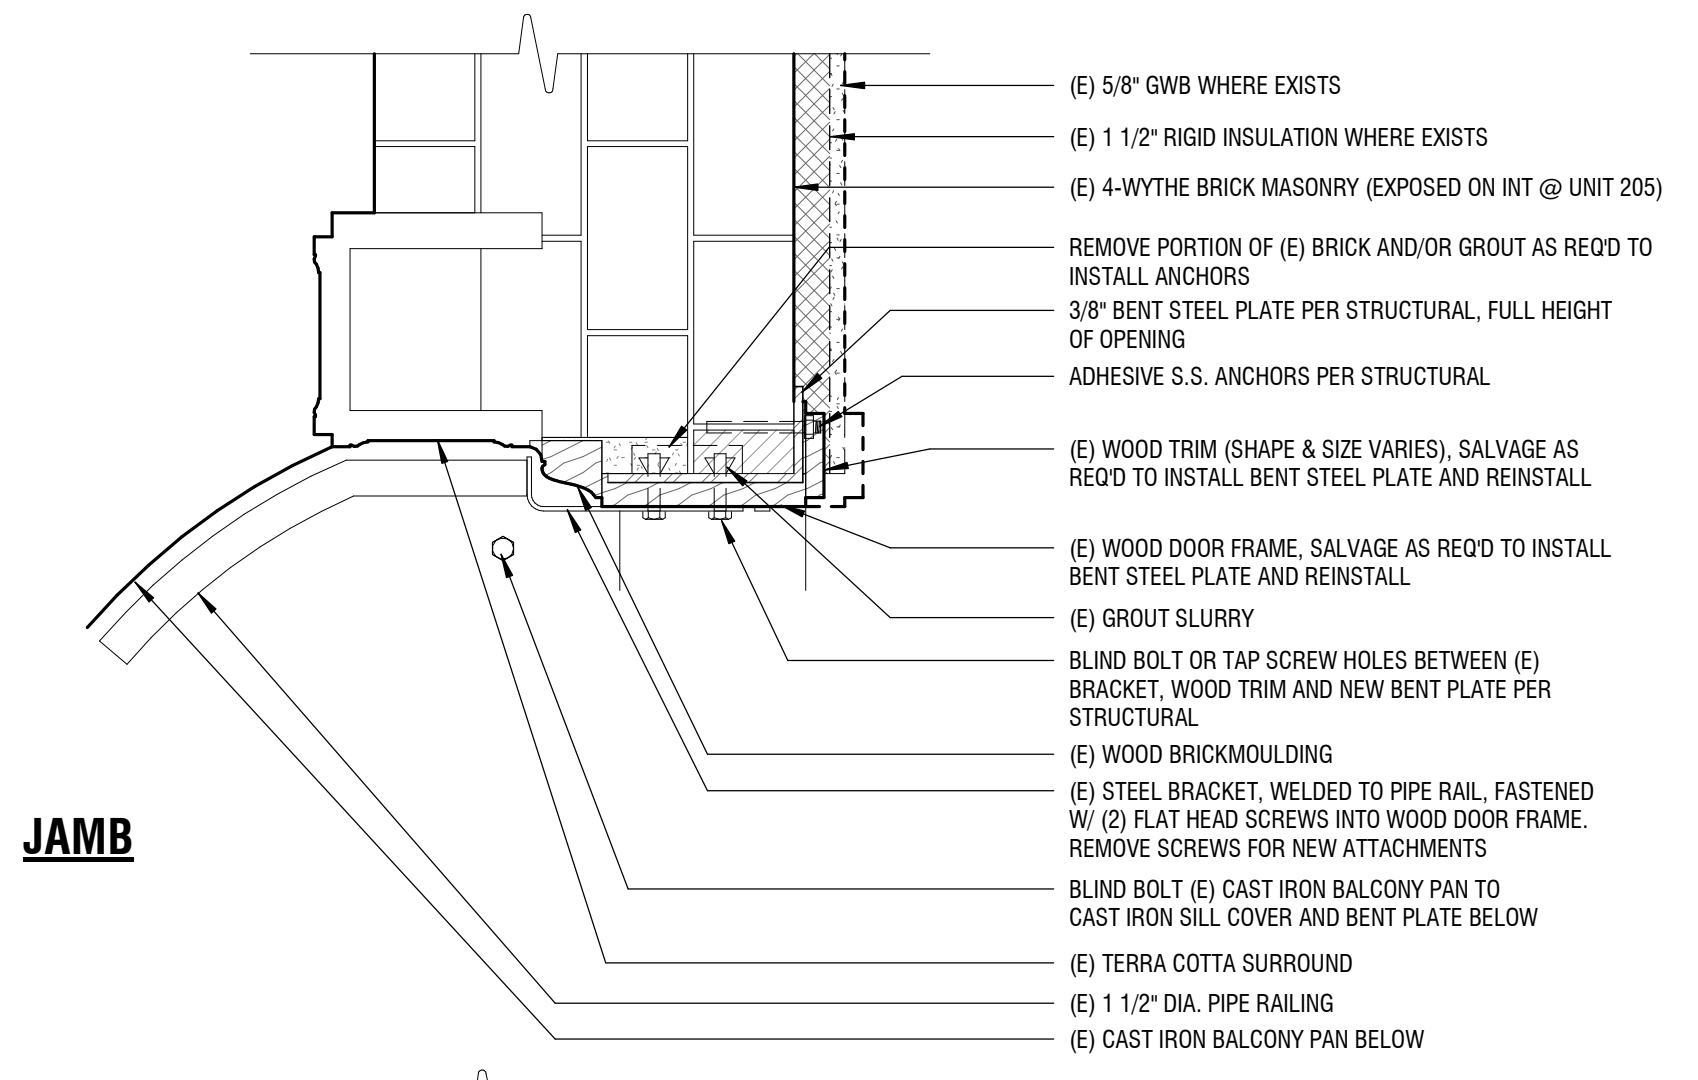
DCI APPROVAL STAMPS

1 WEST ELEVATION
1/8" = 1'-0"






1 TYPE 1A BALCONY PLAN
1 1/2" = 1'-0"



JAMB

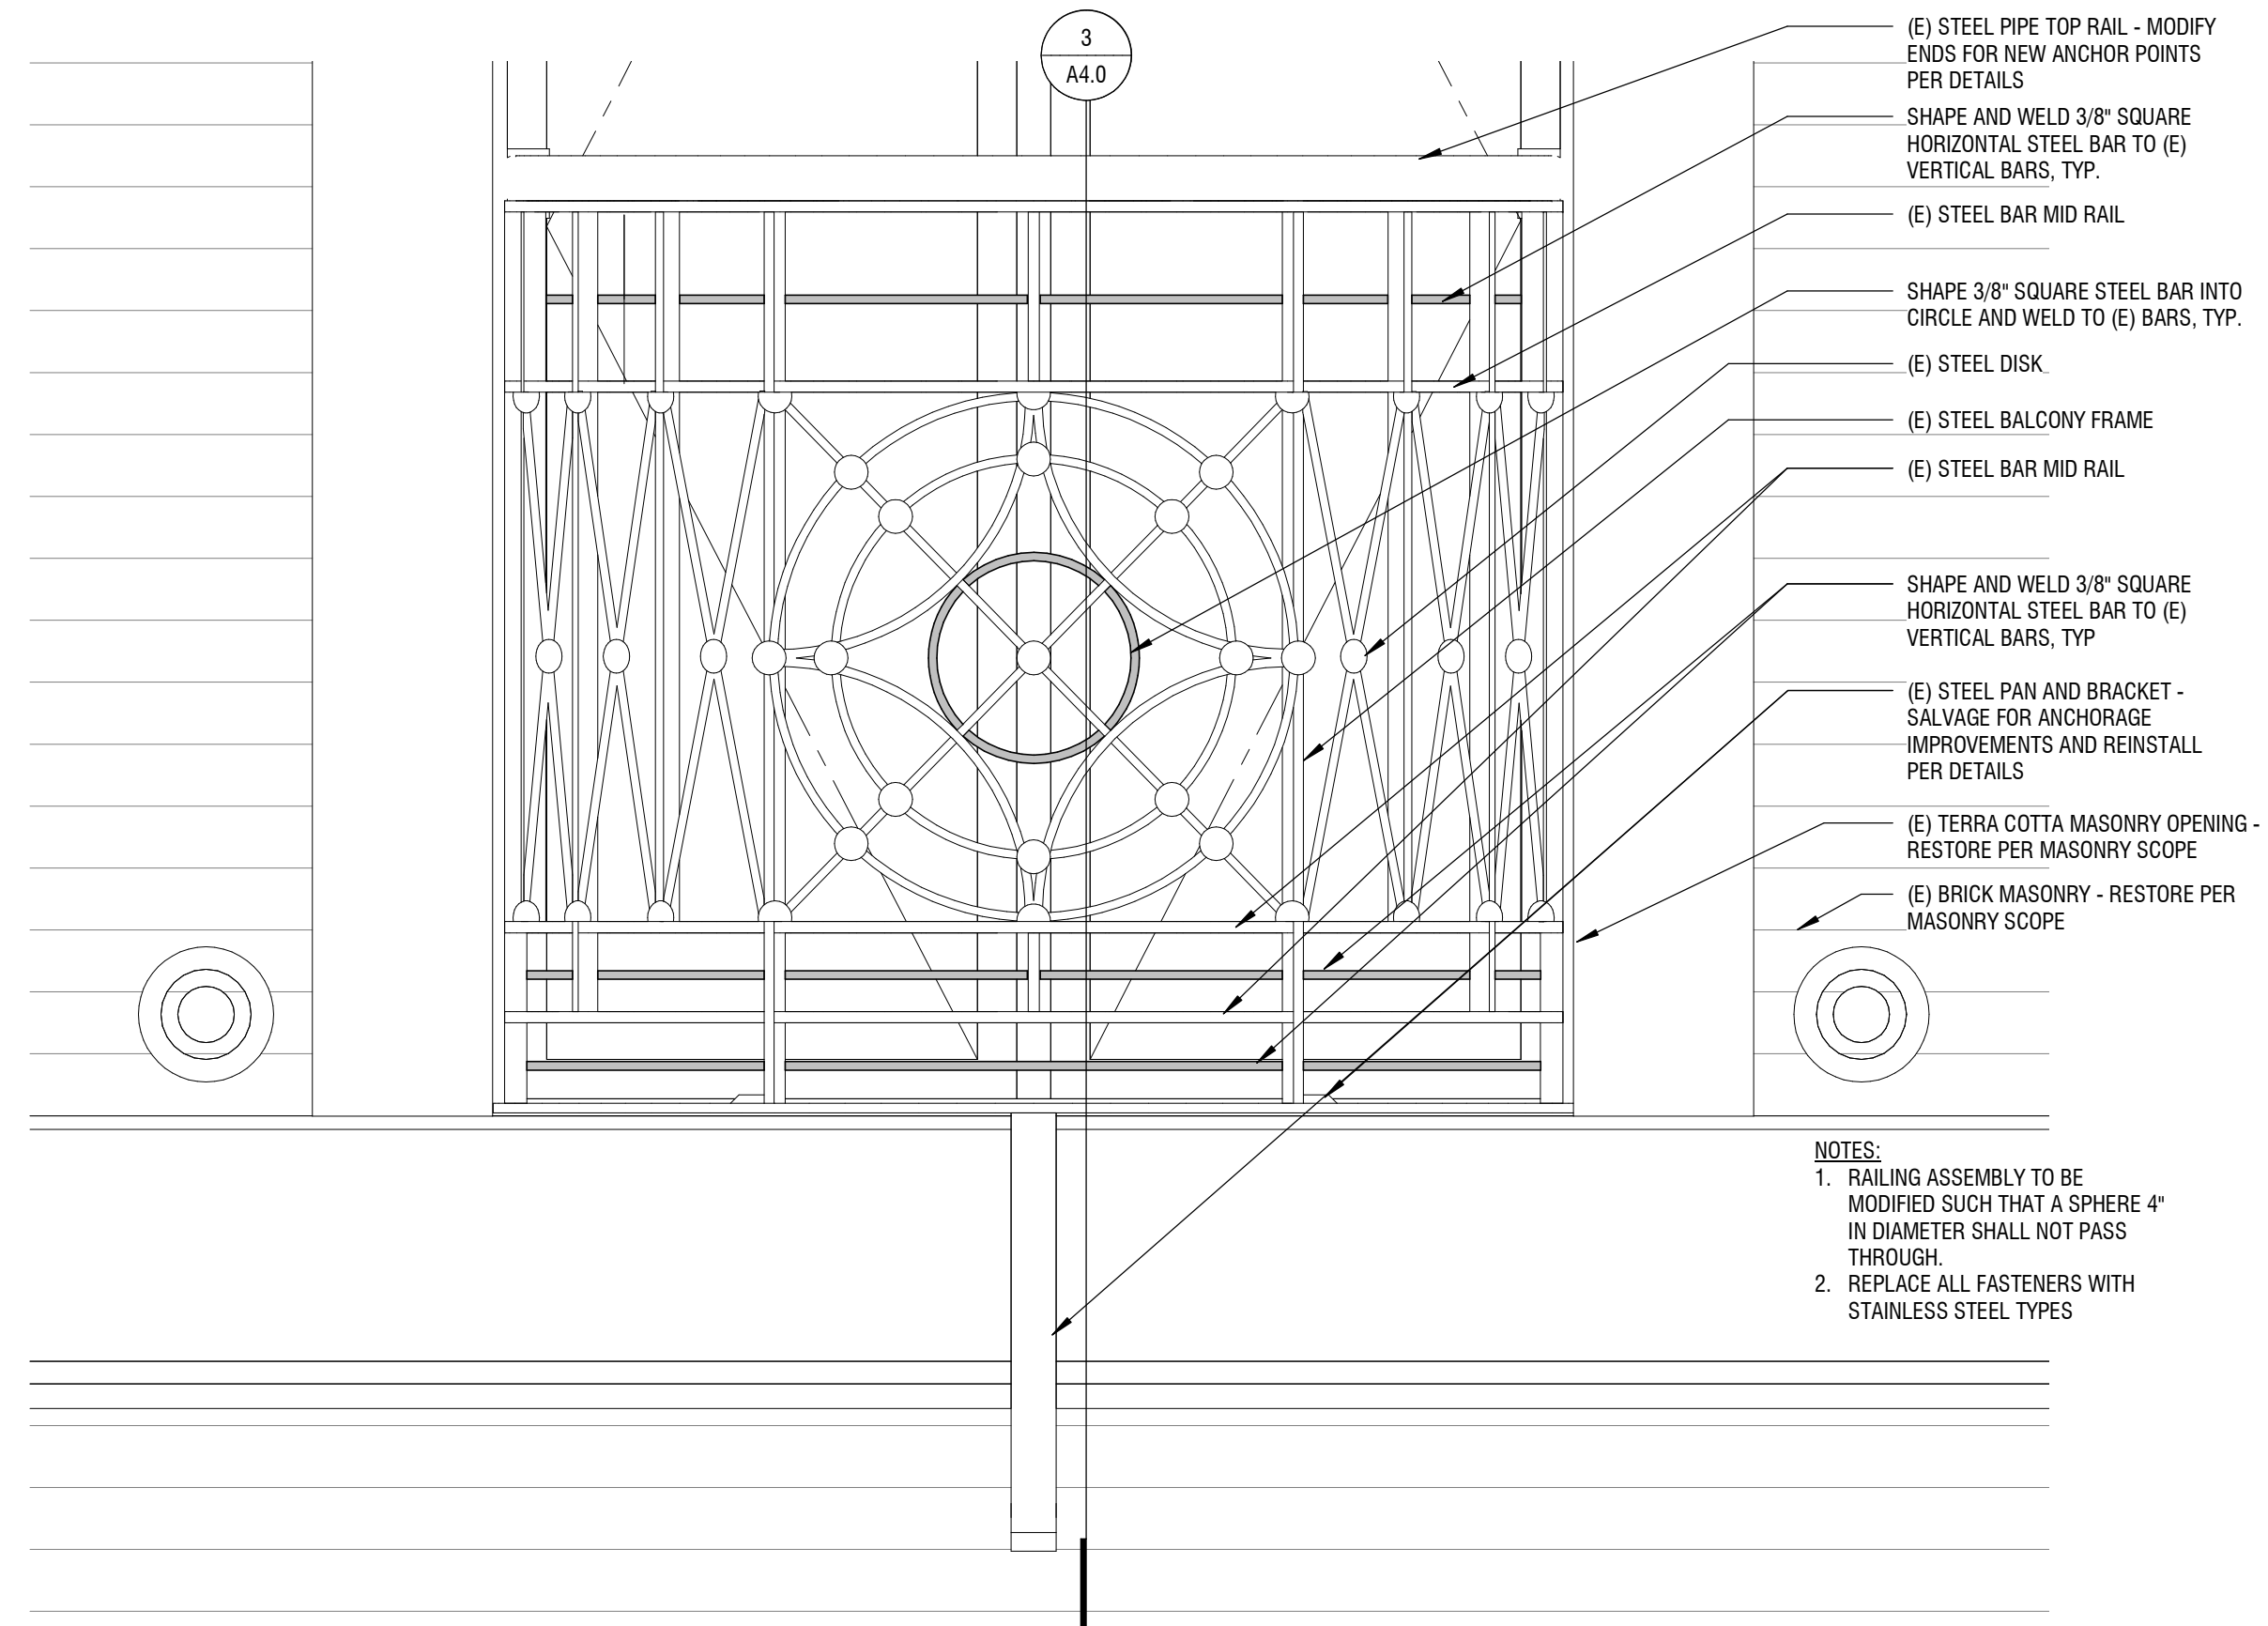

2 JULIET BALCONY TYPE 1A ELEVATION
1 1/2" = 1'-0"

JULIET BALCONY RAILING ASSEMBLY

- (E) STEEL PIPE TOP RAIL - MODIFY ENDS FOR NEW ANCHOR POINTS PER DETAILS
- SHAPE AND WELD 3/8" SQUARE HORIZONTAL STEEL BAR TO (E) VERTICAL BARS, TYP.
- (E) STEEL BAR MID RAIL
- SHAPE 3/8" SQUARE STEEL BAR INTO CIRCLE AND WELD TO (E) BARS, TYP.
- (E) STEEL DISK
- (E) STEEL BALCONY FRAME
- (E) STEEL BAR MID RAIL
- SHAPE AND WELD 3/8" SQUARE HORIZONTAL STEEL BAR TO (E) VERTICAL BARS, TYP.
- (E) STEEL BAR VERTICAL
- SHAPE 3/8" SQUARE STEEL BAR INTO CIRCLE AND WELD TO (E) BARS, TYP.
- (E) STEEL BAR MID RAIL
- SHAPE AND WELD 3/8" SQUARE HORIZONTAL STEEL BAR TO (E) VERTICAL BARS, TYP.
- (E) STEEL PAN AND BRACKET - SALVAGE FOR ANCHORAGE IMPROVEMENTS AND REINSTALL PER DETAILS
- (E) TERRA COTTA MASONRY OPENING - RESTORE PER MASONRY SCOPE
- (E) BRICK MASONRY - RESTORE PER MASONRY SCOPE

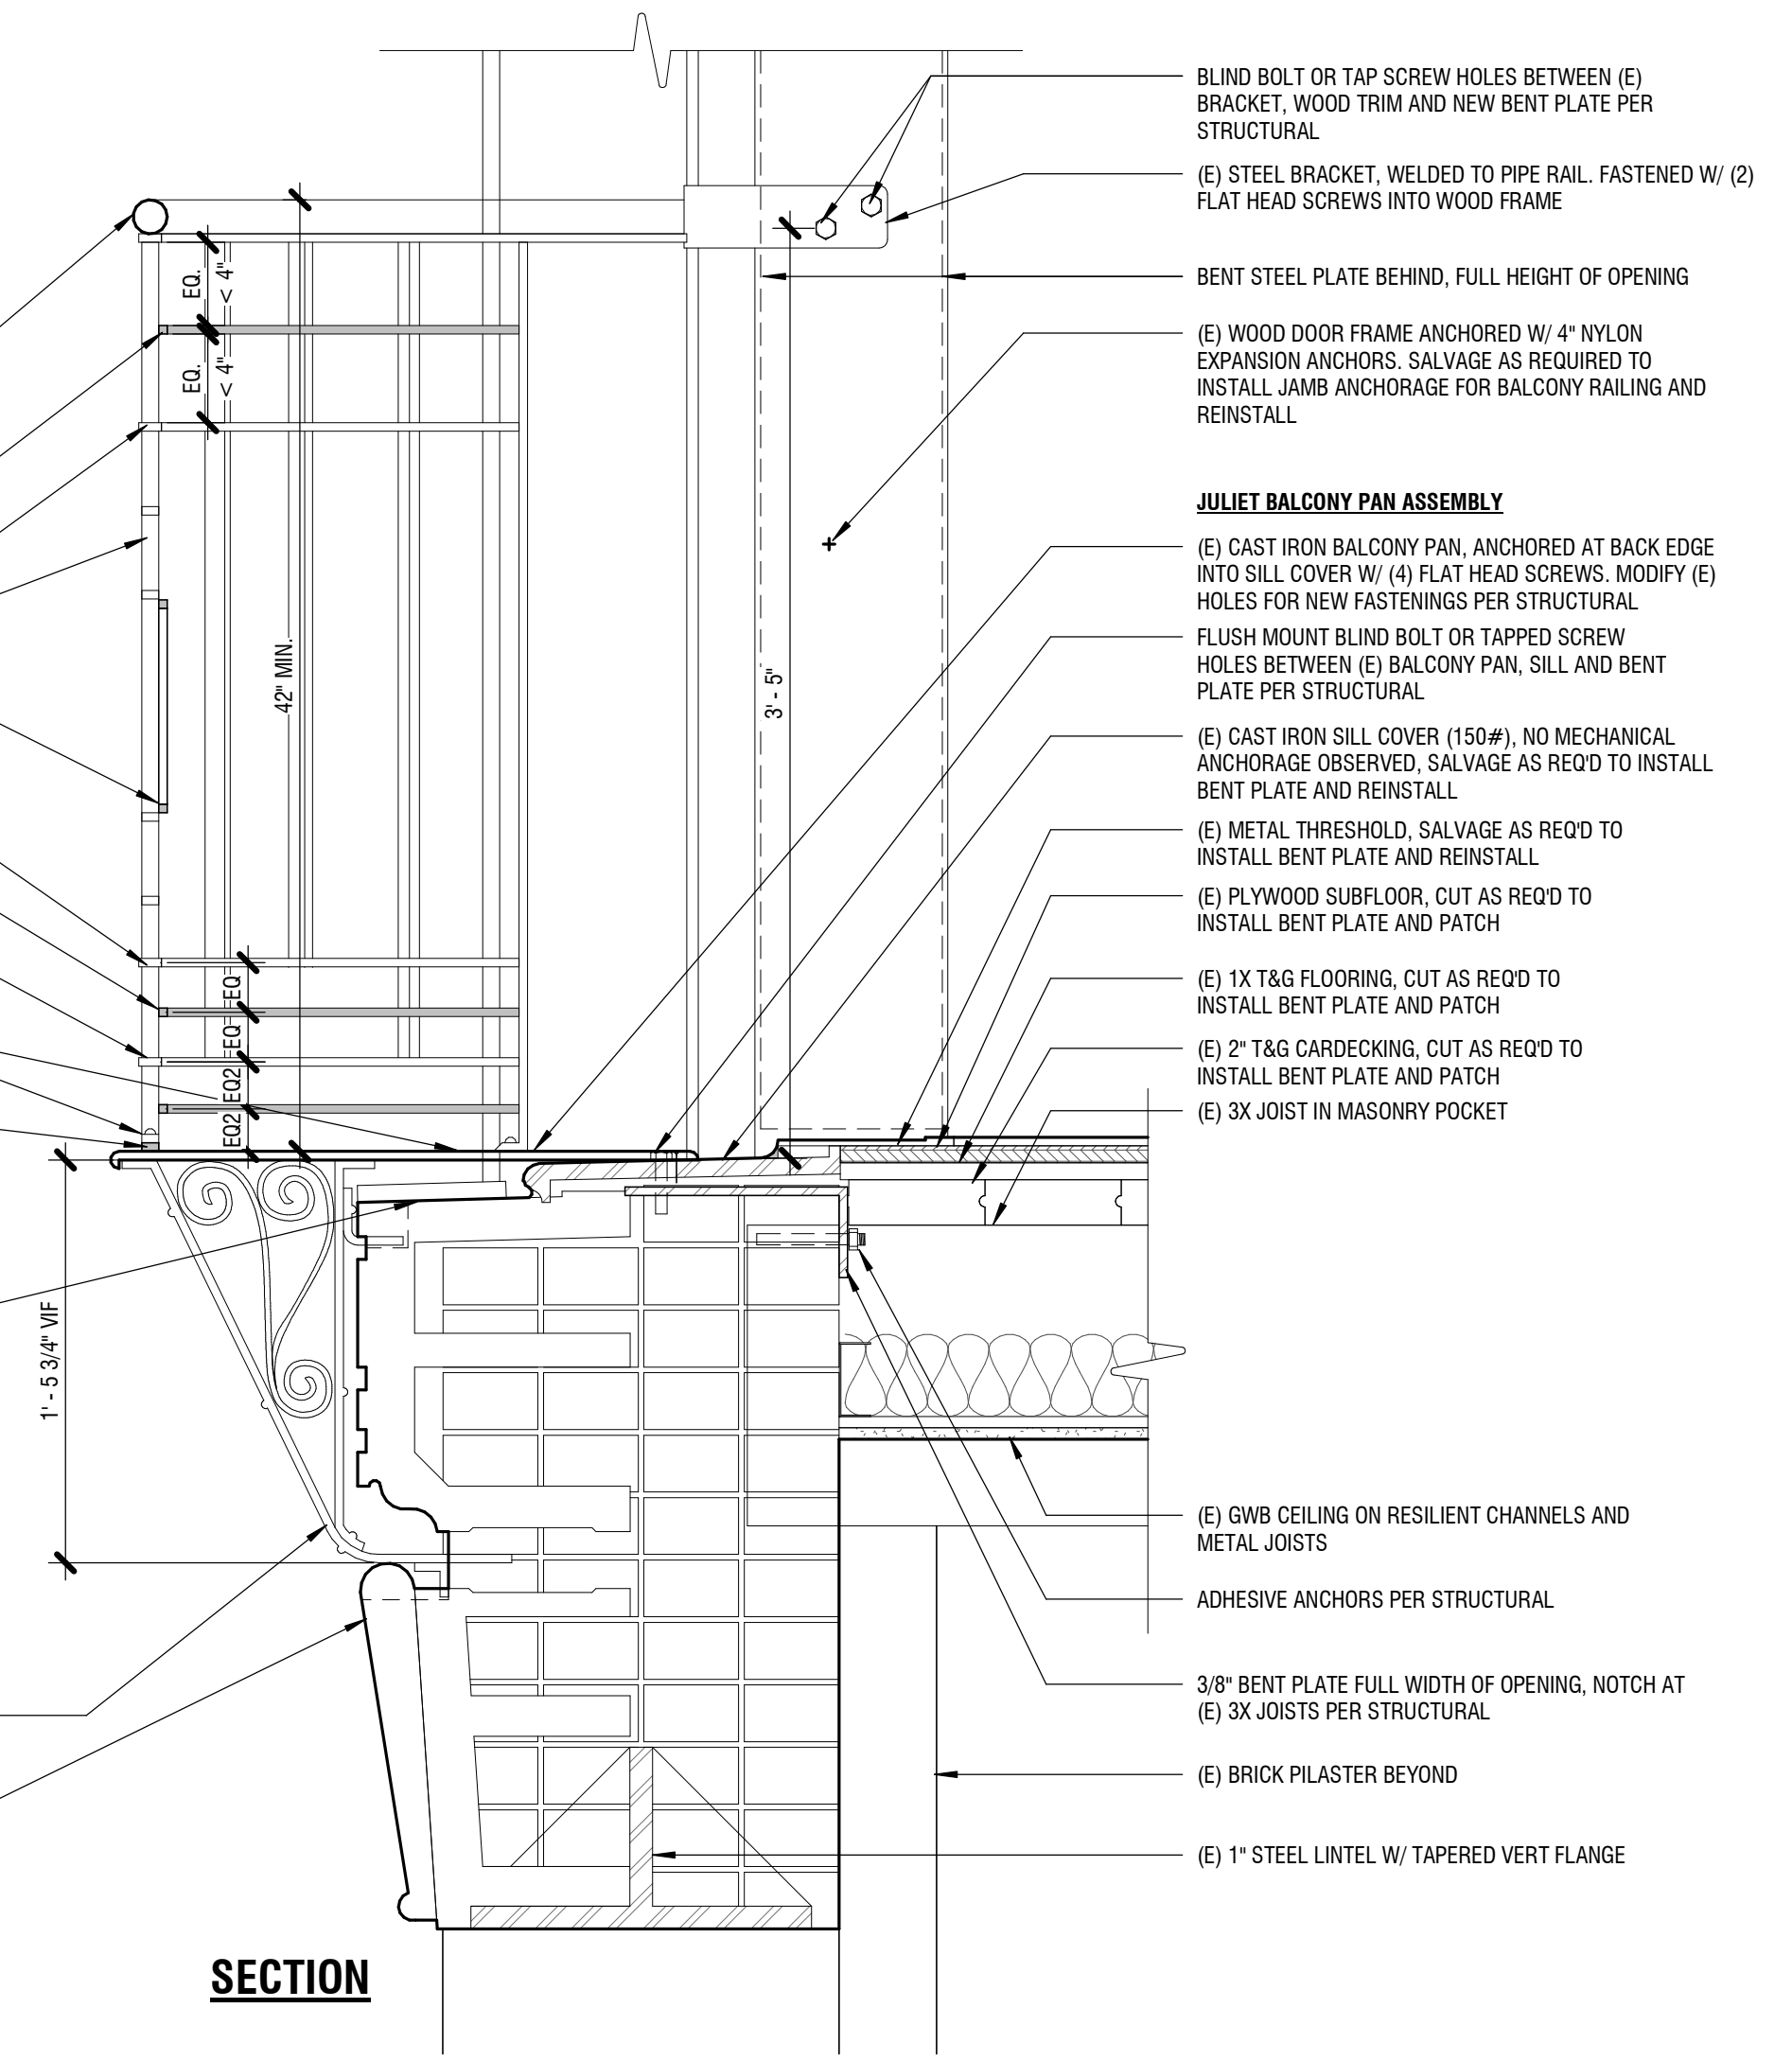
JULIET BALCONY PAN ASSEMBLY

- (E) IRON RAILING, BOLTED TO BALCONY PAN AT 4 LOCATIONS, SALVAGE AS REQD FOR MODIFICATIONS, REPAINT, AND REINSTALL
- PROVIDE STEEL SHIM UNDER RAILING FEET AS REQD TO ENSURE 42" MIN RAILING HEIGHT, THROUGH BOLTED TO BALCONY PAN

- (E) TERRA COTTA GREEK KEY BAND, CUT IN TO RECEIVE BRACKET BEARING PLATE. NOTE: TERRA COTTA UNITS ARE SLUGGED FULL W/ BRICK AND MORTAR

- (E) WROUGHT IRON BRACKET W/ RIVET CONNECTIONS. SALVAGE AS REQD TO INSTALL SILL PAN BENT PLATE AND REINSTALL. SET UPPER AND LOWER BRACKET IN GROUT PER STRUCTURAL

- (E) TERRA COTTA KEYSTONE (WHERE EXISTS), CUT IN TO RECEIVE BRACKET BEARING PLATES. (E) BRICK IS MODIFIED / PATCHED TO RECEIVE BRACKET TAIL



SECTION

3 JULIET BALCONY TYPE 1A / WINDOW TYPE F DETAILS
1 1/2" = 1'-0"


DCI APPROVAL STAMPS

THE COLONIAL GRAND PACIFIC
FACADE REPAIRS
PERMIT SET
1119 1ST AVE, SEATTLE, WA 98101


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| Drawn by: | MH | |
| Checked: | MH | |
| Date: | 2/16/2021 | |
| Scale: | 1 1/2" = 1'-0" | |
| Revisions: | | |
| No. | Date | Remarks |

NOT FOR CONSTRUCTION


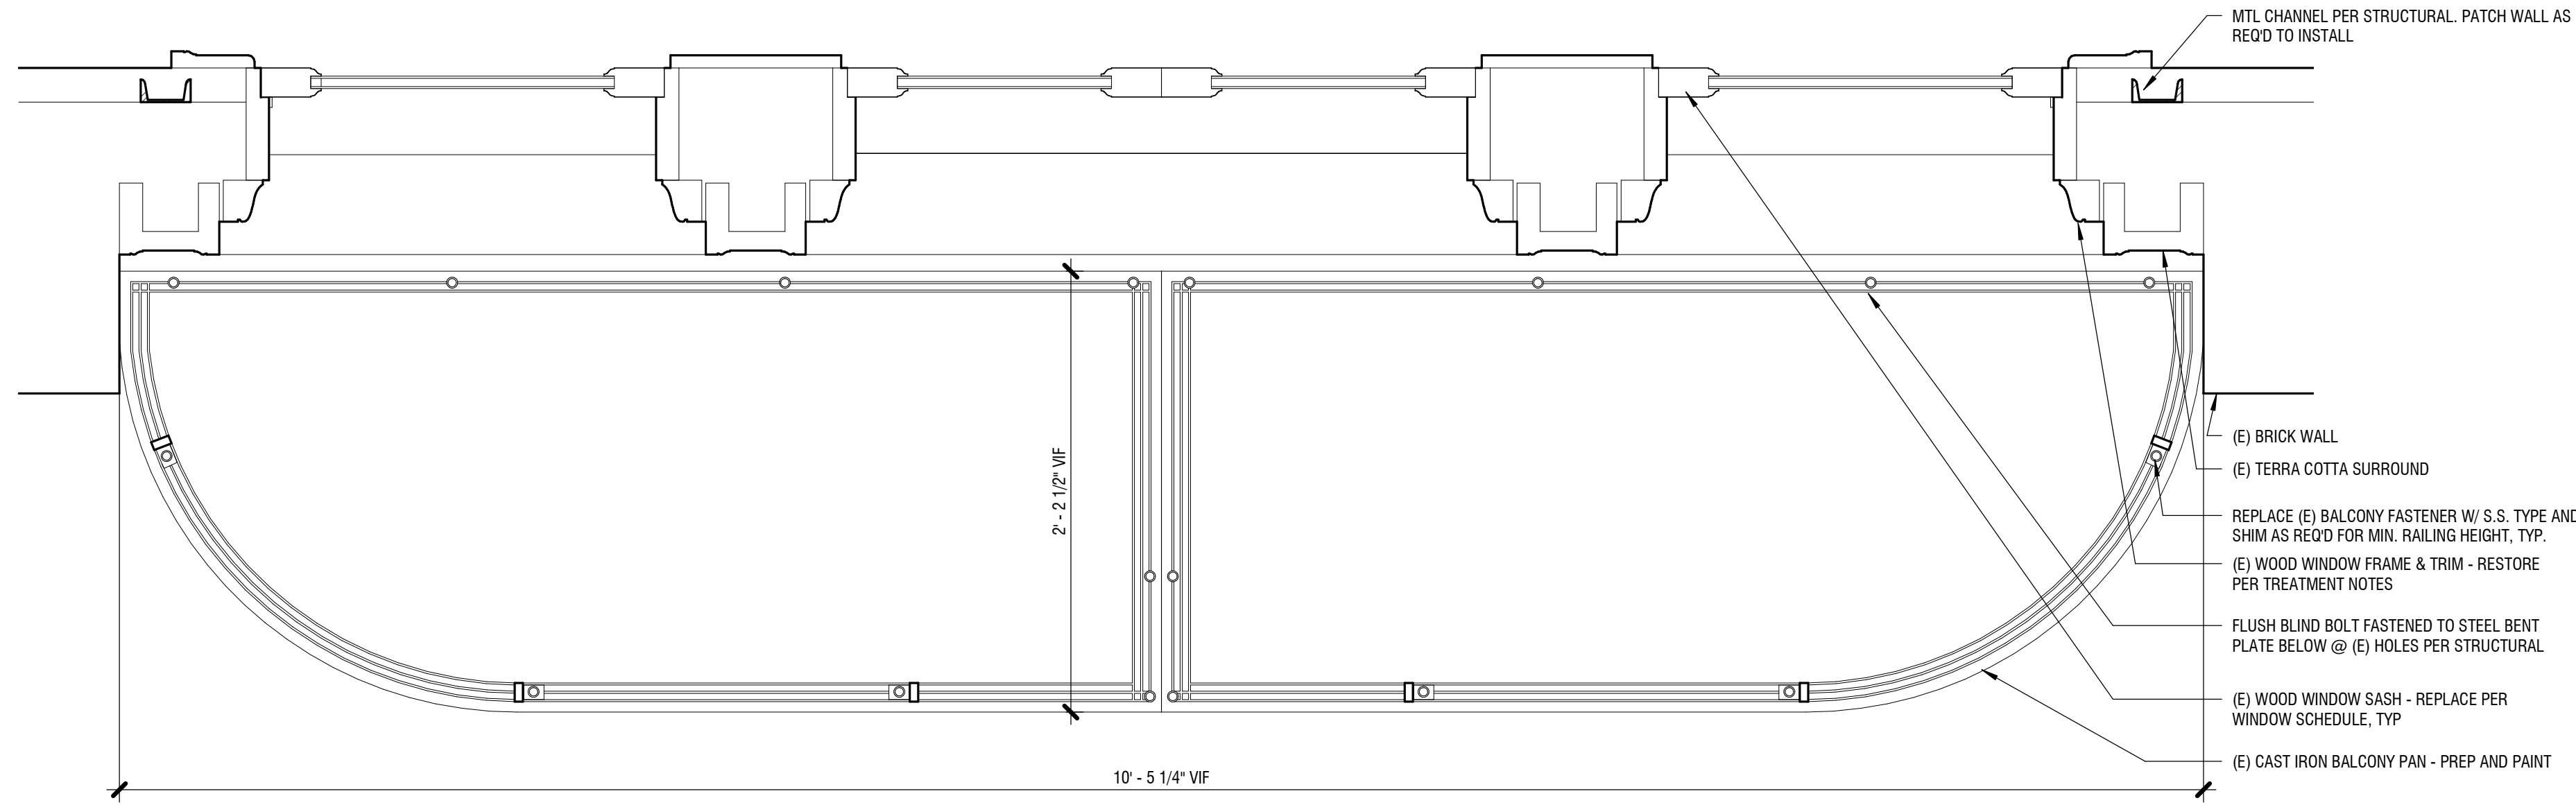
BALCONY TYPE 1A DETAILS
A4.0



1 TYPE 2A BALCONY PLAN
1 1/2" = 1'-0"

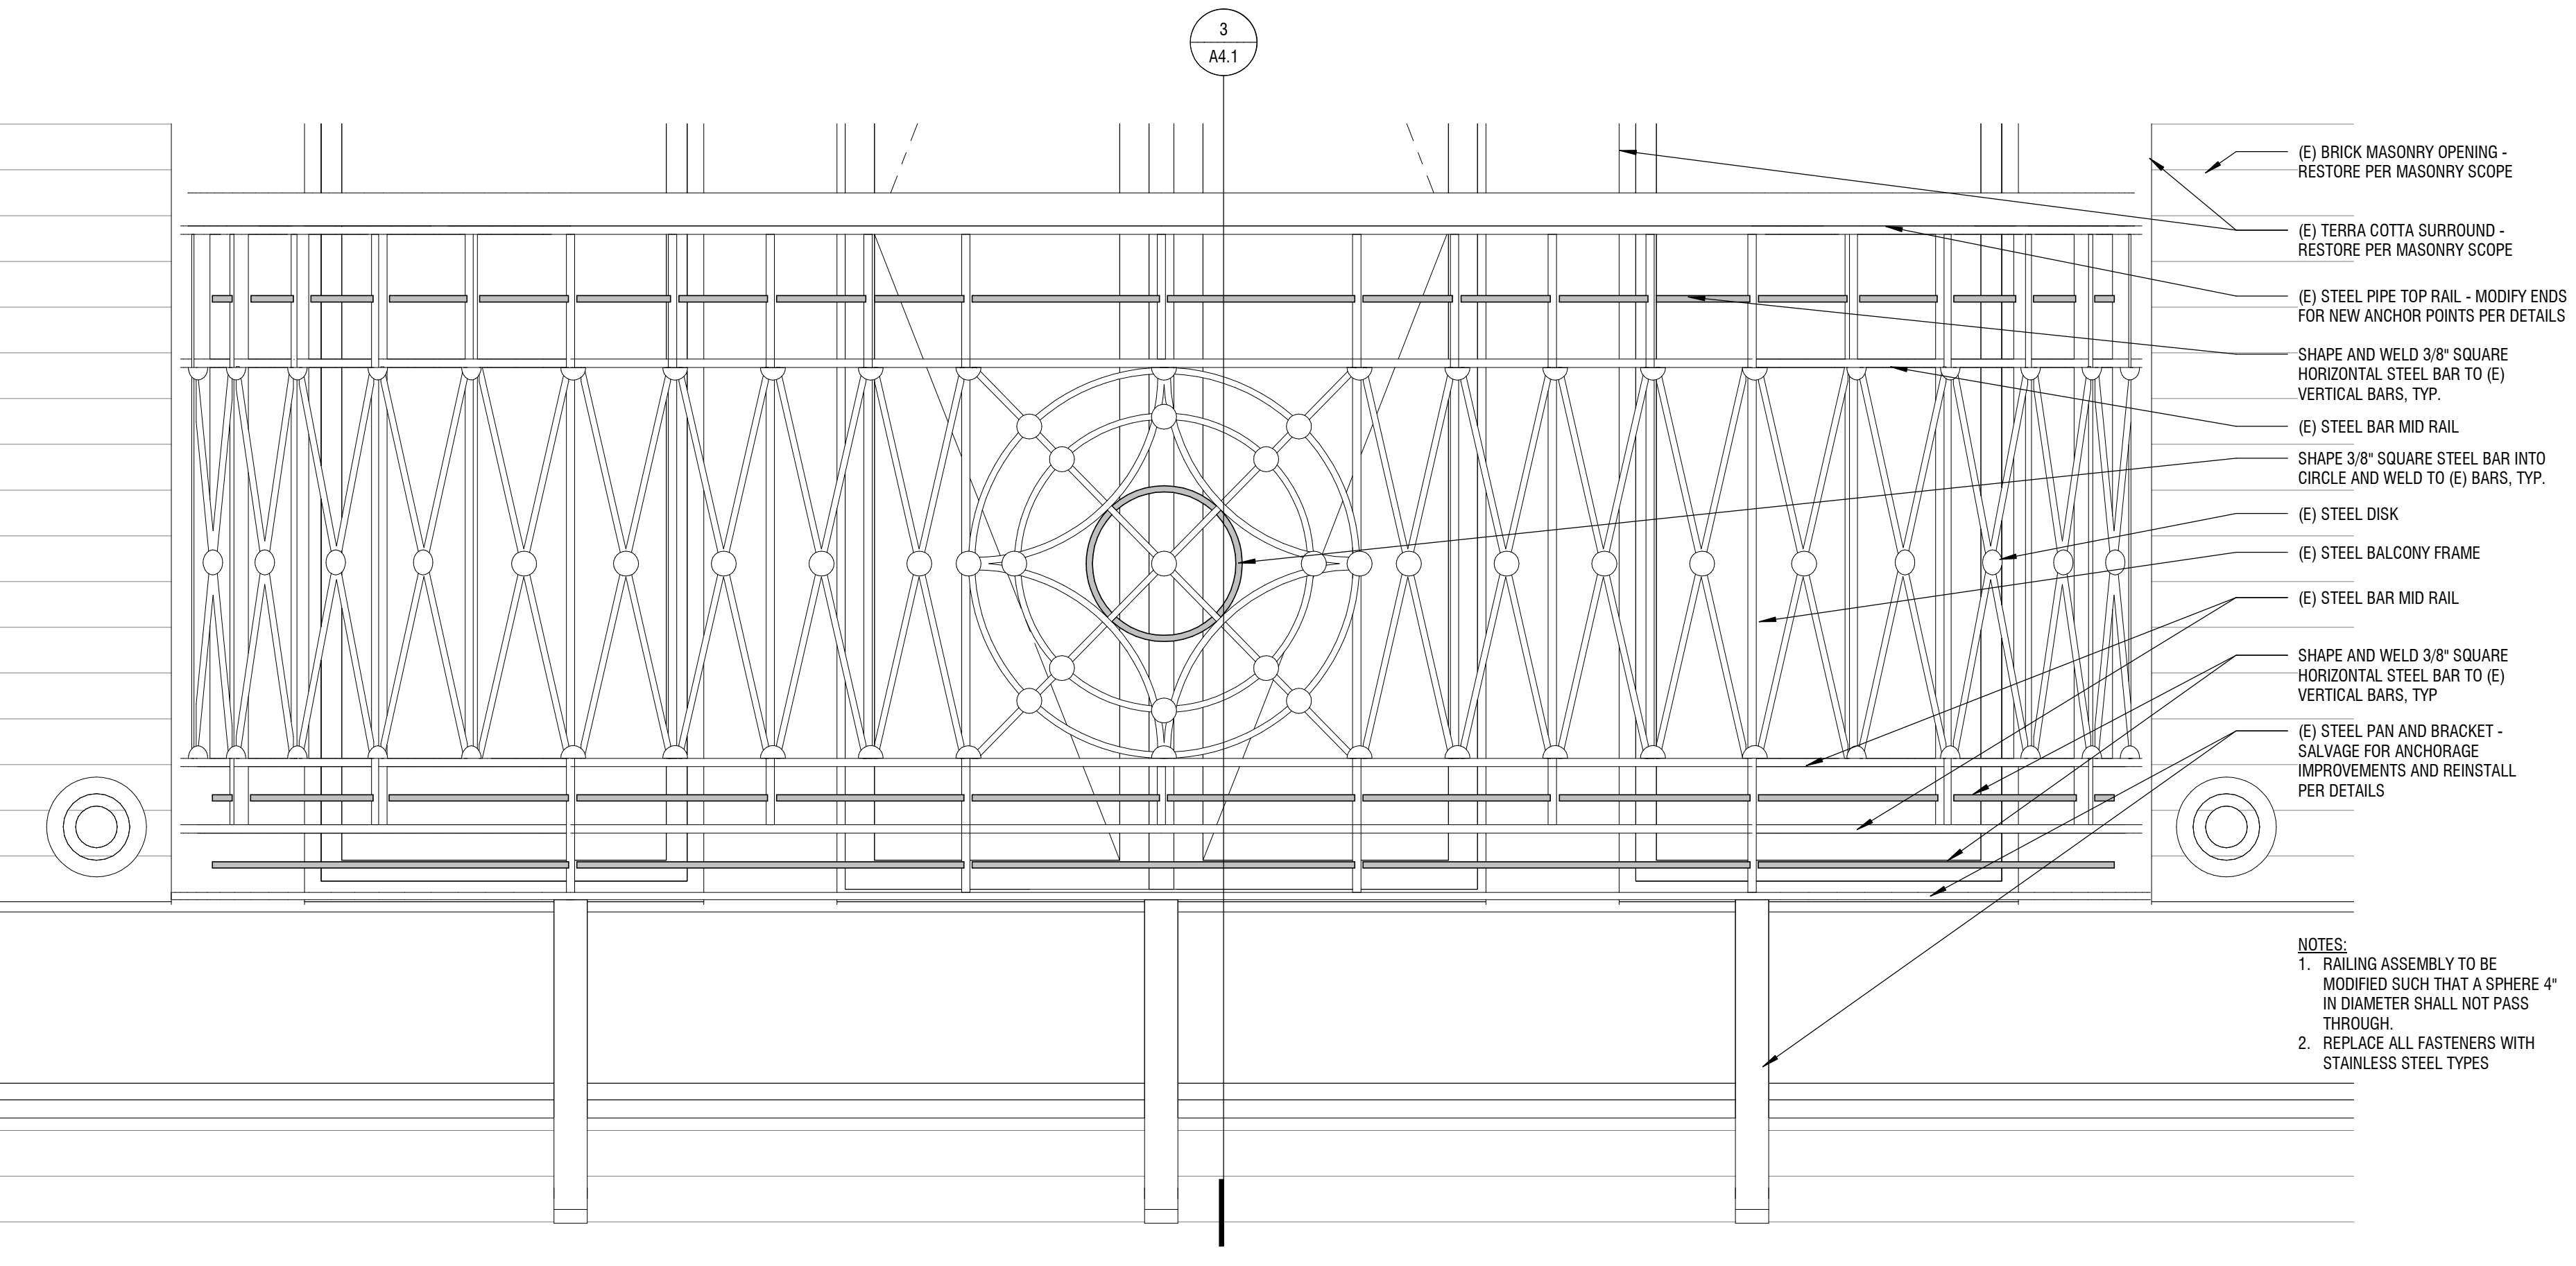

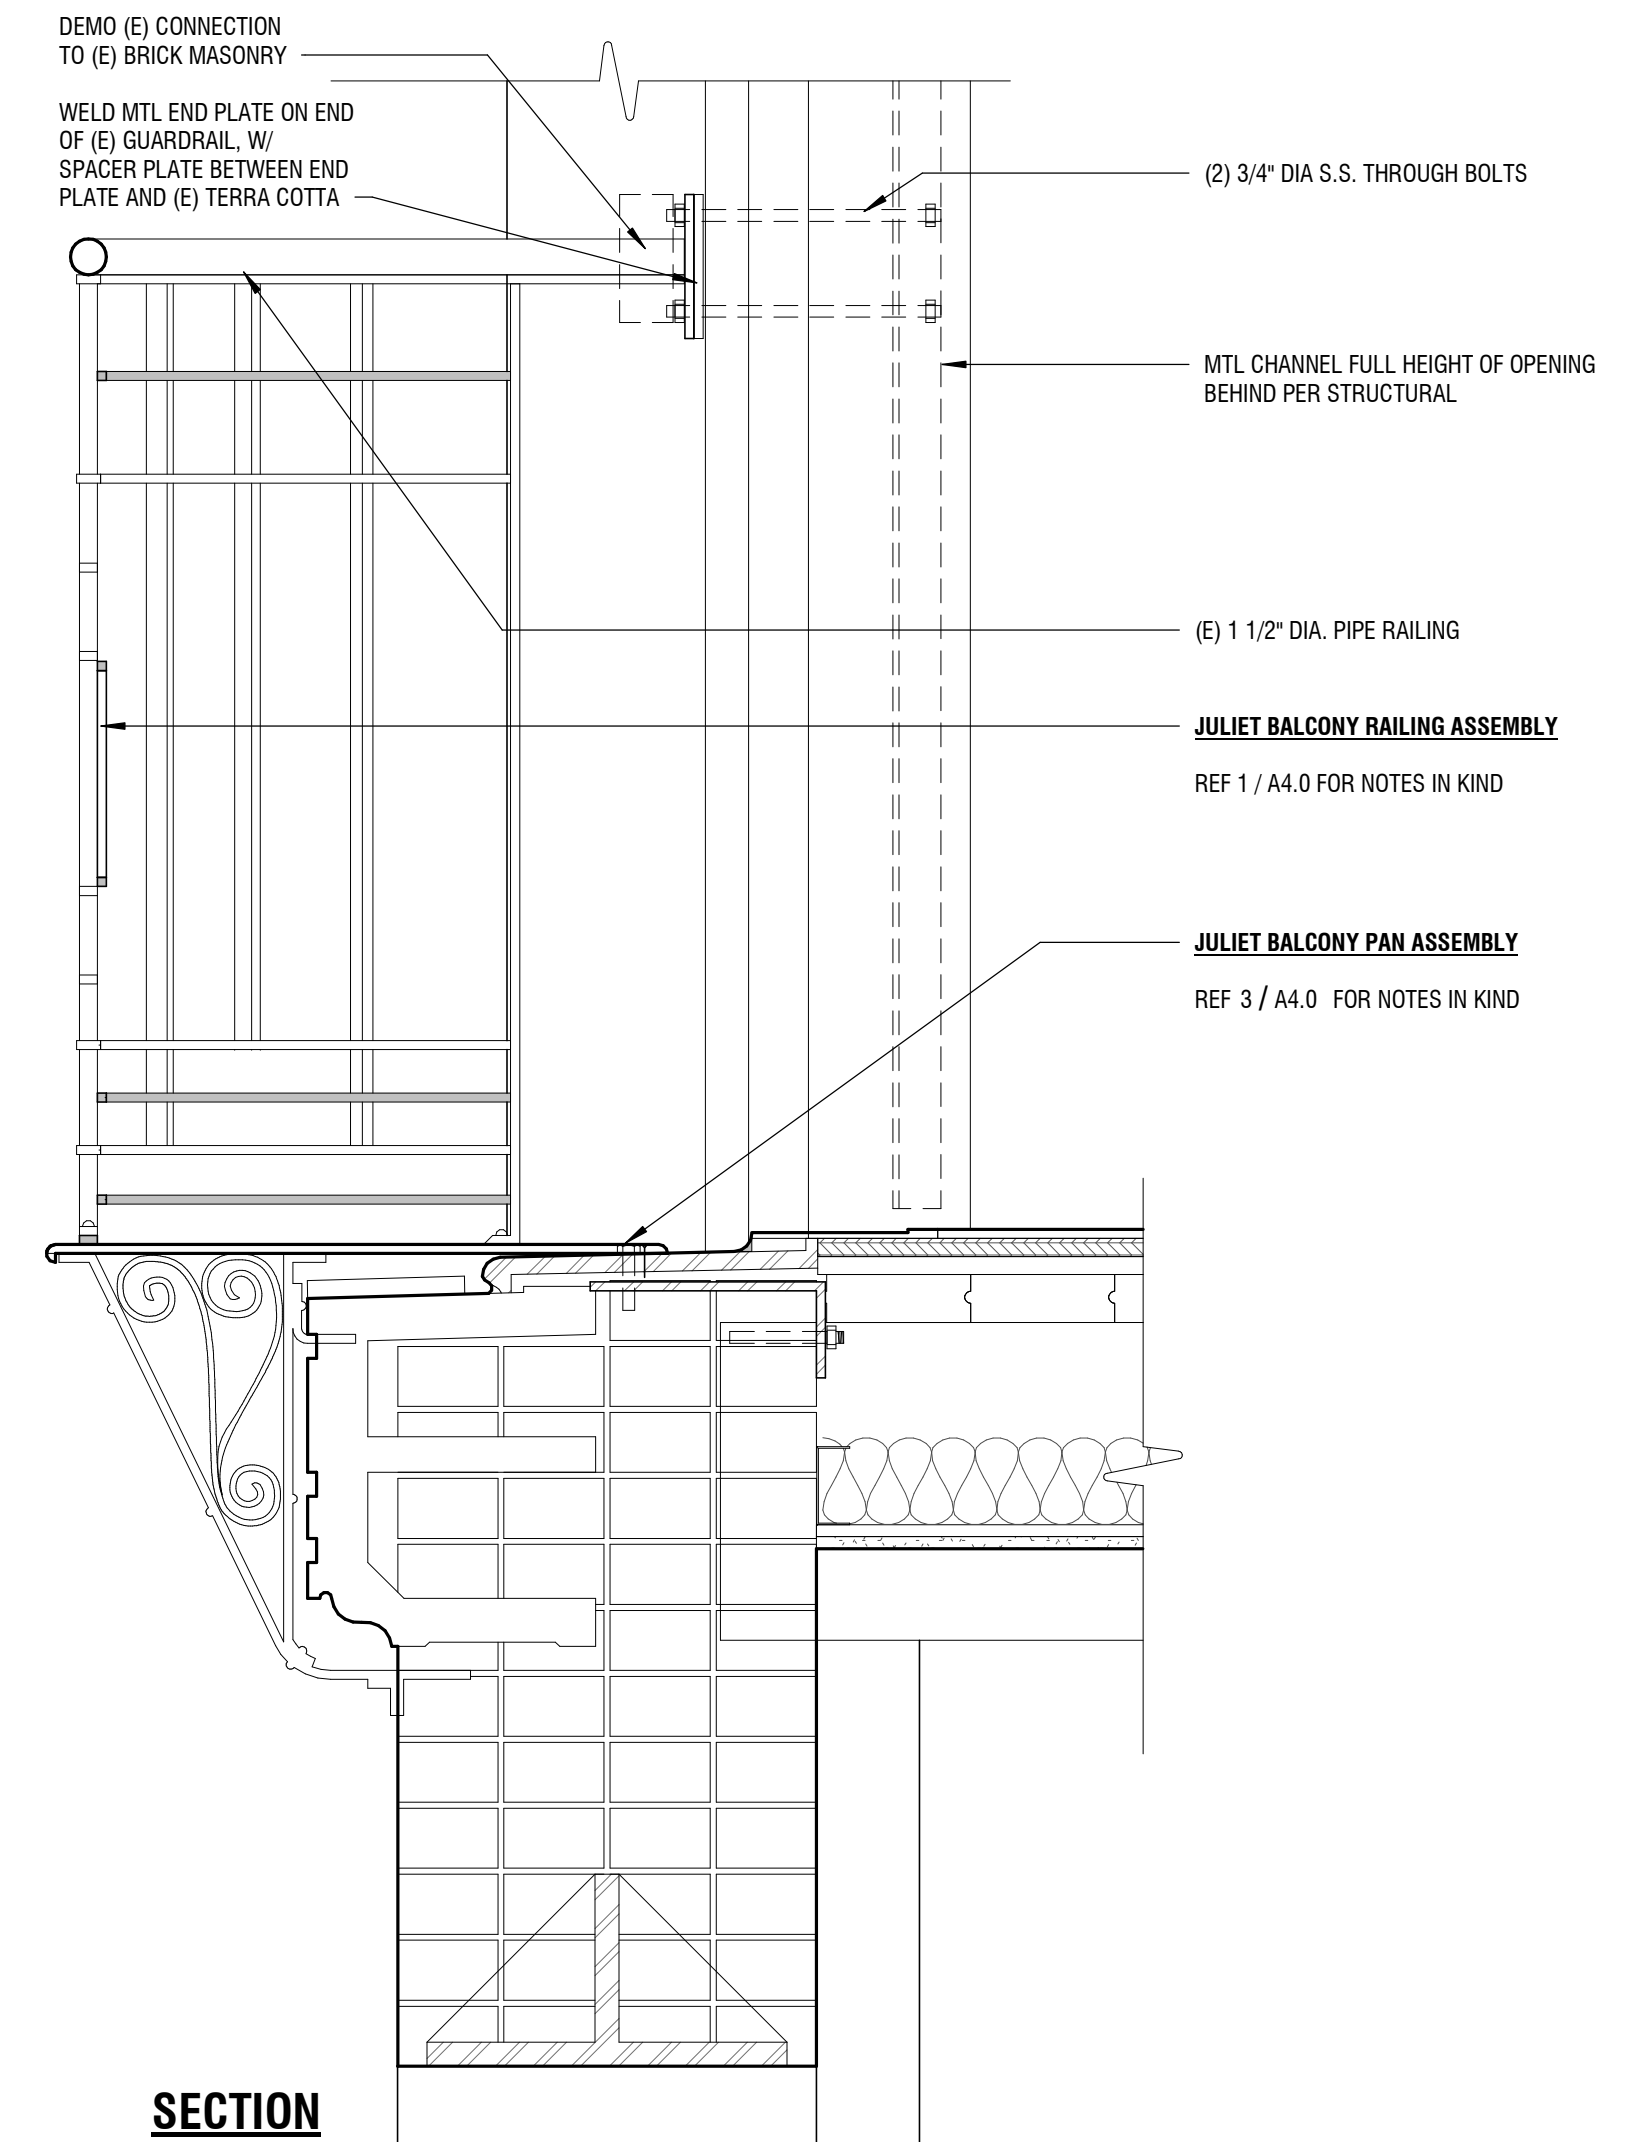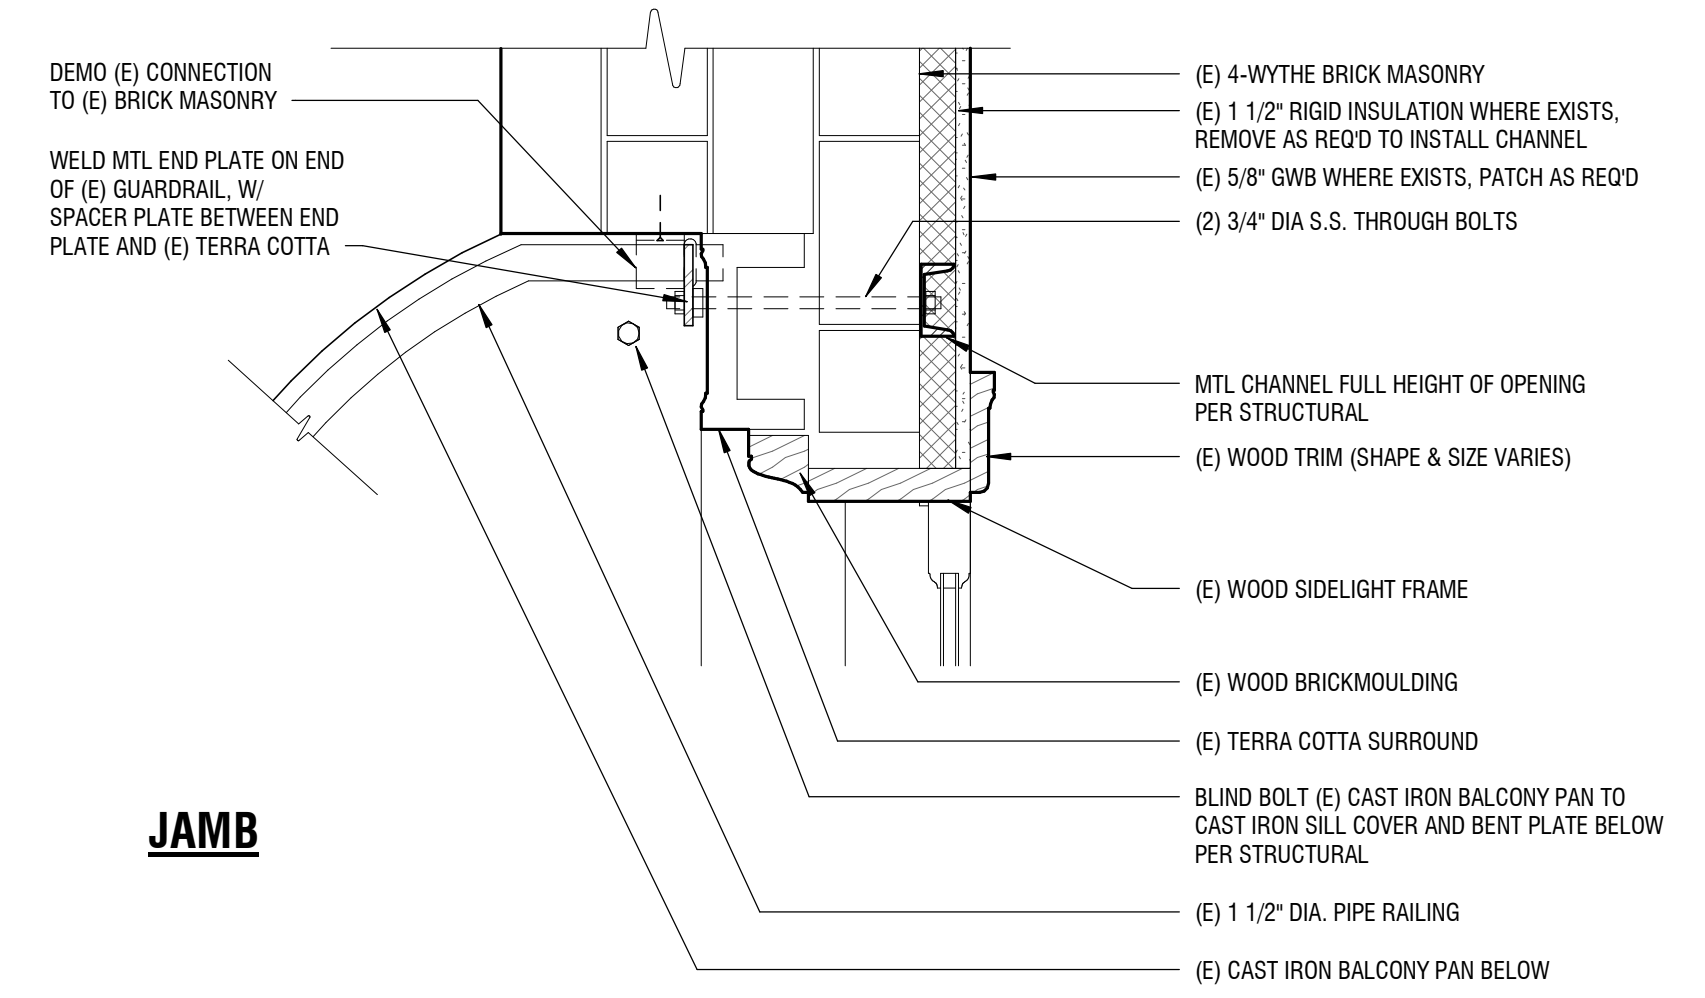2 JULIET BALCONY TYPE 2A ELEVATION
1 1/2" = 1'-0"



3 JULIET BALCONY TYPE 2A / WINDOW TYPE G DETAILS
1 1/2" = 1'-0"

THE COLONIAL GRAND PACIFIC

FACADE REPAIRS

PERMIT SET

1119 1ST AVE, SEATTLE, WA 98101

Drawn by: MH
Checked: MH
Date: 2/16/2021
Scale: 1 1/2" = 1'-0"

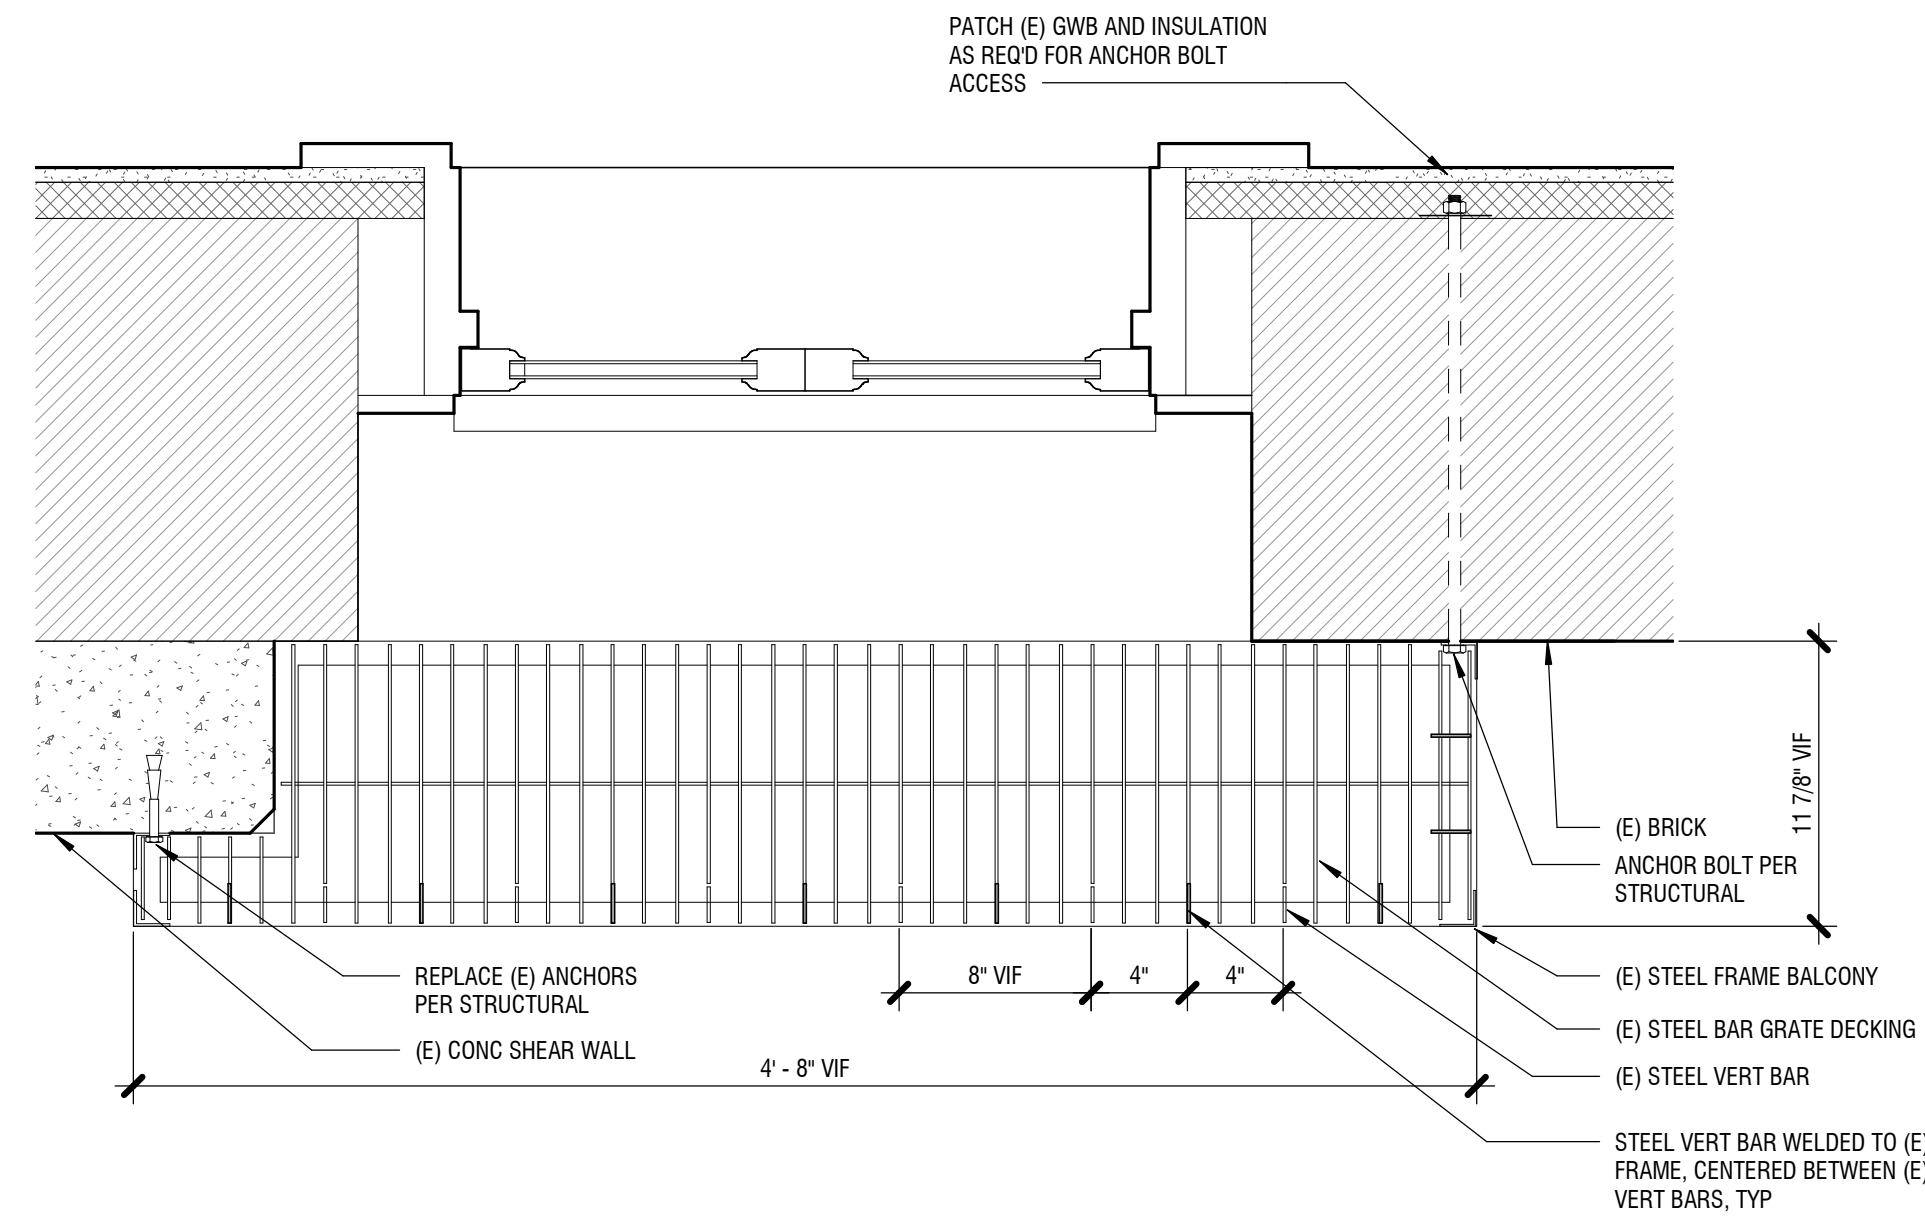
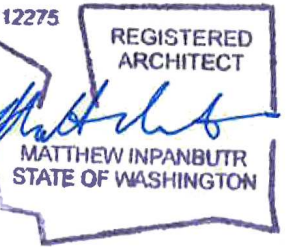
Revisions:
No. Date Remarks

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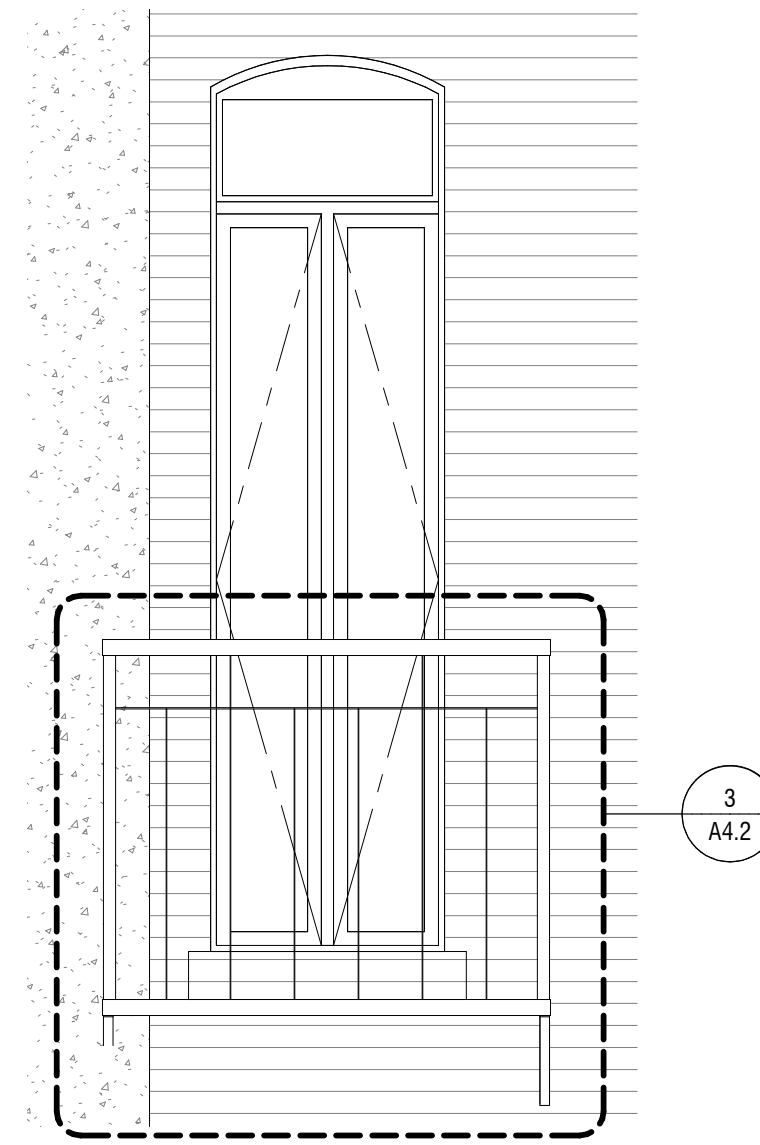
BALCONY TYPE 2A DETAILS

A4.1

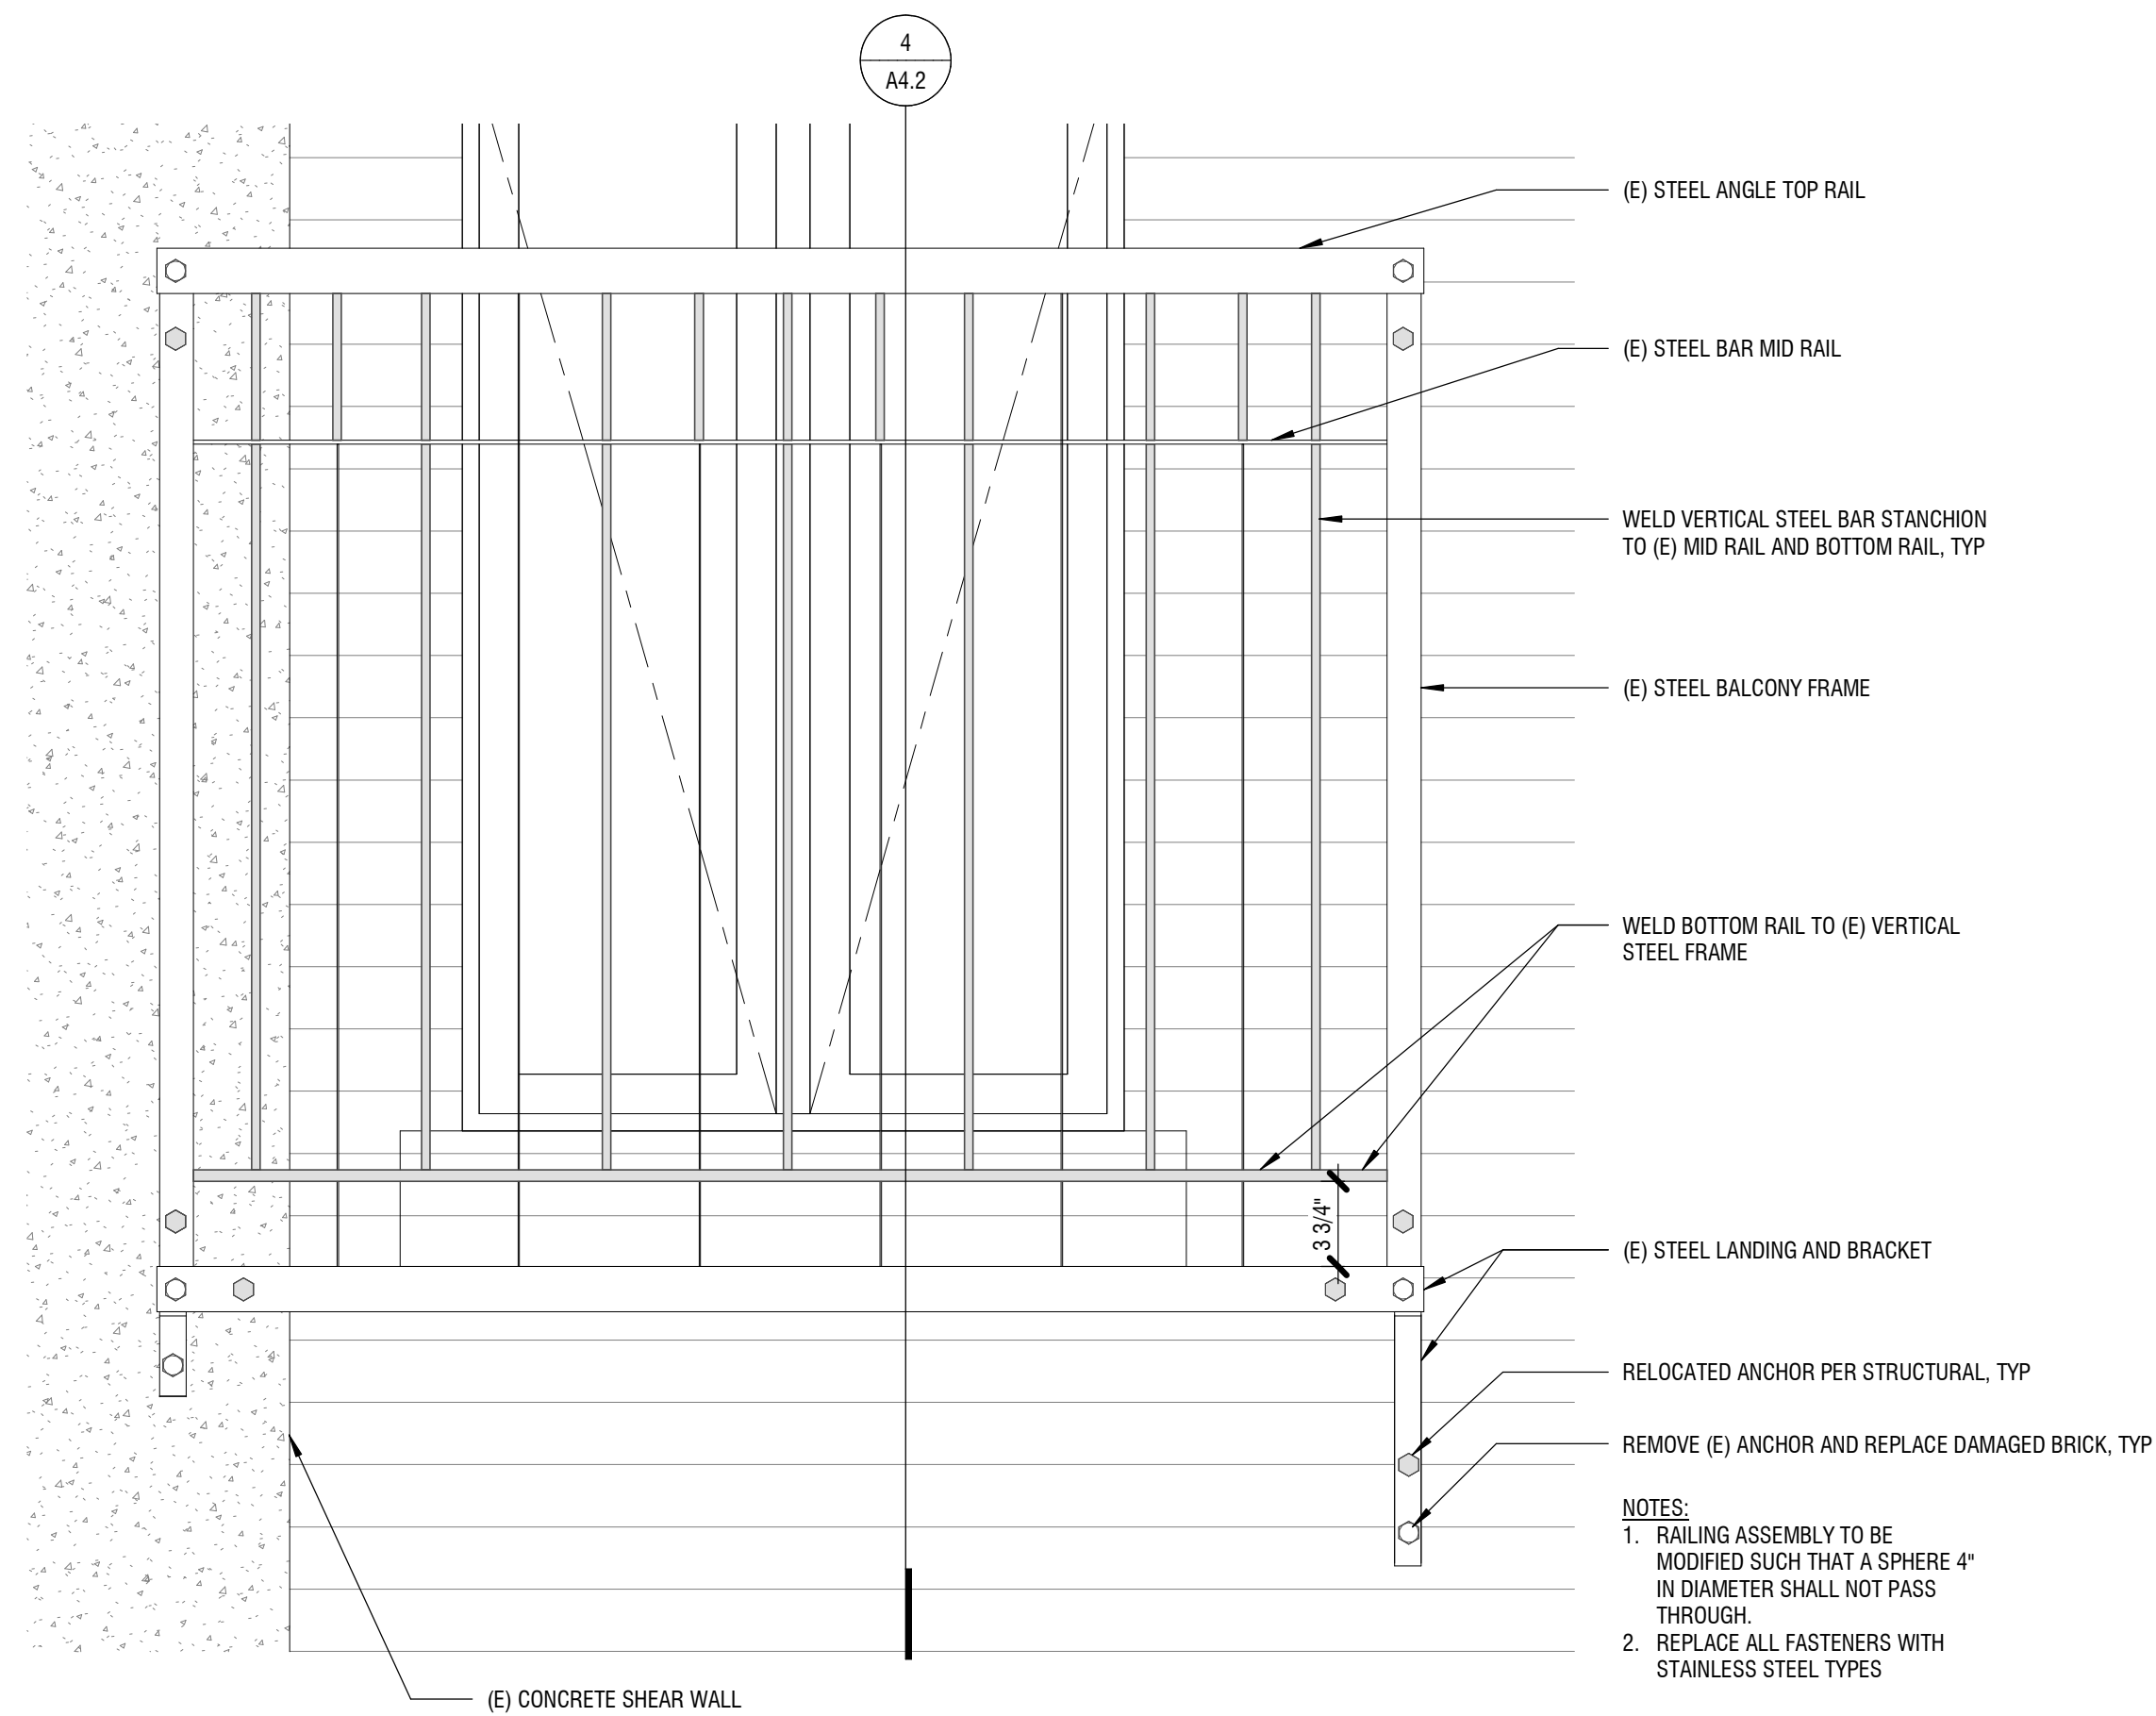
DCI APPROVAL STAMPS




1 STEEL BALCONY TYPE 3 PLAN
1 1/2" = 1'-0"



2 (E) WEST STEEL BALCONY
1/2" = 1'-0"



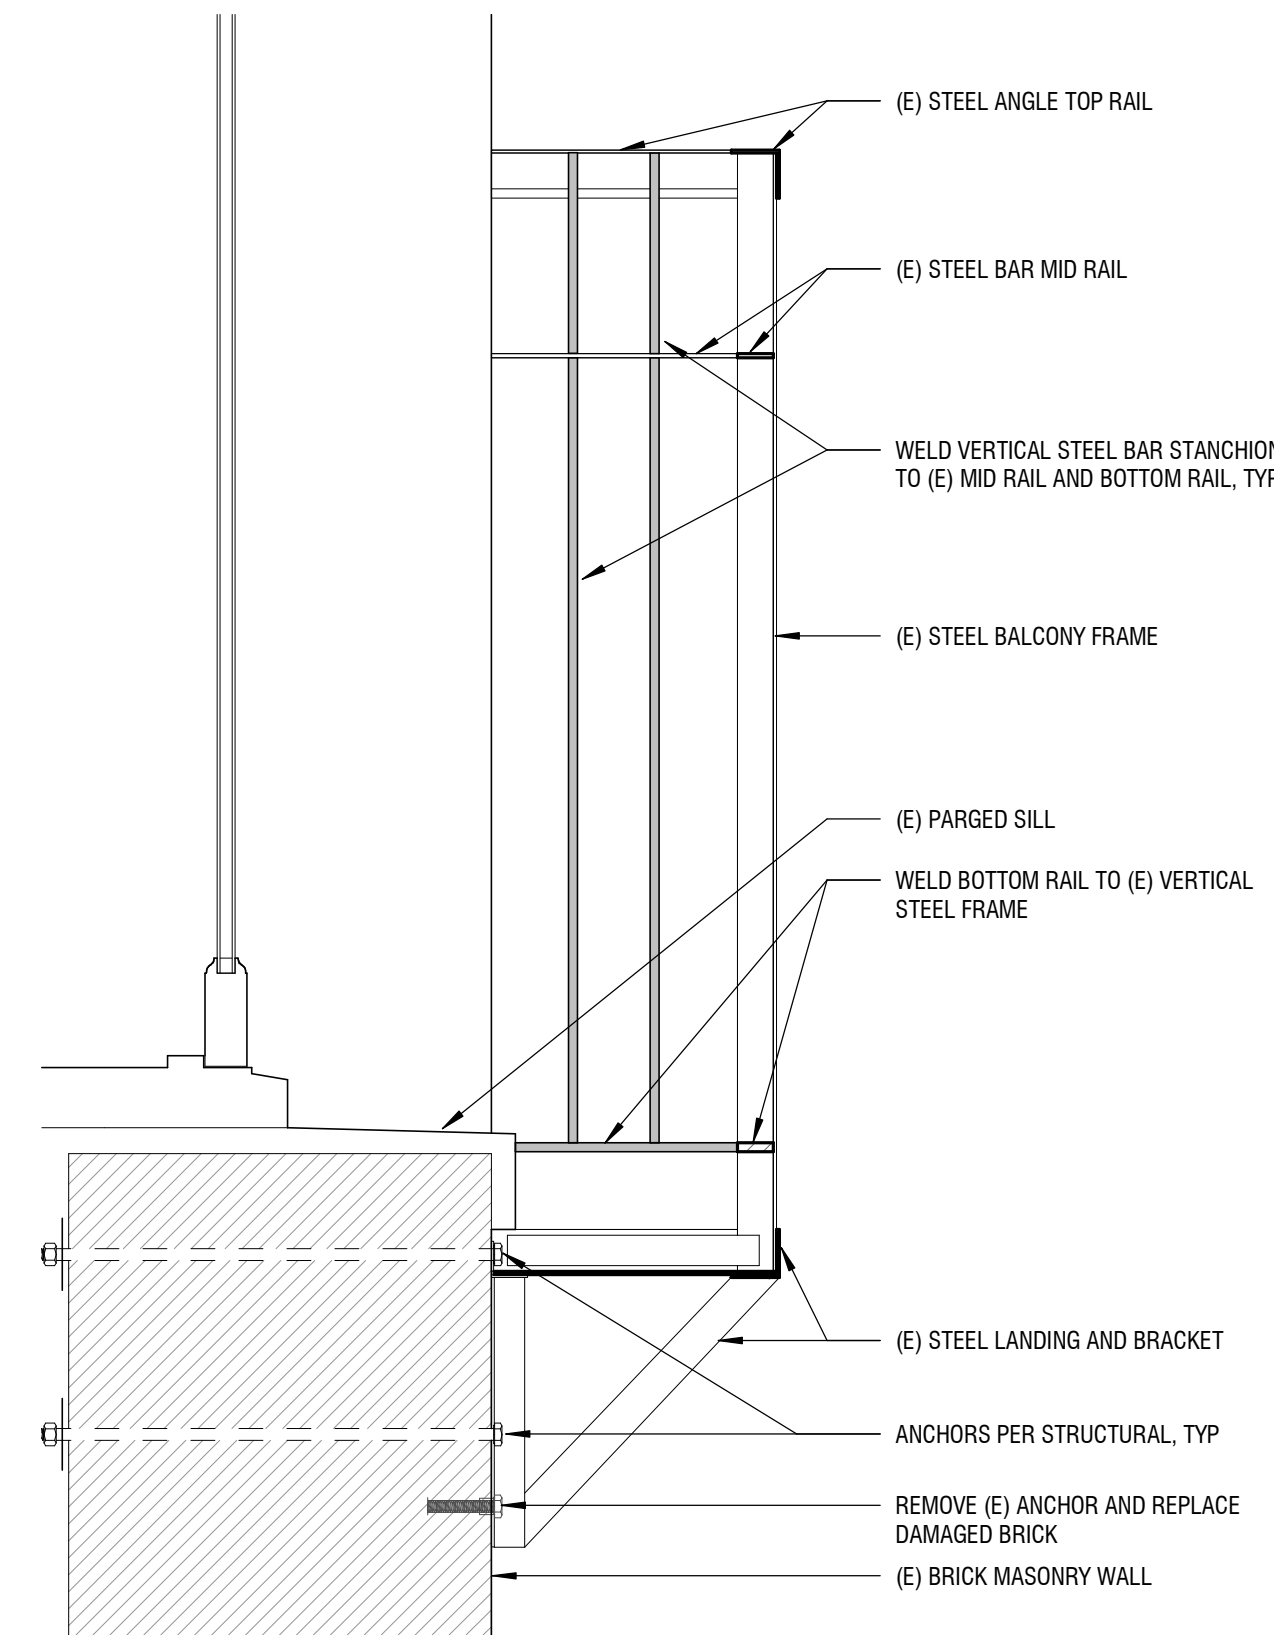3 STEEL BALCONY TYPE 3 ELEVATION
1 1/2" = 1'-0"



4 STEEL BALCONY TYPE 3 SECTION
1 1/2" = 1'-0"

THE COLONIAL
GRAND PACIFIC

FACADE
REPAIRS

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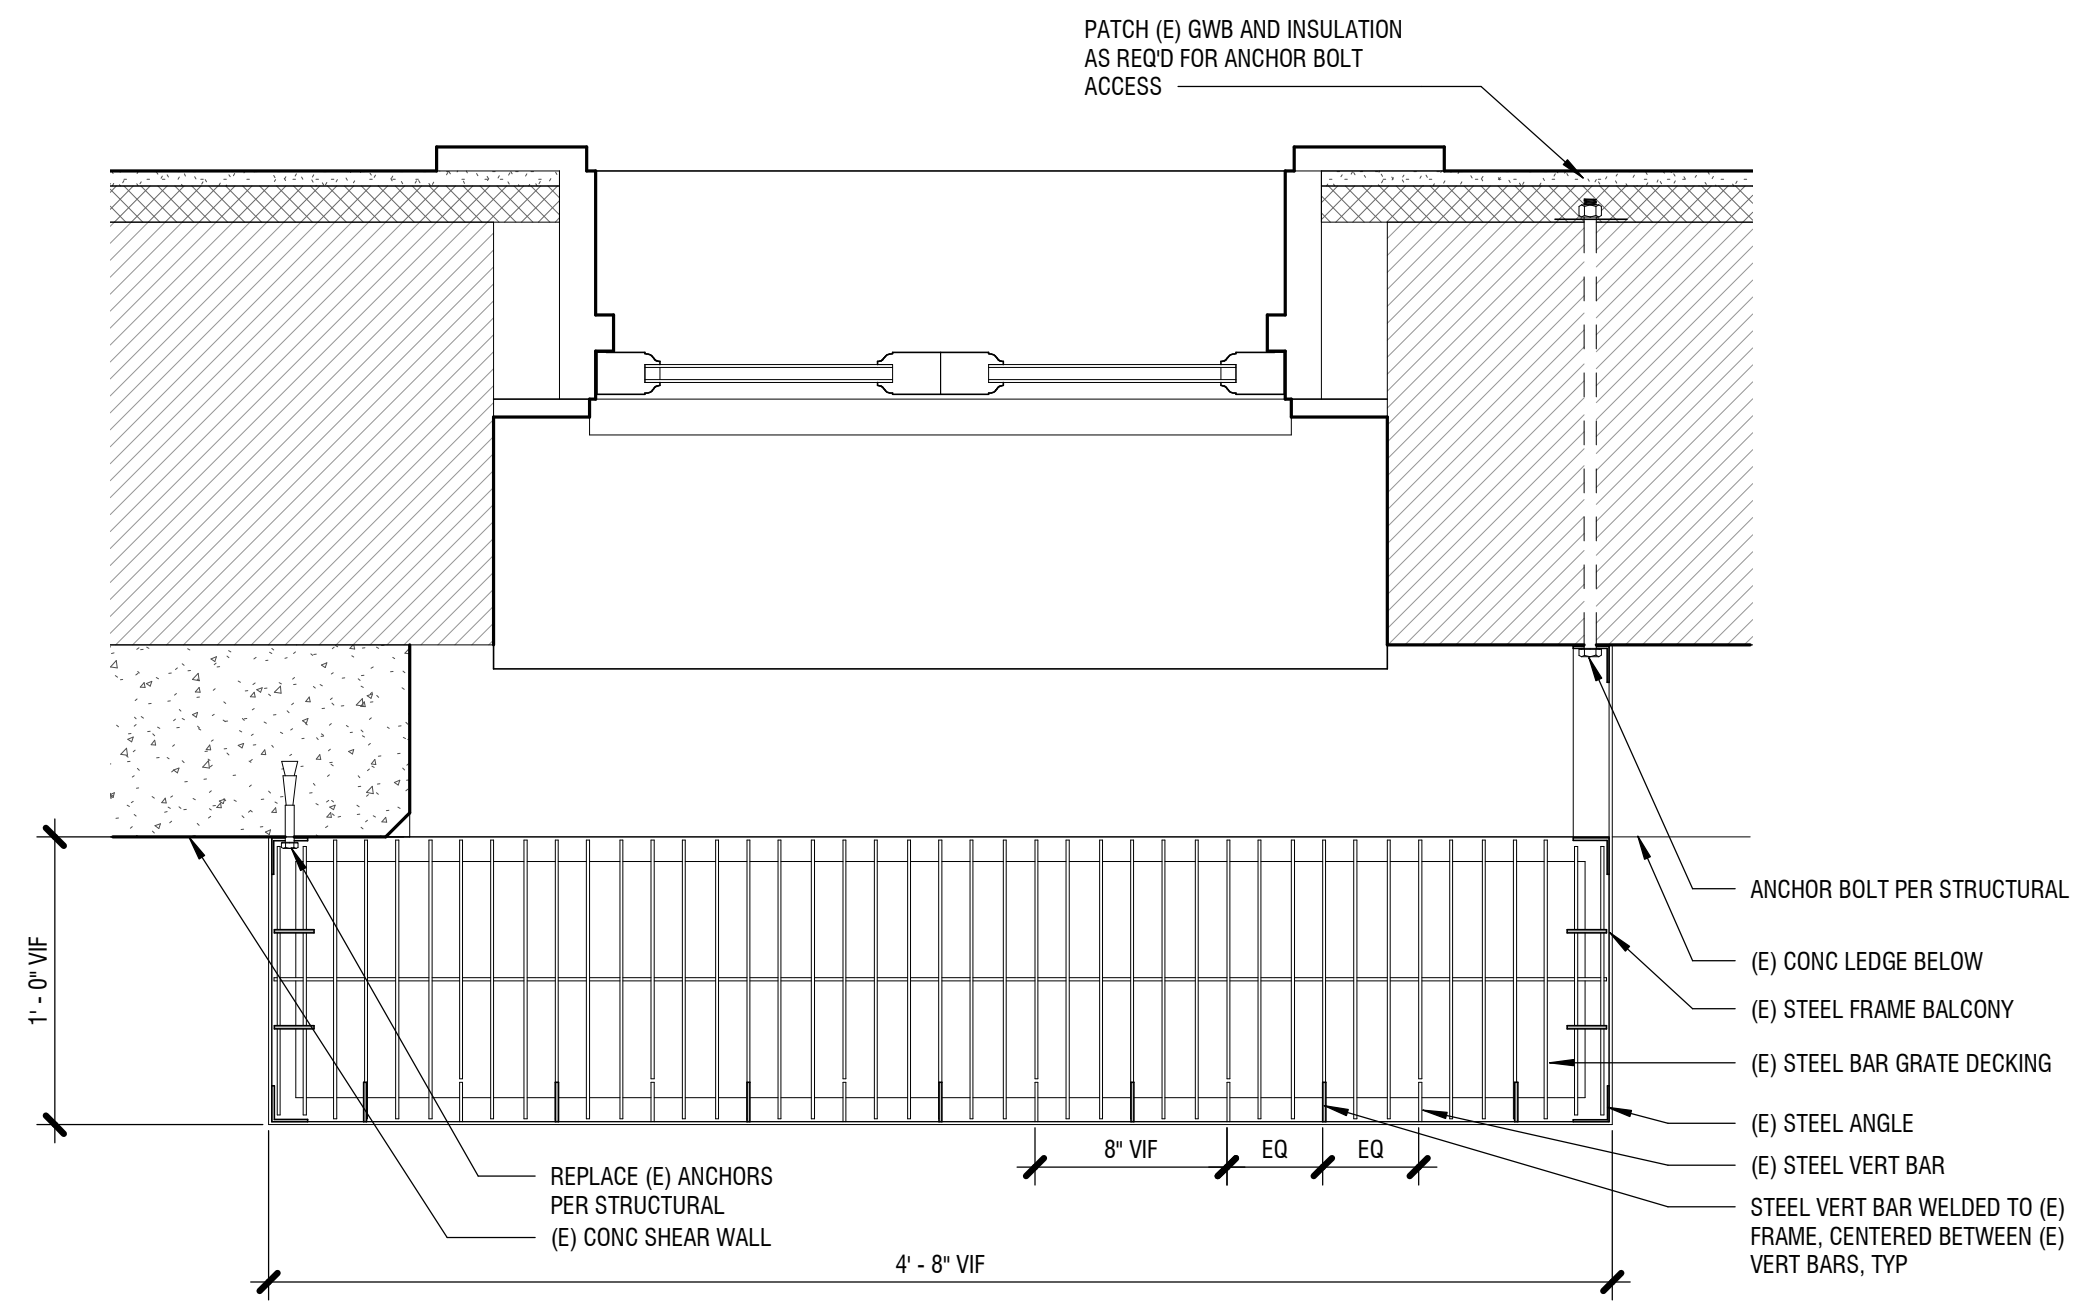
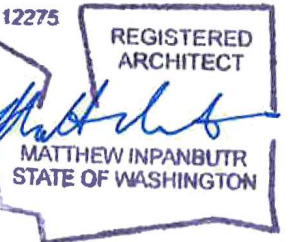
Revisions:
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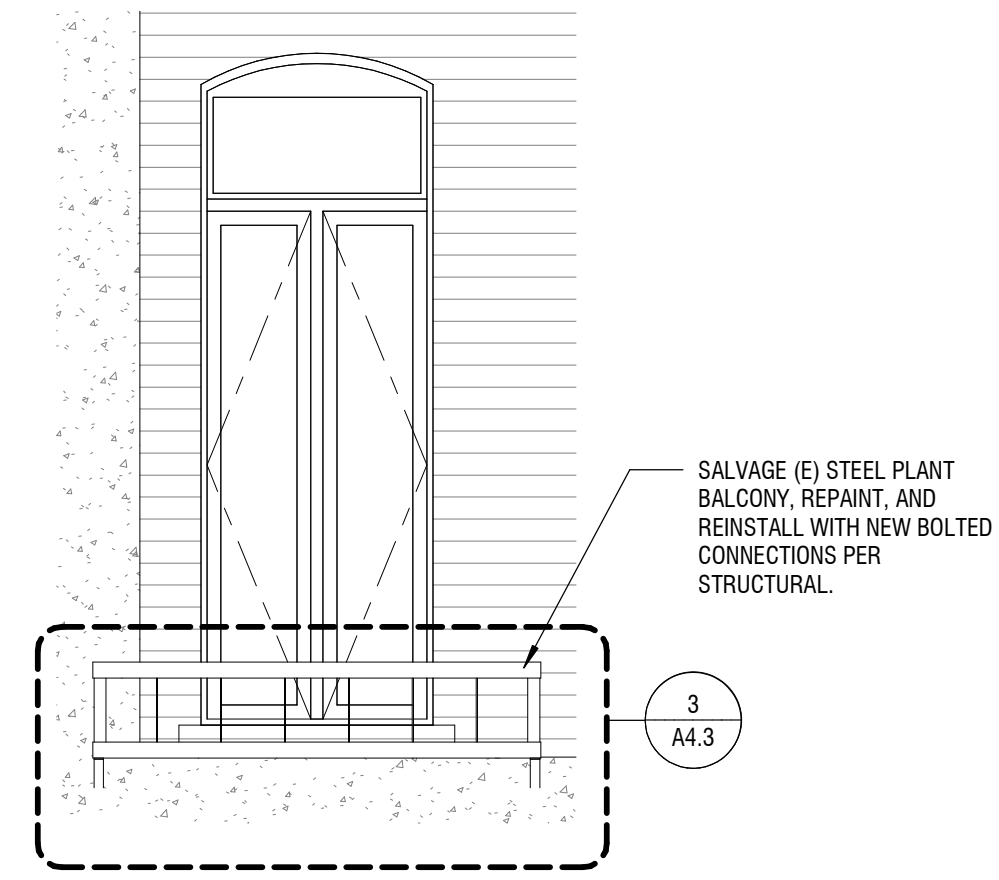
BALCONY TYPE 3
DETAILS

A4.2

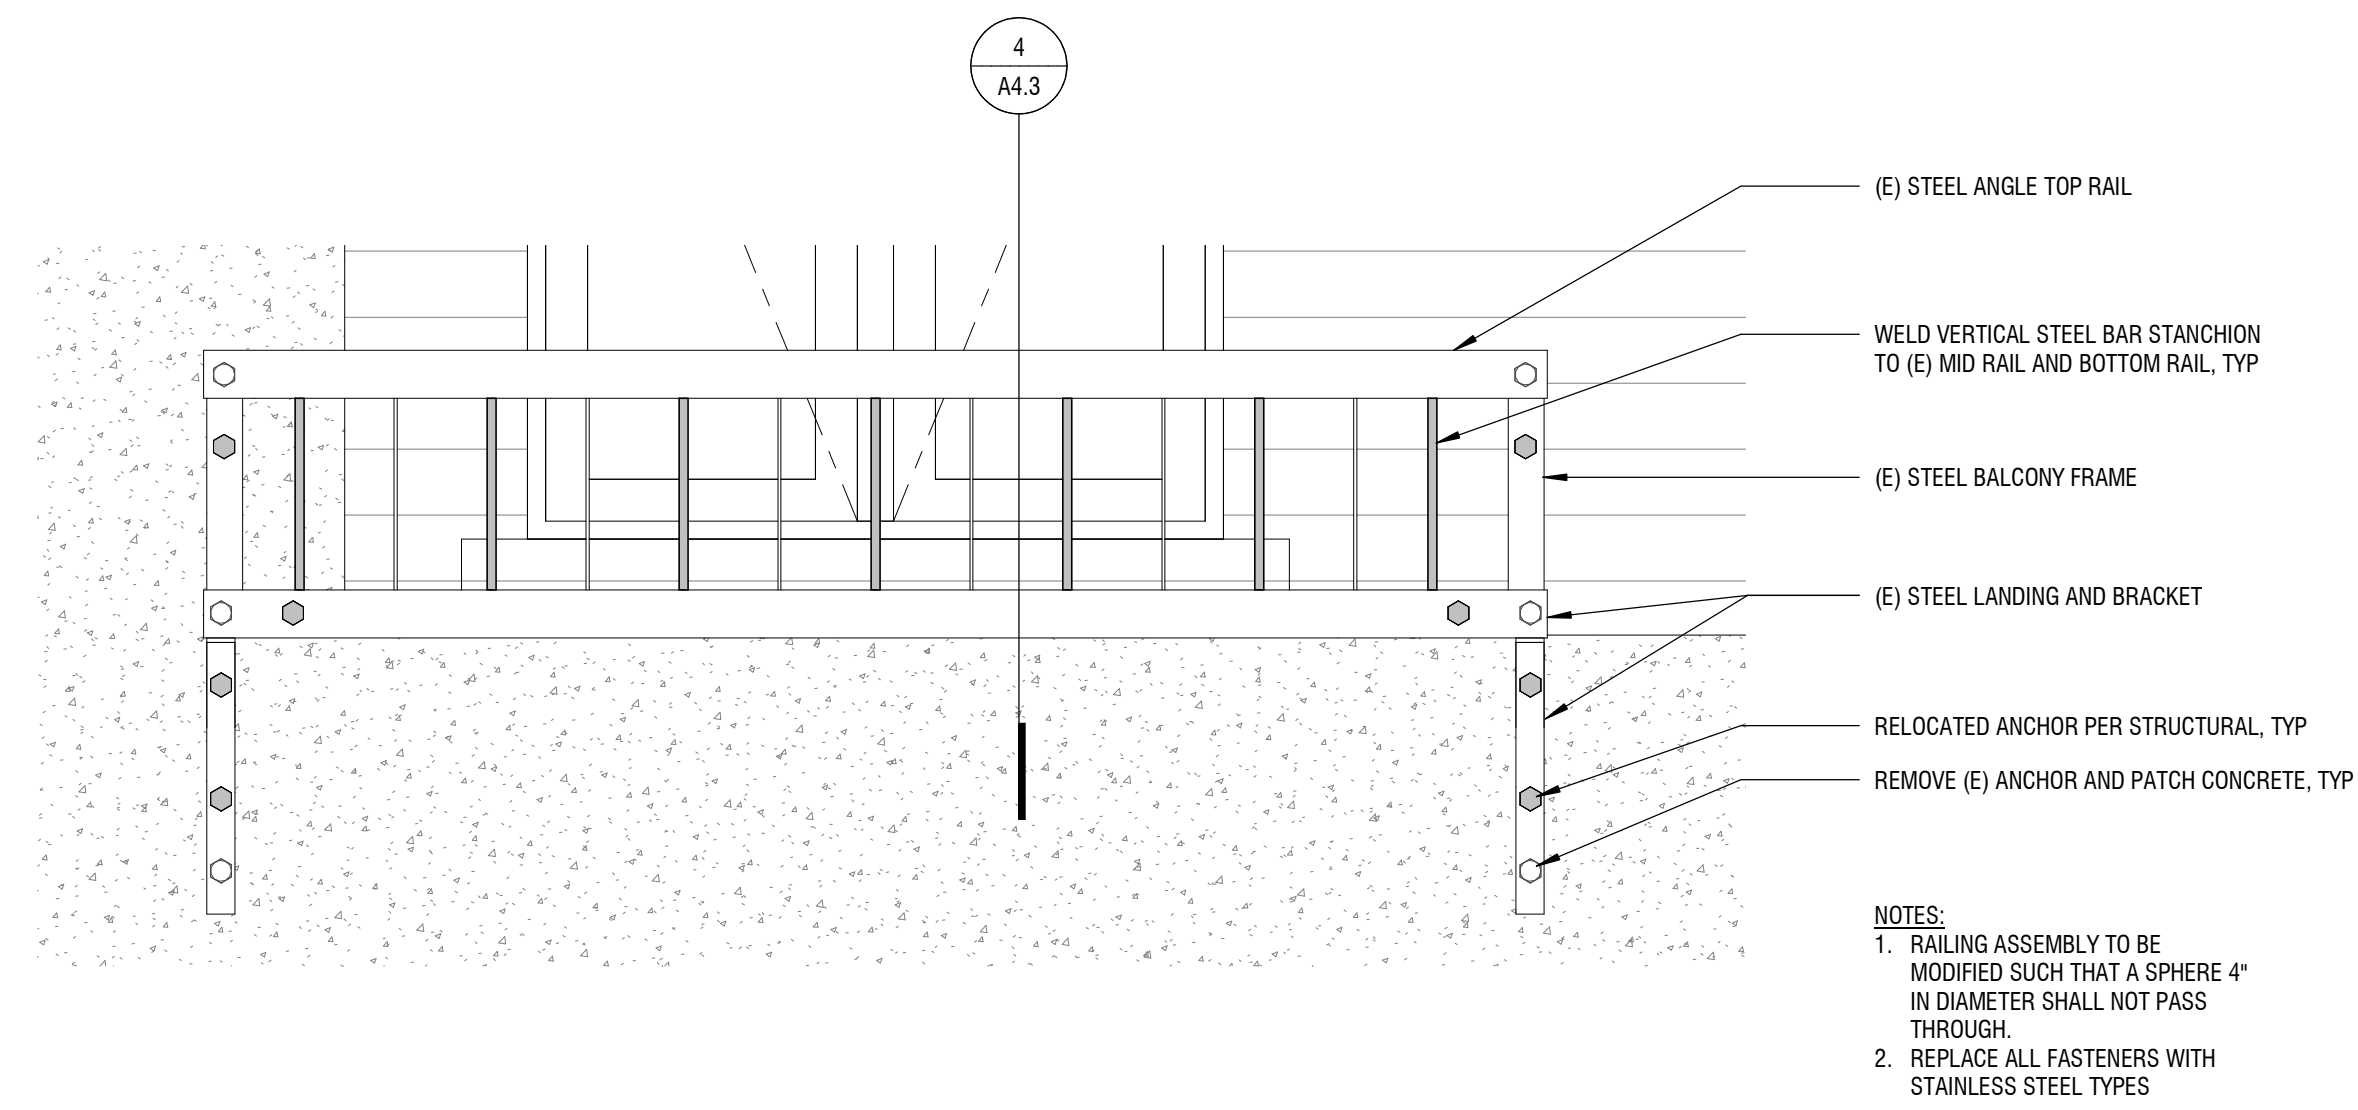
DCI APPROVAL STAMPS




1 STEEL BALCONY TYPE 4 PLAN
1 1/2" = 1'-0"



2 (E) WEST STEEL PLANT BALCONY
1/2" = 1'-0"



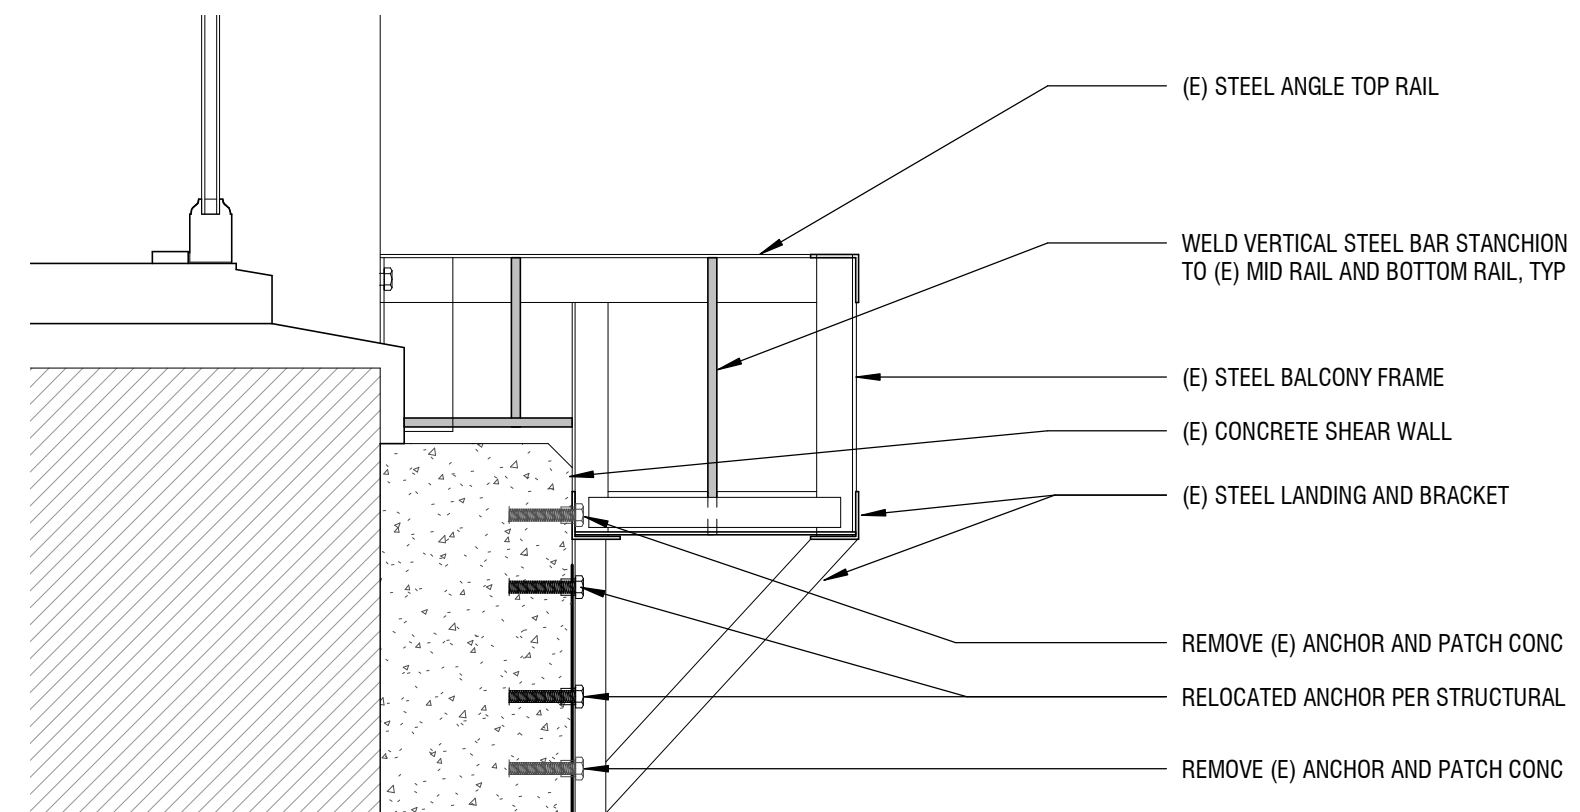3 STEEL BALCONY TYPE 4 ELEVATION
1 1/2" = 1'-0"



4 STEEL BALCONY TYPE 4 SECTION
1 1/2" = 1'-0"

THE COLONIAL GRAND PACIFIC

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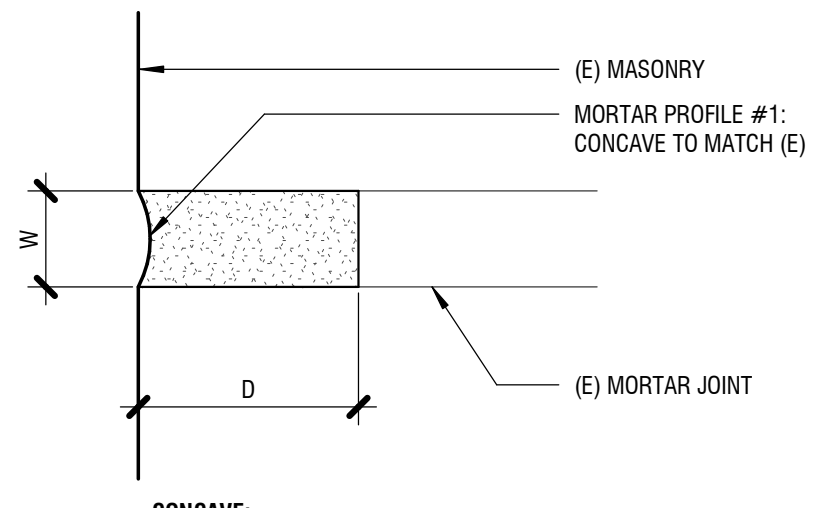
BALCONY TYPE 4 DETAILS

A4.3

DCI APPROVAL STAMPS

MORTAR JOINT PREPARATION:
 REFER TO SECTION 04 03 23 HISTORIC MASONRY, STONE AND TERRA COTTA REPOINTING FOR ADDITIONAL REQUIREMENTS

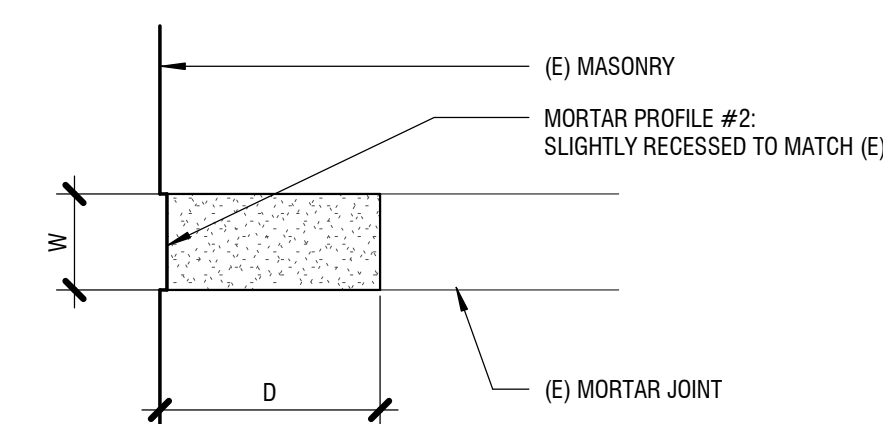
- REMOVE (E) MORTAR
- VERIFY JOINT IS CLEAR TO A MINIMUM DEPTH (D) SUCH THAT D IS TWO TO TWO AND A HALF TIMES THE WIDTH (W), OR TO DEPTH REQUIRED TO EXPOSE SOUND, UNWEATHERED MORTAR, AND A MINIMUM OF 3/4", WHICH EVER IS GREATER. DO NOT REMOVE UNSOUND MORTAR MORE THAN 2 INCHES DEEP. CONSULT ARCHITECT FOR DIRECTION.
- (E) MORTAR JOINT SHALL BE SQUARE TO (E) MASONRY
- CLEAN JOINT FREE OF DUST AND DEBRIS



CONCAVE:
 USE AT TERRA COTTA JOINTS UNLESS ALTERNATE PROFILE IS REQUIRED TO MATCH ADJACENT MORTAR PROFILE IN SELECTIVE REPOINTING APPLICATIONS.
 USE AT RED COMMON BRICK JOINTS UNLESS ALTERNATIVE PROFILE IS REQUIRED TO MATCH ADJACENT MORTAR PROFILE IN SELECTIVE REPOINTING APPLICATIONS.

1 MORTAR REPOINTING PROFILE 1
 6" = 1'-0"


MORTAR JOINT PREPARATION:
 REFER TO SECTION 04 03 23 HISTORIC MASONRY, STONE AND TERRA COTTA REPOINTING FOR ADDITIONAL REQUIREMENTS



FLUSH:
 USE AT PRESSED BRICK AND SANDSTONE JOINTS UNLESS ALTERNATE PROFILE IS REQUIRED TO MATCH ADJACENT MORTAR PROFILE IN SELECTIVE REPOINTING APPLICATIONS.


2 MORTAR REPOINTING PROFILE 2
 6" = 1'-0"

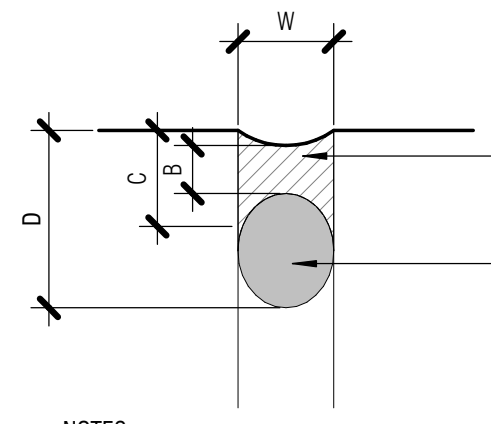CONVENTIONAL MOVING WEATHERSEAL



NOTES:
 1. DIMENSIONS C AND A MUST AT LEAST 1/4"
 2. RATIO OF A:B SHOULD BE 2:1 MIN
 3. JOINT SURFACE TOOLED CONCAVE
 4. DIMENSION B SUGGESTED MAXIMUM = 3/8"

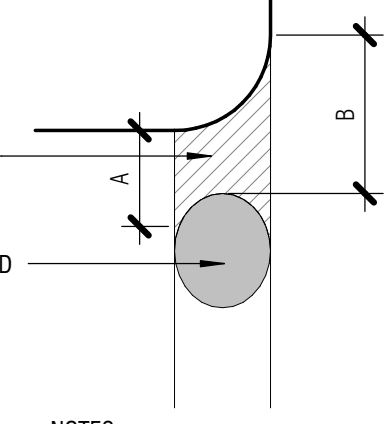HORIZONTAL TO VERTICAL JOINT




NOTES:
 1. DIMENSIONS A AND B ARE BOTH GREATER THAN 1/4"
 2. SEALANT TOOLED TO ENSURE POSITIVE RUNOFF OF WATER


3 TYP SEALANT JOINT & BACKER ROD
 3" = 1'-0"

SEALANT JOINT PREPARATION:
 REFER TO SECTION 07 65 99 LEAD STONE FLASHING FOR ADDITIONAL REQUIREMENTS

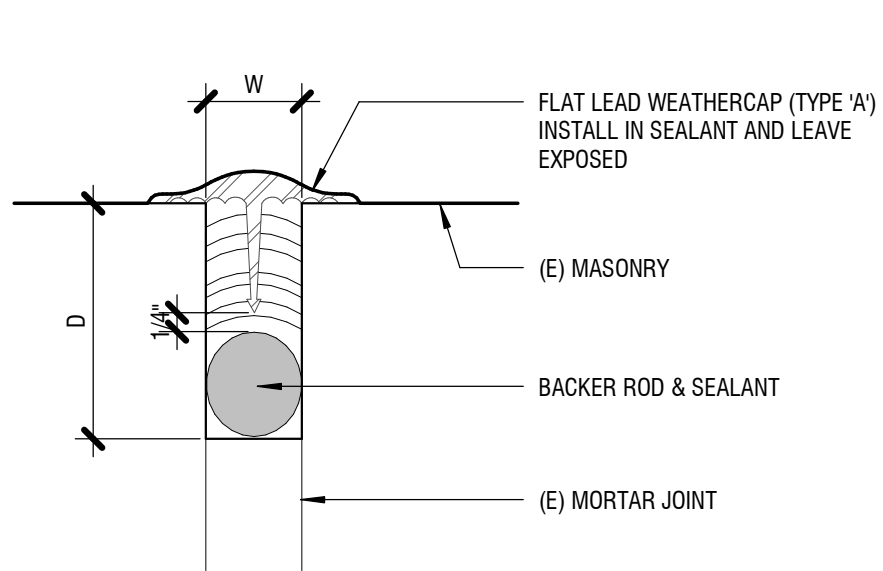- REMOVE (E) SEALANT OR MORTAR TO REQUIRED DEPTH
- VERIFY JOINT IS CLEAR TO MINIMUM DEPTH (D) SUCH THAT D IS AT LEAST TWO TO TWO AND A HALF TIMES THE WIDTH (W)
- CLEAN JOINT FREE OF DUST AND DEBRIS



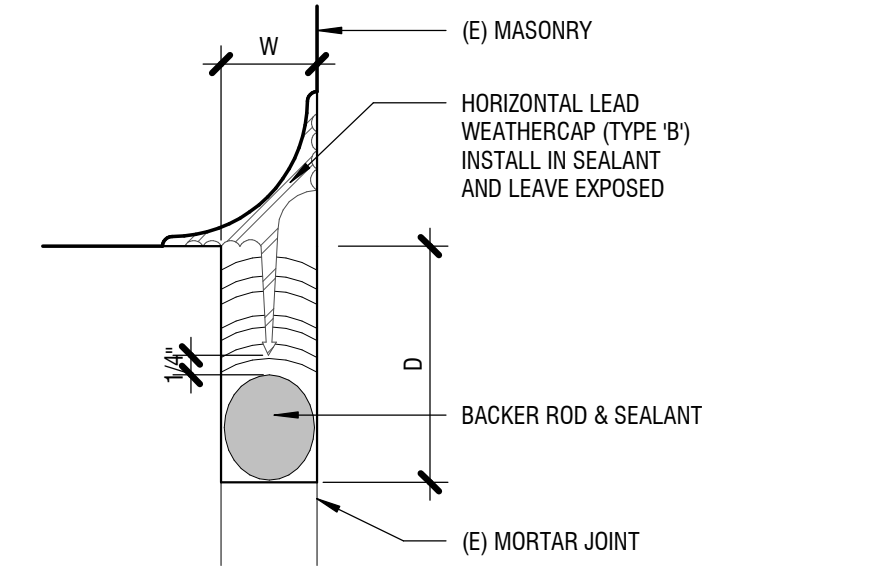
4 LEAD WEATHERCAP - VERTICAL JOINT
 6" = 1'-0"




5 LEAD WEATHERCAP - 90° JOINT
 6" = 1'-0"

SEALANT JOINT PREPARATION:
 REFER TO SECTION 04 00 00 MASONRY RESTORATION FOR ADDITIONAL REQUIREMENTS

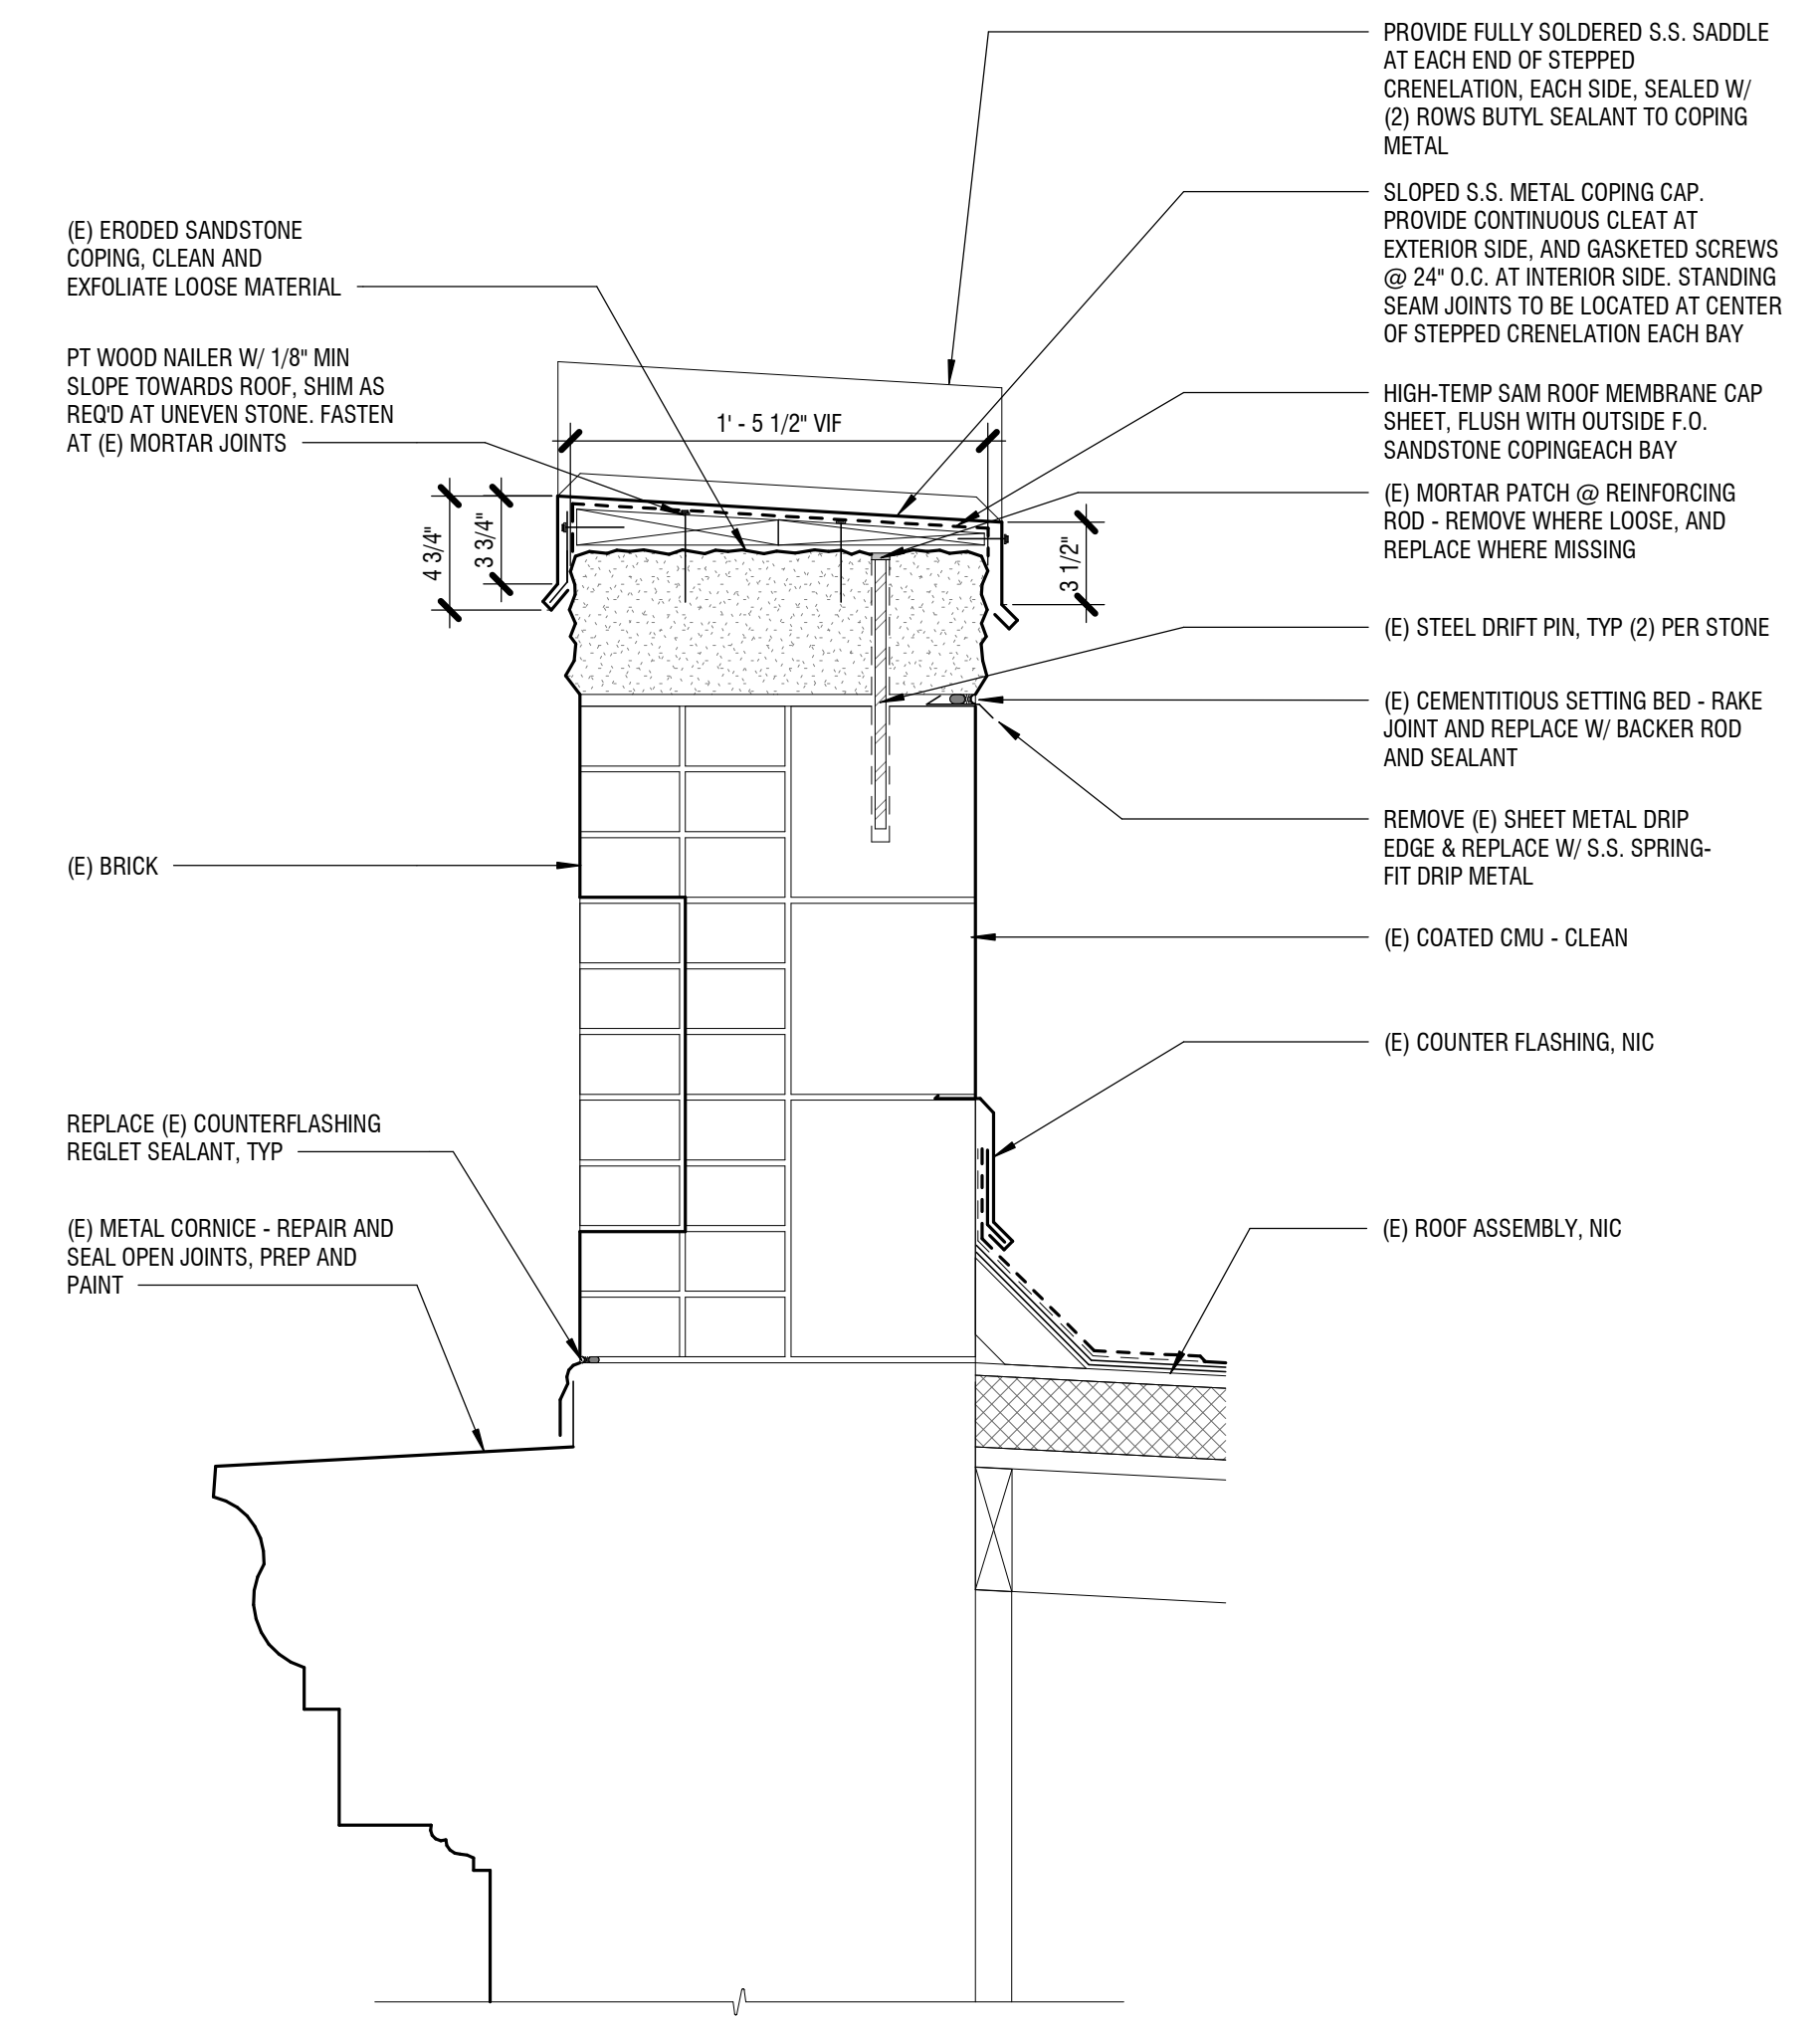- REMOVE (E) SEALANT
- VERIFY JOINT IS CLEAR TO A MINIMUM DEPTH (D) SUCH THAT D IS AT LEAST TWO TO TWO AND A HALF TIMES THE WIDTH (W)
- CLEAN JOINT FREE OF DUST AND DEBRIS




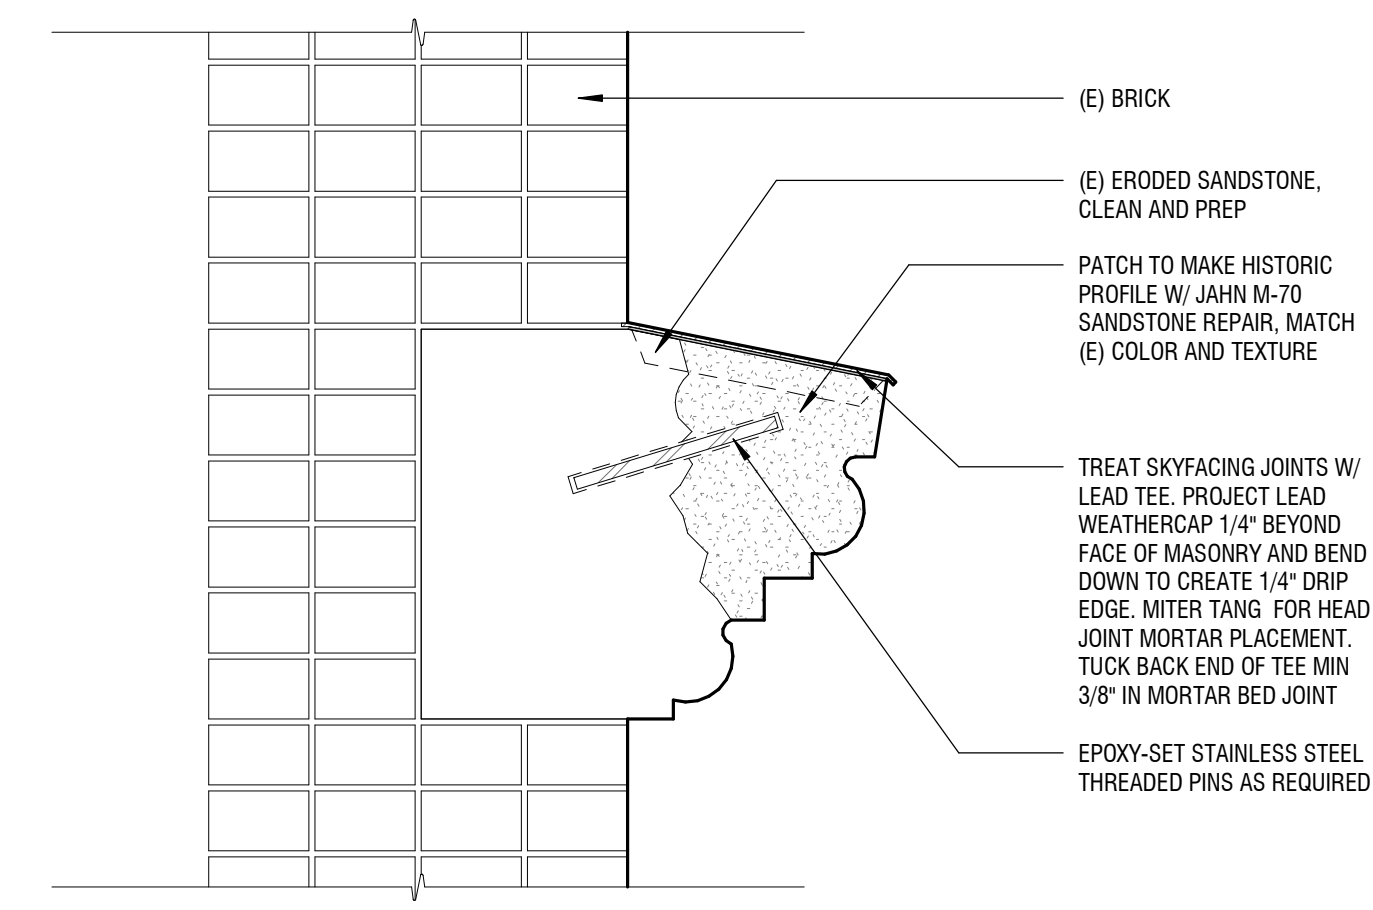6 GRAND PACIFIC - PARAPET CAP DETAIL
 1 1/2" = 1'-0"



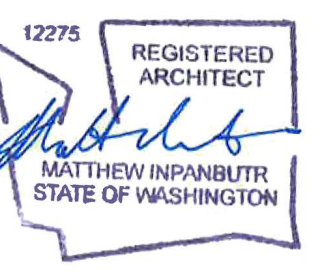7 SANDSTONE PATCH REPAIR
 1 1/2" = 1'-0"

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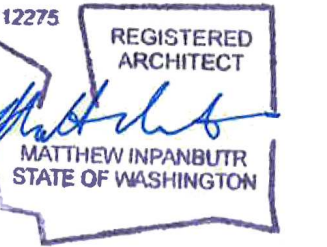
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DCI APPROVAL STAMPS

MASONRY &
 PARAPET
 DETAILS
A4.6



THE COLONIAL
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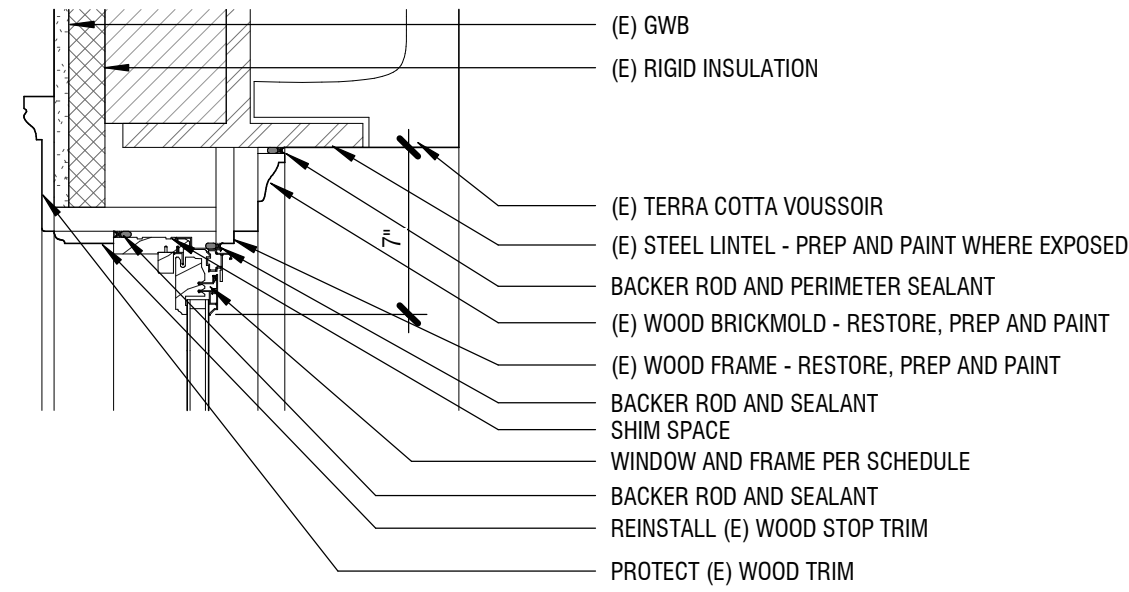
Revisions:
No. Date Remarks

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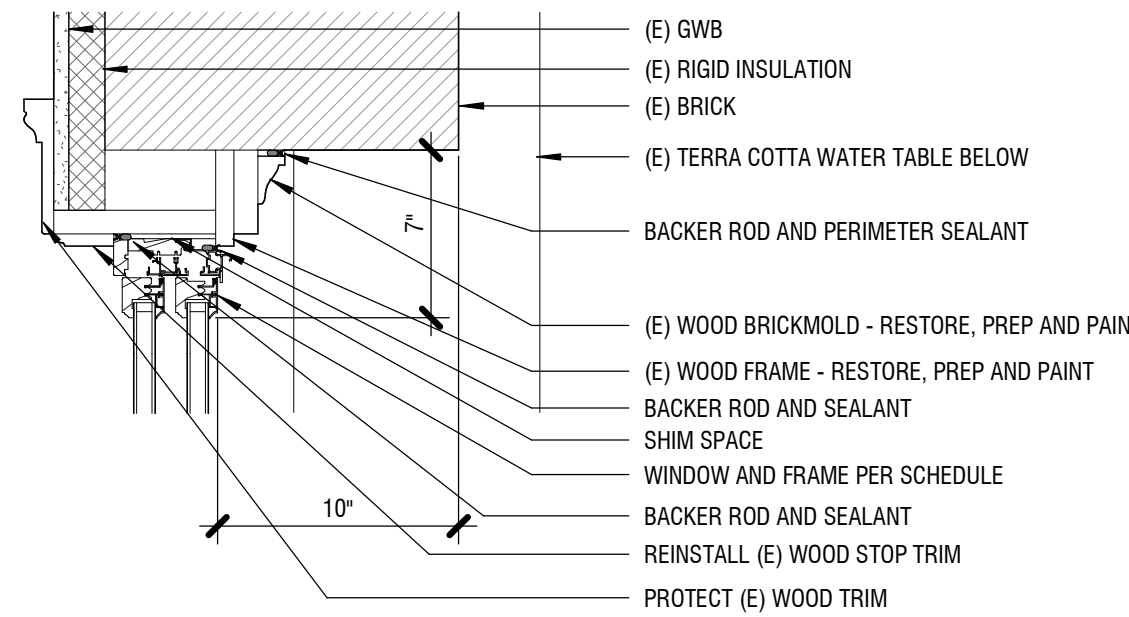
WINDOW DETAILS

A5.0

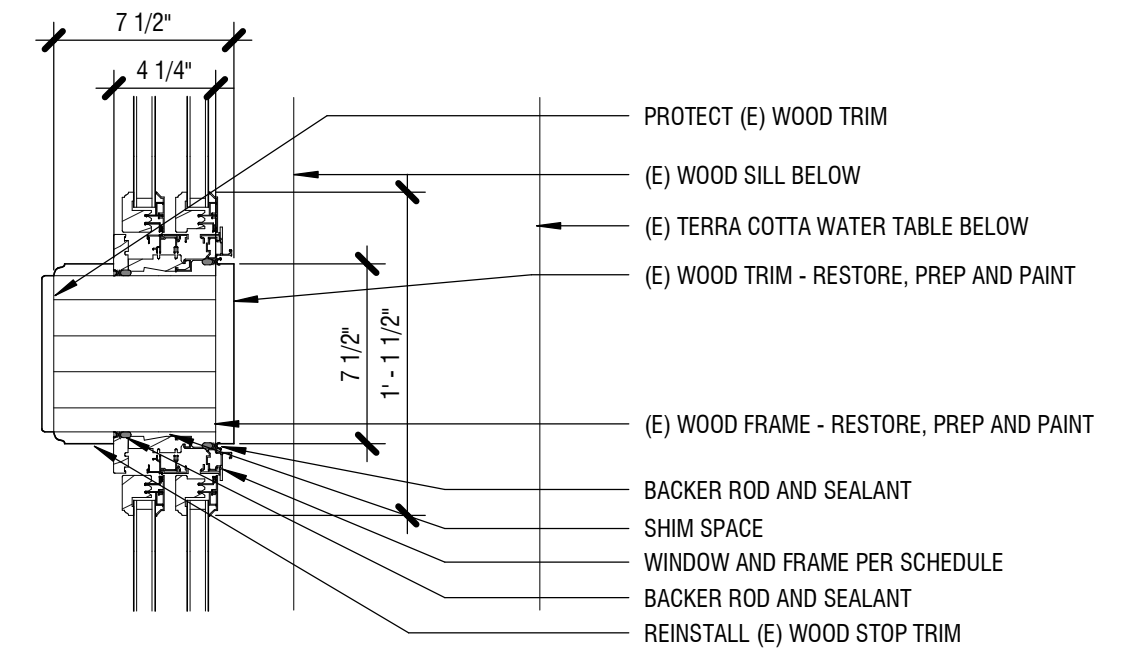
DCI APPROVAL STAMPS




5 WINDOW TYPE D - HEAD DETAIL
1 1/2" = 1'-0"




6 WINDOW TYPE D - JAMB DETAIL
1 1/2" = 1'-0"



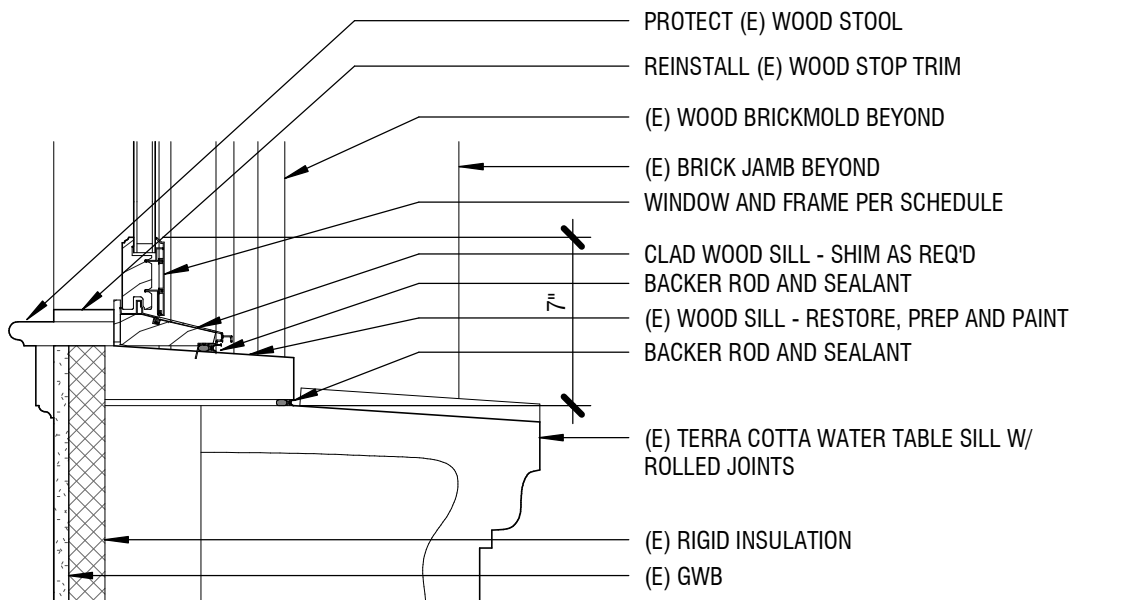
7 WINDOW TYPE D - MULLION DETAIL
1 1/2" = 1'-0"



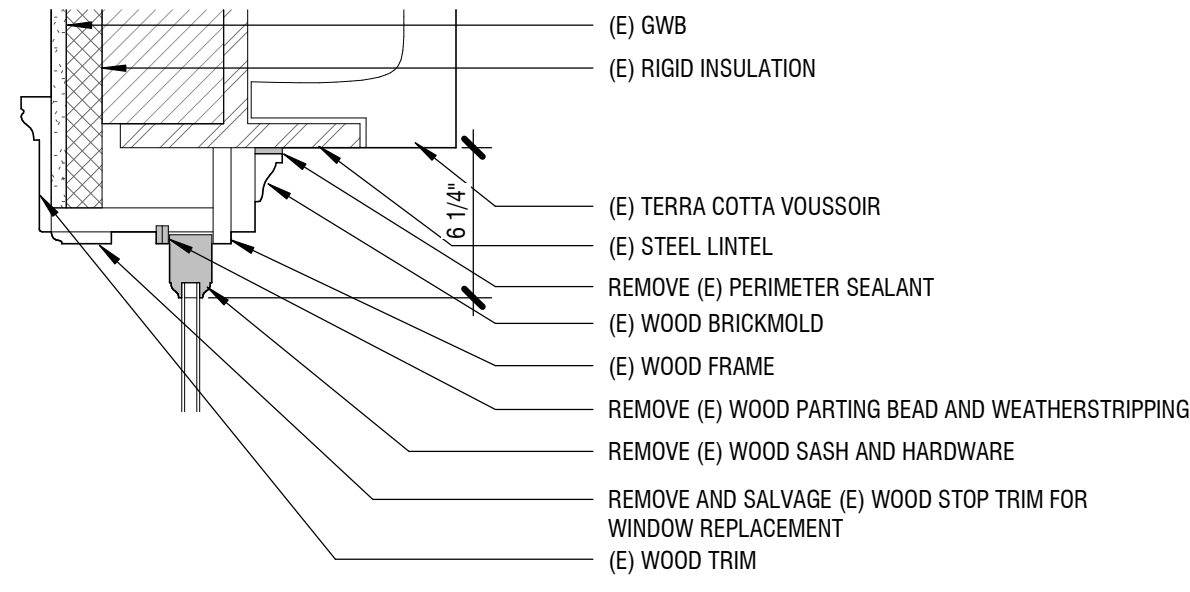
8 WINDOW TYPE D - SILL DETAIL
1 1/2" = 1'-0"



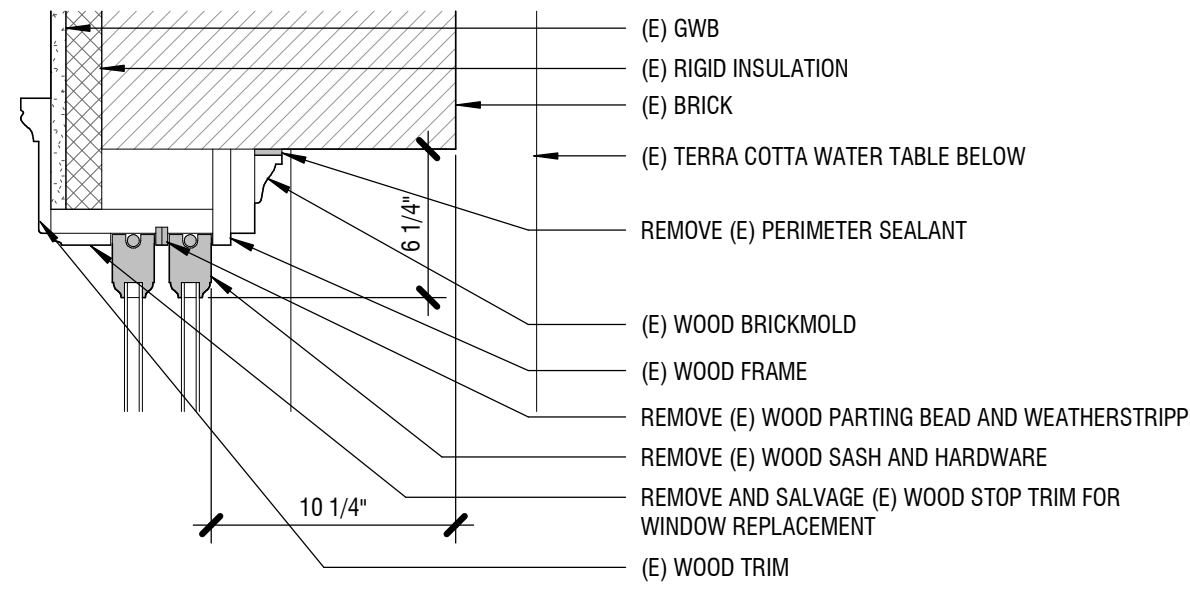
1 WINDOW TYPE D - DEMO HEAD DETAIL
1 1/2" = 1'-0"



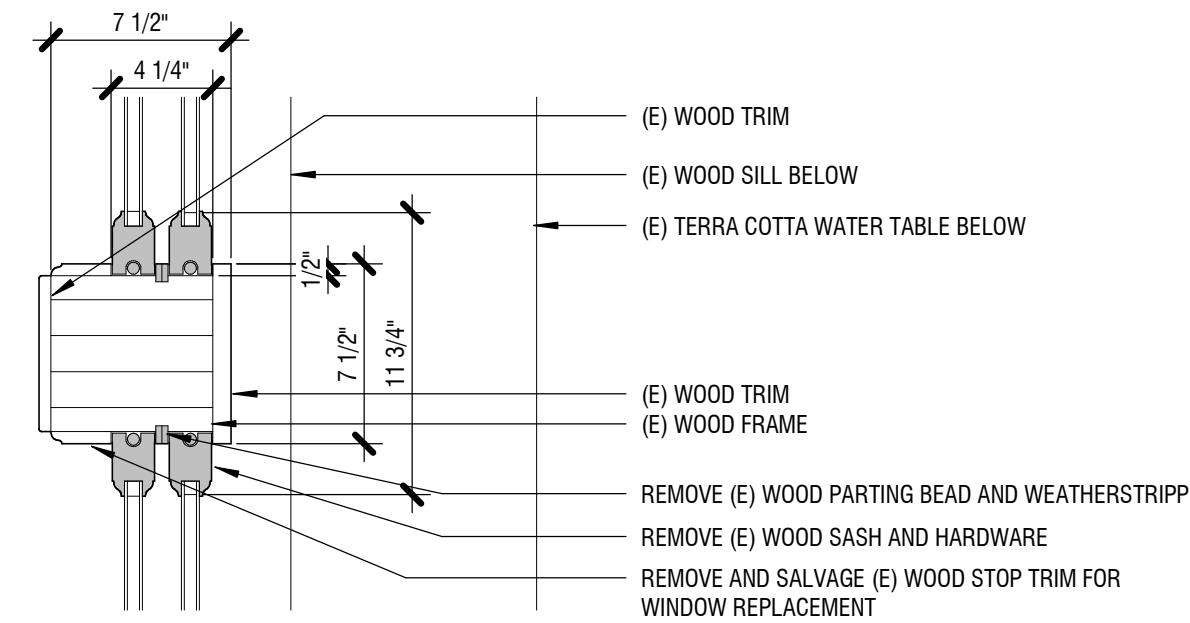2 WINDOW TYPE D - DEMO JAMB DETAIL
1 1/2" = 1'-0"



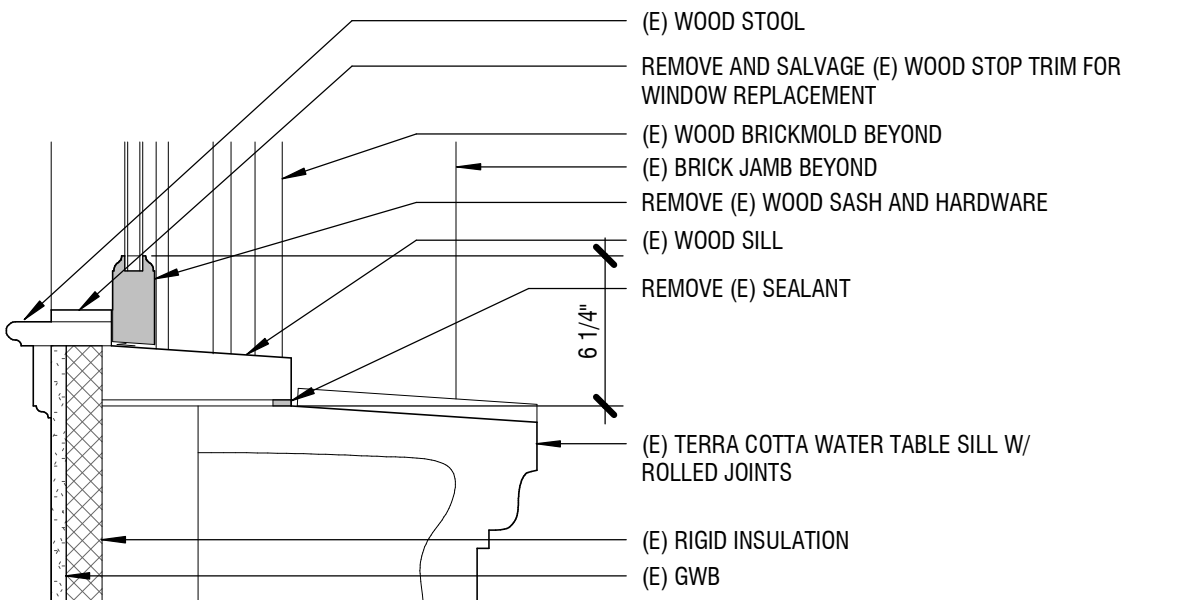3 WINDOW TYPE D - DEMO MULLION DETAIL
1 1/2" = 1'-0"



4 WINDOW TYPE D - DEMO SILL DETAIL
1 1/2" = 1'-0"


DRAWING LIST

| | |
|------|--|
| S0.0 | STRUCTURAL NOTES AND DRAWING LIST (IBC 2015) |
| S0.1 | STATEMENT OF SPECIAL INSPECTIONS (IBC 2015) |
| S4.0 | BALCONY DETAILS |
| S4.1 | BALCONY DETAILS |
| S4.2 | BALCONY DETAILS |

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| Checked: | _____ | |
| Date: | 2/16/2021 | |
| Scale: | 1/2" = 1'-0" | |
| Revisions: | | |
| No. | Date | Remarks |

NOT FOR CONSTRUCTION

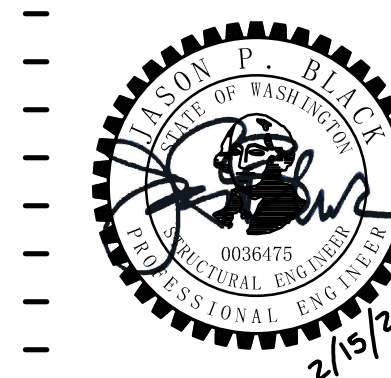STRUCTURAL
NOTES AND
DRAWING LIST
(IBC 2015)

S0.0

STRUCTURAL NOTES

DESIGN LOADS

ALL DESIGN AND CONSTRUCTION SHALL CONFORM TO THE REQUIREMENTS OF THE EXISTING BUILDING CODE (EBC), 2015 EDITION, AS AMENDED BY THE CITY OF SEATTLE IN THE SEATTLE EXISTING BUILDING CODE (SEBC), 2015 EDITION.

LIVE LOADS
IN ADDITION TO THE DEAD LOADS, THE FOLLOWING FLOOR LIVE LOADS WERE USED FOR DESIGN. LIVE LOAD REDUCTION IS PER IBC SECTION 1607.10.

| | | | |
|---------------------------|-----------------------|------------------|--------------------|
| | | <u>REDUCIBLE</u> | <u>UNREDUCIBLE</u> |
| EXTERIOR BALCONIES, DECKS | 1.5X OCCUPANCY SERVED | X | X |
| RESIDENTIAL FLOOR | 40 PSF | X | X |

REFER TO TABLE 1607.1 IN THE IBC FOR RELEVANT CONCENTRATED LIVE LOADS.

SEISMIC LOADS
EARTHQUAKE DESIGN FOR THE SUPPORT OF NOT STRUCTURAL ELEMENTS IS BASED ON THE SEISMIC DESIGN REQUIREMENTS OF NONSTRUCTURAL COMPONENTS IN ASCE 7 CHAPTER 13 WITH THE FOLLOWING FACTORS:

SITE CLASS D
RISK CATEGORY II
SEISMIC DESIGN CATEGORY D
I_e = 1.0
S_a = 1.367 g
S₁ = 0.53 g
S_{0.2} = 0.911 g
S_{0.1} = 0.53 g

GENERAL NOTES

SUBMITTALS
SHOP DRAWINGS SHALL BE SUBMITTED TO THE ARCHITECT PRIOR TO ANY FABRICATION OR CONSTRUCTION FOR ALL STRUCTURAL ITEMS, INCLUDING THE FOLLOWING: STRUCTURAL STEEL.

IF THE SHOP DRAWINGS DIFFER FROM OR ADD TO THE DESIGN OF THE STRUCTURAL DRAWINGS, THEY SHALL BEAR THE SEAL AND SIGNATURE OF THE WASHINGTON STATE REGISTERED PROFESSIONAL ENGINEER WHO IS RESPONSIBLE FOR THE DESIGN.

DEFERRED SUBMITTALS
PER IBC SECTION 107.3.4.1, DRAWINGS AND CALCULATIONS FOR THE DESIGN AND FABRICATION OF ITEMS THAT ARE DESIGNED BY OTHERS SHALL BEAR THE SEAL AND SIGNATURE OF THE WASHINGTON STATE REGISTERED PROFESSIONAL ENGINEER WHO IS RESPONSIBLE FOR THE DESIGN AND SHALL BE SUBMITTED TO THE ARCHITECT AND THE BUILDING DEPARTMENT FOR REVIEW PRIOR TO FABRICATION. DEFERRED SUBMITTALS INCLUDE BUT ARE NOT LIMITED TO THE FOLLOWING:

ALTERNATE ANCHORS (WHEN ALTERNATE ANCHORS ARE PROPOSED)

INSPECTION
SPECIAL INSPECTION PER IBC CHAPTER 17 SHALL BE PERFORMED BY AN APPROVED TESTING AGENCY AS INDICATED IN THE STATEMENT OF SPECIAL INSPECTIONS AND TESTING. ALL PREPARED SOIL-BEARING SURFACES SHALL BE INSPECTED BY THE GEOTECHNICAL ENGINEER PRIOR TO PLACEMENT OF REINFORCING STEEL. SOILS COMPACTION SHALL BE SUPERVISED BY AN APPROVED TESTING AGENCY OR GEOTECHNICAL ENGINEER.

SPECIAL CONDITIONS
CONTRACTOR SHALL VERIFY ALL LEVELS, DIMENSIONS, AND EXISTING CONDITIONS IN THE FIELD BEFORE PROCEEDING. CONTRACTOR SHALL NOTIFY THE ARCHITECT OF ANY DISCREPANCIES OR FIELD CHANGES PRIOR TO INSTALLATION OR FABRICATION. IN CASE OF DISCREPANCIES BETWEEN THE EXISTING CONDITIONS AND THE DRAWINGS, THE CONTRACTOR SHALL OBTAIN DIRECTION FROM THE ARCHITECT BEFORE PROCEEDING. DIMENSIONS NOTED AS PLUS OR MINUS (+) INDICATE UNVERIFIED DIMENSIONS AND ARE APPROXIMATE. NOTIFY ARCHITECT IMMEDIATELY OF CONFLICTS OR EXCESSIVE VARIATIONS FROM INDICATED DIMENSIONS. NOTED DIMENSIONS TAKE PRECEDENCE OVER SCALED DIMENSIONS—DO NOT SCALE DRAWINGS. DIMENSIONS OF EXISTING CONDITIONS MAY BE BASED ON RECORD DRAWINGS AND ARE TO BE FIELD-VERIFIED BY THE CONTRACTOR.

CONTRACTOR SHALL VERIFY ALL EXISTING CONDITIONS BEFORE COMMENCING ANY DEMOLITION. CONTRACTOR SHALL PROVIDE ADEQUATE SHORING AND BRACING OF ALL STRUCTURAL MEMBERS, EXISTING CONSTRUCTION AND SOIL EXCAVATIONS, AS REQUIRED, AND IN A MANNER SUITABLE TO THE WORK SEQUENCE. TEMPORARY SHORING AND BRACING SHALL NOT BE REMOVED UNTIL ALL FINAL CONNECTIONS HAVE BEEN COMPLETED IN ACCORDANCE WITH THE DRAWINGS AND MATERIALS HAVE ACHIEVED DESIGN STRENGTH. NO REINFORCING BARS IN EXISTING CONSTRUCTION SHALL BE CUT UNLESS DIRECTED TO BY THE ARCHITECT OR AS SHOWN ON THE DRAWINGS.

CONTRACTOR SHALL BE RESPONSIBLE FOR ALL SAFETY PRECAUTIONS AND THE METHODS, TECHNIQUES, SEQUENCES OR PROCEDURES REQUIRED TO PERFORM THE WORK.

ANCHORS

POST-INSTALLED ANCHORS
PROVIDE POST-INSTALLED ANCHORS AS SPECIFIED IN THESE DRAWINGS.

ADHESIVE REINFORCING DOWEL MATERIALS

| | |
|-----------------------------------|--------------------------------------|
| ADHESIVE REINFORCING DOWELS (ARD) | ASTM A 615, GRADE 60 |
| THREADED ARD | ASTM F 1554, GRADE 36 (CARBON STEEL) |
| | ASTM A193 B8M CLASS 1 (STAINLESS) |

ANCHOR EMBEDMENT DEPTHS LISTED SHALL BE CONSIDERED EFFECTIVE EMBEDMENT DEPTHS AS DEFINED IN THE ICC-ES OR IAPMO UES EVALUATION REPORTS. PROVIDE ANCHOR LENGTH AND HOLE PER EVALUATION REPORT TO ACCOMMODATE THE EFFECTIVE EMBEDMENT SPECIFIED IN THESE DRAWINGS.

MECHANICAL AND ADHESIVE ANCHORS SHALL BE ZINC PLATED CARBON STEEL UNLESS NOTED OTHERWISE. MECHANICAL AND ADHESIVE ANCHORS EXPOSED TO WEATHER SHALL BE STAINLESS STEEL.

USE OF ALTERNATE PRODUCTS, OR OF POST-INSTALLED ANCHORS AT LOCATIONS NOT SHOWN IN THESE DRAWINGS, IS SUBJECT TO THE APPROVAL OF THE ARCHITECT. SUBMIT PROPOSED ANCHORS TO THE ARCHITECT WITH AN ICC-ES OR IAPMO UES REPORT VALID FOR THE 2015 IBC AND DOCUMENTATION SHOWING THAT THE ALTERNATE PRODUCTS PROVIDE EQUIVALENT CAPACITY FOR ALL CONDITIONS IN THIS PROJECT. SUBMITTED ICC-ES AND IAPMO UES REPORTS SHALL DEMONSTRATE THAT THE ANCHORS ARE SUITABLE FOR USE IN CRACKED CONCRETE OR UNCRACKED, FULLY GROUTED REINFORCED CONCRETE MASONRY UNITS, WHERE ANCHORS RESIST SEISMIC LOADS. SUBMITTED ICC-ES AND IAPMO UES REPORTS SHALL DEMONSTRATE THAT THE ANCHORS ARE SUITABLE FOR THE RESISTANCE OF SEISMIC LOADS. DOCUMENTATION OF CAPACITY FOR ALTERNATE PRODUCTS MUST BE INCLUDED AS A DEFERRED SUBMITTAL.

STRUCTURAL STEEL

REFERENCE SPECIFICATIONS

| | |
|----------------------|--|
| STRUCTURAL STEEL | AISC 360 - SPECIFICATION FOR STRUCTURAL STEEL BUILDINGS |
| HIGH STRENGTH BOLTS | RCSC SPECIFICATION FOR STRUCTURAL JOINTS USING HIGH-STRENGTH BOLTS |
| WELDING | AWS D1.1, TYPICAL AWS D1.3 FOR STEEL DECK AND COLD-FORMED FRAMING AWS D1.8 FOR SUPPLEMENTAL SEISMIC PROVISIONS AWS PREQUALIFIED JOINT DETAILS |
| WELDER CERTIFICATION | AMERICAN WELDING SOCIETY (AWS) WASHINGTON ASSOCIATION OF BUILDING OFFICIALS (WABO) |

STEEL MATERIALS

| | |
|---------------------------------|---|
| PLATES (PL), BARS | ASTM A 36 TYPICAL, ANGLES (L), CHANNELS (C AND MC) ASTM A 36 |
| ANGLES (L), CHANNELS (C AND MC) | ASTM A 36 |
| THREADED RODS | ASTM A 36, UNLESS NOTED OTHERWISE |

STRUCTURAL STEEL DESIGN, FABRICATION AND ERECTION SHALL CONFORM TO THE REQUIREMENTS OF IBC CHAPTER 22. ALL MEMBERS ARE TO BE ERECTED WITH NATURAL MILL CAMBER OR INDUCED CAMBER UP, UNLESS OTHERWISE NOTED ON THE PLANS. SUBSTITUTION OF MEMBER SIZES OR STEEL GRADE WILL NOT BE ALLOWED WITHOUT PRIOR APPROVAL BY THE ARCHITECT. A MINIMUM OF TWO BOLTS IS REQUIRED FOR ALL BEAM CONNECTIONS. ALTERNATIVE CONNECTIONS TO THOSE SHOWN ON THESE DRAWINGS WILL REQUIRE PRIOR APPROVAL BY THE ARCHITECT.

THE CONTRACTOR SHALL BE RESPONSIBLE FOR ALL ERECTION AIDS AND JOINT PREPARATIONS THAT INCLUDE, BUT ARE NOT LIMITED TO, ERECTION ANGLES, LIFT HOLES AND OTHER AIDS, WELDING PROCEDURES, REQUIRED ROOT OPENINGS, ROOT FACE DIMENSIONS, GROOVE ANGLES, BACKING BARS, COPELS, SURFACE ROUGHNESS VALUES, AND UNEQUAL PARTS.

PROTECTION OF STEEL
STRUCTURAL STEEL AND CONNECTIONS, INCLUDING PLATES AND OTHER STEEL ITEMS EMBEDDED IN CONCRETE, WHICH ARE EXPOSED TO WEATHER AND NOT TO BE PAINTED ACCORDING TO THE ARCHITECT, SHALL BE HOT-DIPPED GALVANIZED AFTER FABRICATION IN COMPLIANCE WITH ASTM A 123. ALL FIELD WELDS ON GALVANIZED MATERIAL SHALL BE COATED WITH BRUSH APPLIED ZINC-RICH PAINT COMPLYING WITH THE SPECIFICATIONS.

STRUCTURAL STEEL AND CONNECTIONS SHALL BE FIREPROOFED WHERE REQUIRED BY THE ARCHITECT. PRIMARY AND SECONDARY STRUCTURE ARE TO BE AS DEFINED BY THE IBC. STRUCTURAL MEMBERS SHALL BE ASSUMED TO BE IN A THERMAL UNRESTRAINED CONDITION FOR THE PURPOSES OF DETERMINING FIREPROOFING THICKNESS. UL DESIGN SHALL BE IN ACCORDANCE WITH LFRD DESIGN METHODOLOGY.

WHERE SPRAY-APPLIED CEMENTITIOUS FIREPROOFING IS EXPOSED TO WEATHER, STRUCTURAL STEEL SHALL BE CONSIDERED EXPOSED TO WEATHER, AND SHALL BE PROTECTED ACCORDINGLY.

ALL COATINGS ARE TO FOLLOW THE SPECIFICATIONS AND PRODUCT MANUFACTURER'S INSTRUCTIONS.

WELDING
ALL WELDING SHALL BE IN CONFORMANCE WITH AISC AND AWS STANDARDS, AND SHALL BE PERFORMED BY AWS-WABO-CERTIFIED WELDERS. ONLY WELDS THAT ARE PREQUALIFIED, AS DEFINED BY AWS, OR QUALIFIED BY TESTING SHALL BE USED. SHOP DRAWINGS SHALL SHOW ALL WELDING WITH AWS A2.4 SYMBOLS. WELDS SHOWN ON THE DRAWINGS ARE MINIMUM SIZES. INCREASE WELD SIZE TO AWS MINIMUM SIZES BASED ON THICKNESS. MINIMUM WELD SIZE SHALL BE 3/16-INCH, UNLESS NOTED OTHERWISE. THE WELDS SHOWN ARE FOR THE FINAL CONNECTIONS. FIELD WELD SYMBOLS ARE SHOWN WHERE FIELD WELDS ARE REQUIRED BY THE STRUCTURAL DESIGN. WHERE FIELD WELD IS NOT INDICATED, THE CONTRACTOR IS RESPONSIBLE FOR DETERMINING IF A WELD SHOULD BE SHOP OR FIELD-WELDED IN ORDER TO FACILITATE THE STRUCTURAL STEEL ERECTION.

STATEMENT OF STRUCTURAL SPECIAL INSPECTIONS AND TESTING

TABLE 2 - REQUIRED STRUCTURAL SPECIAL INSPECTIONS

| SYSTEM OR MATERIAL | INSPECTION | | | | REMARKS | | |
|---|--------------------|--|--------------------|---------------------------------------|---|-------------------------------------|---|
| | IBC CODE REFERENCE | CODE OR STANDARD REFERENCE | FREQUENCY (NOTE 6) | | | | |
| CONCRETE | | | | | | | |
| INSPECT ANCHORS POST-INSTALLED IN HARDENED CONCRETE MEMBERS: | | | | | | | |
| ADHESIVE ANCHORS AND ADHESIVE REINFORCING DOWELS INSTALLED IN HORIZONTAL OR UPWARDLY INCLINED ORIENTATIONS TO RESIST SUSTAINED TENSION LOADS. | TB 1705.3 (4.a) | ACI 355.4 ICC/IAPMO EVALUATION REPORT ACI 318: 17.8.2.4, 26.13.3 | X | - | REFER TO ANCHOR CALLOUTS FOR SUSTAINED TENSION (ST) DESIGNATION | | |
| MECHANICAL ANCHORS, ADHESIVE ANCHORS, AND ADHESIVE REINFORCING DOWELS NOT DEFINED ABOVE. | TB 1705.3 (4.b) | ACI 355.4 ICC/IAPMO EVALUATION REPORT ACI 318: 17.8.2, 26.13.3 | - | X (NOTE 7) | ALL ANCHORS SHALL BE VISUALLY INSPECTED | | |
| MASONRY - LEVEL B | | | | | | | |
| VERIFY DURING CONSTRUCTION: | | | | | | | |
| SIZE AND LOCATION OF STRUCTURAL ELEMENTS | 1705.4 | TMS 602: TB 4(4.a) TMS 602: 3.3 F | - | X | - | | |
| TYPE, SIZE, AND LOCATION OF ANCHORS, INCLUDING OTHER DETAILS OF ANCHORAGE OF MASONRY TO STRUCTURAL MEMBERS, FRAMES, OR OTHER CONSTRUCTION | | TMS 602: TB 4(4.b) TMS 402: 1.2.1(e), 6.1.4.3, 6.2.1 | - | X | - | | |
| PLACEMENT OF GROUT IS IN COMPLIANCE | 1705.4 | TMS 602: TB 4(4.f) TMS 602: 3.5 | X | - | - | | |
| OBSERVE PREPARATION OF GROUT SPECIMENS, MORTAR SPECIMENS, AND/OR PRISMS | 1705.4 | TMS 602: TB 4(5) TMS 602: 1.4 B | - | X | - | | |
| STEEL | | | | | | | |
| INSPECTION TASKS PRIOR TO WELDING: | | | | | | | |
| WELDING PROCEDURE SPECIFICATIONS (WPS) AVAILABLE | 1705.2 | AISC 360: TB N5.4-1 AISC 360: N5.4 | - | X | - | | |
| MANUFACTURER CERTIFICATIONS FOR WELDING CONSUMABLES AVAILABLE | | | - | X | - | | |
| MATERIAL IDENTIFICATION (TYPE/GRADE) | | | X | - | - | | |
| WELDER IDENTIFICATION SYSTEM | | | X | - | - | | |
| FIT-UP OF GROOVE WELDS (INCLUDING JOINT GEOMETRY): JOINT PREPARATION, DIMENSIONS (ALIGNMENT, ROOT OPENING, ROOT FACE, BEVEL), CLEANLINESS (CONDITION OF STEEL SURFACES), TACKING (TACK WELD QUALITY AND LOCATION), BACKING TYPE AND FIT (IF APPLICABLE) | | | X | - | - | | |
| CONFIGURATION AND FINISH OF ACCESS HOLES | | | X | - | - | | |
| FIT-UP OF FILLET WELDS: DIMENSIONS (ALIGNMENT, GAPS AT ROOT), CLEANLINESS (CONDITION OF STEEL SURFACES), TACKING (TACK WELD QUALITY AND LOCATION), BACKING TYPE AND FIT (IF APPLICABLE) | | | X | - | - | | |
| CHECK WELDING EQUIPMENT | | | - | - | - | FABRICATOR OR ERECTOR SHALL OBSERVE | |
| INSPECTION TASKS DURING WELDING: | | | | | | | |
| USE OF QUALIFIED WELDERS | | | 1705.2 | AISC 360: TB N5.4-2 AISC 360: N5.4 | X | - | - |
| CONTROL AND HANDLING OF WELDING CONSUMABLES: PACKAGING, EXPOSURE CONTROL | X | - | | | - | | |
| NO WELDING OVER CRACKED TACK WELDS | X | - | | | - | | |
| ENVIRONMENTAL CONDITIONS: WIND SPEED WITHIN LIMITS, PRECIPITATION AND TEMPERATURE | X | - | | | - | | |
| WPS FOLLOWED: SETTINGS ON WELDING EQUIPMENT, TRAVEL SPEED, SELECTED WELDING MATERIALS, SHIELDING GAS TYPE/FLOW RATE, PREHEAT APPLIED, INTERPASS TEMPERATURE MAINTAINED (MIN./MAX.), PROPER POSITION (F, V, H, OH) | X | - | | | - | | |
| WELDING TECHNIQUES: INTERPASS AND FINAL CLEANING, EACH PASS WITHIN PROFILE LIMITATIONS, EACH PASS MEETS QUALITY REQUIREMENTS | X | - | - | - | | | |
| INSPECTION TASKS AFTER WELDING: | | | | | | | |
| WELDS CLEANED | 1705.2 | AISC 360: TB N5.4-3 AISC 360: N5.4 | X | - | - | | |
| SIZE, LENGTH AND LOCATION OF WELDS | | | - | X | - | | |
| WELDS MEET VISUAL ACCEPTANCE CRITERIA: CRACK PROHIBITION, WELD/BASE-METAL FUSION, CRATER CROSS SECTION, WELD PROFILES, WELD SIZE, UNDERCUT, POROSITY | | | - | X | - | | |
| ARC STRIKES | | | - | X | - | | |
| K-AREA | | | - | X | - | | |
| BACKING REMOVED AND WELD TABS REMOVED (IF REQUIRED) | | | - | X | - | | |
| REPAIR ACTIVITIES | | | - | X | - | | |
| DOCUMENT ACCEPTANCE OR REJECTION OF WELDED JOINT OR MEMBER | | | - | X | - | | |

| INSPECTION TASKS PRIOR TO BOLTING: | | | | | |
|--|--------------------|---------------------------------------|--------------------|----------|---------------------------------------|
| SYSTEM OR MATERIAL | IBC CODE REFERENCE | CODE OR STANDARD REFERENCE | FREQUENCY (NOTE 6) | | REMARKS |
| | | | CONTINUOUS | PERIODIC | |
| MANUFACTURER'S CERTIFICATIONS AVAILABLE FOR FASTENER MATERIALS | | | - | X | - |
| FASTENERS MARKED IN ACCORDANCE WITH ASTM REQUIREMENTS | | | X | - | - |
| PROPER FASTENERS SELECTED FOR THE JOINT DETAIL (GRADE, TYPE, BOLT LENGTH IF THREADS ARE TO BE EXCLUDED FROM SHEAR PLANE) | 1705.2 | AISC 360: TB N5.6-1 AISC 360: N5.6 | X | - | - |
| PROPER BOLTING PROCEDURE FOR JOINT DETAIL | | | X | - | - |
| CONNECTING ELEMENTS, INCLUDING THE APPROPRIATE FAYING SURFACE CONDITION AND HOLE PREPARATION, IF SPECIFIED, MEET APPLICABLE REQUIREMENTS | | | X | - | - |
| PRE-INSTALLATION VERIFICATION TESTING BY INSTALLATION PERSONNEL OBSERVED AND DOCUMENTED FOR FASTENER ASSEMBLIES AND METHODS USED | | | X | - | - |
| PROPER STORAGE PROVIDED FOR BOLTS, NUTS, WASHERS AND OTHER FASTENER COMPONENTS | | | X | - | - |
| INSPECTION TASKS DURING BOLTING: | | | | | |
| FASTENER ASSEMBLIES, OF SUITABLE CONDITION, PLACED IN ALL HOLES AND WASHERS (IF REQUIRED) ARE POSITIONED AS REQUIRED | 1705.2 | AISC 360: TB N5.6-2 AISC 360: N5.6 | X | - | - |
| JOINT BROUGHT TO SNUG-TIGHT CONDITION PRIOR TO THE PRETENSIONING OPERATION | | | X | - | - |
| FASTENER COMPONENT NOT TURNED BY THE WRENCH PREVENTED FROM ROTATING | | | X | - | - |
| FASTENERS ARE PRETENSIONED IN ACCORDANCE WITH THE RCSC SPECIFICATION, PROGRESSING SYSTEMATICALLY FROM THE MOST RIGID POINT TOWARD THE FREE EDGES | | | X | - | - |
| INSPECTION TASKS AFTER BOLTING: | | | | | |
| DOCUMENT ACCEPTANCE OR REJECTION OF BOLTED CONNECTIONS | 1705.2 | AISC 360: TB N5.6-3 | - | X | - |
| INSPECTION OF FABRICATED AND ERECTED STEEL FRAMES: | | | | | |
| VERIFICATION OF COMPLIANCE WITH CONSTRUCTION DOCUMENT DETAILS, INCLUDING MEMBER AND COMPONENT LOCATIONS, BRACING, STIFFENERS, AND PROPER APPLICATION OF JOINT DETAILS. | - | AISC 360: N5.7 | - | X | - |
| STAINLESS STEEL | | | | | |
| MATERIAL VERIFICATION OF BOLTS | | | - | X | MANUFACTURER'S CERTIFIED TEST REPORTS |


STATEMENT OF SPECIAL INSPECTION AND TESTING NOTES:

- SPECIAL INSPECTIONS SHALL CONFORM TO CHAPTER 17 OF THE INTERNATIONAL BUILDING CODE (IBC) AND THE REFERENCE CODES AND STANDARDS LISTED IN NOTE 2. REFER TO TABLES 1 AND 2 FOR SPECIAL INSPECTION AND TABLES 3 AND 4 FOR TESTING REQUIREMENTS.
- REFERENCE CODES AND STANDARDS ARE AS FOLLOWS:
IBC 2015
AWS CURRENT EDITION
ASTM CURRENT EDITION
AISC 360-10
TMS 402-13, 602-13
- SPECIAL INSPECTIONS AND ASSOCIATED TESTING SHALL BE PERFORMED BY AN APPROVED QUALIFIED TESTING AND INSPECTING AGENCY MEETING THE REQUIREMENTS OF ASTM E 329 (MATERIALS), ASTM D 3740 (SOILS), ASTM C 1077 (CONCRETE), AND ASTM E 543 (NON-DESTRUCTIVE). THE TESTING AND INSPECTING AGENCY SHALL FURNISH TO THE ENGINEER A COPY OF THEIR SCOPE OF ACCREDITATION. SPECIAL INSPECTORS SHALL BE CERTIFIED BY THE BUILDING OFFICIAL. WELDING INSPECTORS SHALL BE QUALIFIED PER SECTION 6.1.4.1.1 OF AWS D1.1 AND WABO.
- THE SPECIAL INSPECTOR SHALL OBSERVE THE INDICATED WORK FOR COMPLIANCE WITH THE APPROVED CONSTRUCTION DOCUMENTS. ALL DISCREPANCIES SHALL BE BROUGHT TO THE ATTENTION OF THE CONTRACTOR FOR CORRECTION AND NOTED IN THE INSPECTION REPORTS. ISSUES REQUIRING IMMEDIATE CORRECTIVE ACTIONS OR ENGINEERING INPUT ARE TO BE BROUGHT TO THE ENGINEER'S ATTENTION IMMEDIATELY UPON DISCOVERY.
- THE SPECIAL INSPECTOR SHALL FURNISH INSPECTION REPORTS FOR EACH INSPECTION TO THE BUILDING OFFICIAL, ENGINEER, CONTRACTOR, AND OWNER. THE TESTING AND INSPECTING AGENCY SHALL SUBMIT A FINAL REPORT STATING THAT THE WORK REQUIRING SPECIAL INSPECTION WAS INSPECTED AND IS IN CONFORMANCE WITH THE APPROVED CONSTRUCTION DOCUMENTS AND THAT ALL DISCREPANCIES NOTED IN THE INSPECTION REPORTS HAVE BEEN CORRECTED.
- CONTINUOUS SPECIAL INSPECTION: SPECIAL INSPECTION BY THE SPECIAL INSPECTOR WHO IS PRESENT WHEN AND WHERE THE WORK TO BE INSPECTED IS BEING PERFORMED. PERIODIC SPECIAL INSPECTION: SPECIAL INSPECTION BY THE SPECIAL INSPECTOR WHO IS INTERMITTENTLY PRESENT WHERE THE WORK TO BE INSPECTED HAS BEEN OR IS BEING PERFORMED.
- WHERE PERIODIC INSPECTION IS ALLOWED IN ACCORDANCE WITH THE ANCHOR ICC/IAPMO EVALUATION REPORT, INSPECTIONS SHALL BE AS FOLLOWS:
- FOR ALL ANCHORS, PRIOR TO CONCEALMENT, VERIFY: ANCHOR TYPE, ANCHOR DIMENSIONS, ANCHOR SPACING AND EDGE DISTANCE.
- FOR EACH ANCHOR TYPE AND SIZE, INSPECTOR SHALL BE ON SITE TO CONTINUOUSLY INSPECT A MINIMUM OF THE FIRST 10 ANCHORS INSTALLED BY EACH INSTALLER FOR CONFORMANCE WITH ICC/IAPMO EVALUATION REPORT. PROVIDED ALL ANCHORS ARE INSTALLED CORRECTLY PER MANUFACTURER'S INSTRUCTIONS, PROVIDE PERIODIC INSPECTION ON A MINIMUM OF 10% OF THE NEXT 1000 ANCHORS BY EACH INSTALLER AND A MINIMUM OF 5% OF THE REMAINING ANCHORS BY EACH INSTALLER. INSPECTIONS SHALL OCCUR A MINIMUM OF ONCE PER WEEK AT A RANDOM TIME WHILE ANCHOR INSTALLATION IS ONGOING. ANY NON-COMPLIANCE ISSUES SHALL RESET THE INSPECTION REQUIREMENTS TO TEN (10) CONTINUOUS INSPECTIONS. NON-COMPLIANT ANCHORS SHALL BE BROUGHT TO THE ATTENTION OF THE ENGINEER OF RECORD FOR REVIEW AND SHALL BE BROUGHT INTO COMPLIANCE BY EITHER TESTING OR RE-INSTALLATION.
- INSPECTION REPORTS SHALL IDENTIFY NAMES OF INSTALLERS.
- SPECIAL INSPECTOR SHALL PROVIDE DOCUMENTATION AT THE END OF ANCHOR INSTALLATIONS STATING THAT THE MINIMUM NUMBER OF ANCHORS WERE INSPECTED.
- OBSERVE: OBSERVE THESE ITEMS ON A RANDOM BASIS. OPERATIONS NEED NOT BE DELAYED PENDING THESE INSPECTIONS. PERFORM: PERFORM THESE TASKS FOR EACH ELEMENT.
- INDICATED CONCRETE TESTING MEETS MINIMUM REQUIREMENTS FOR STRUCTURAL TESTING TO BE PROVIDED BY THE APPROVED QUALIFIED TESTING AND INSPECTING AGENCY. ADDITIONAL TESTING FOR CONSTRUCTION CONSIDERATIONS ARE NOT INDICATED AND SHALL BE DETERMINED BY THE CONTRACTOR AND PROVIDED AT CONTRACTOR'S EXPENSE.

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THE COLONIAL
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REPAIRS

PERMIT SET

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Drawn by: _____

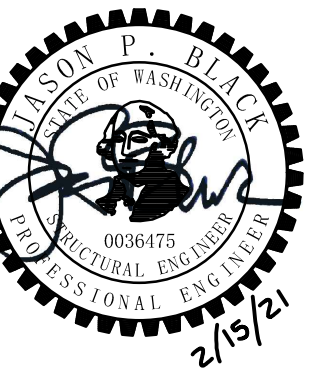Checked: _____

Date: 2/16/2021

Scale: _____

Revisions: _____

No. Date Remarks

NOT FOR CONSTRUCTION

STATEMENT OF
SPECIAL
INSPECTIONS
(IBC 2015)

S0.1

DCI APPROVAL STAMPS

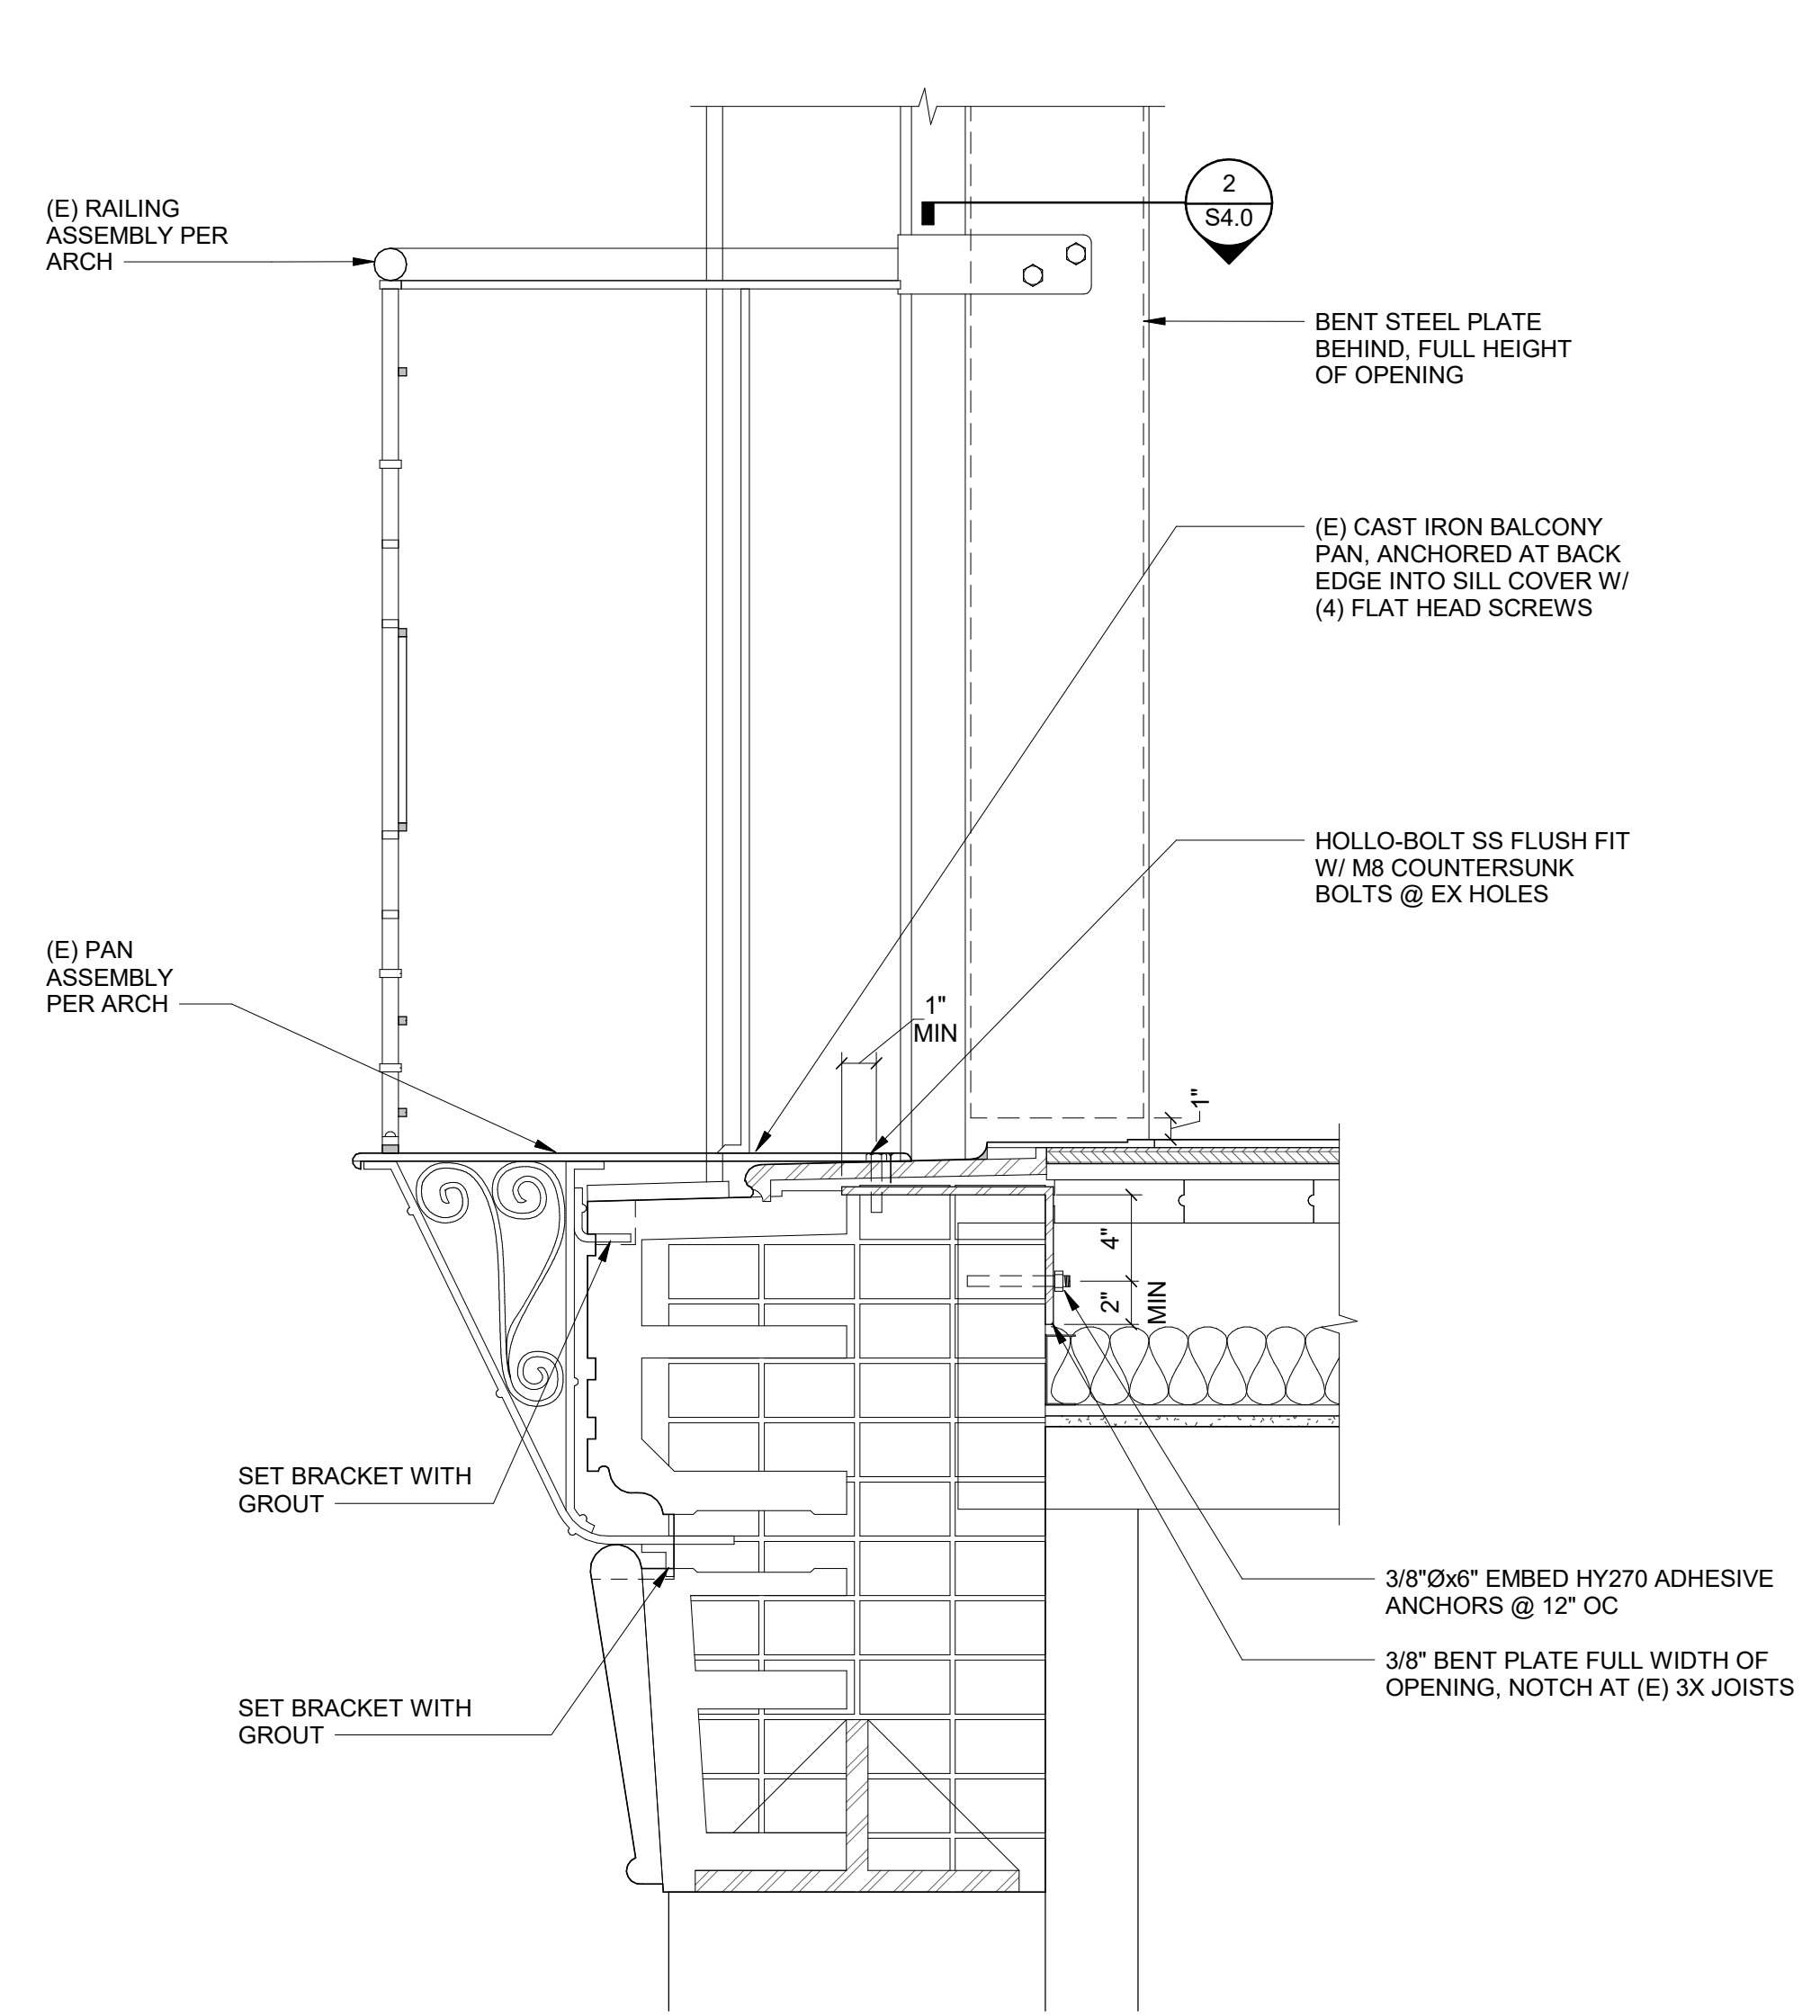


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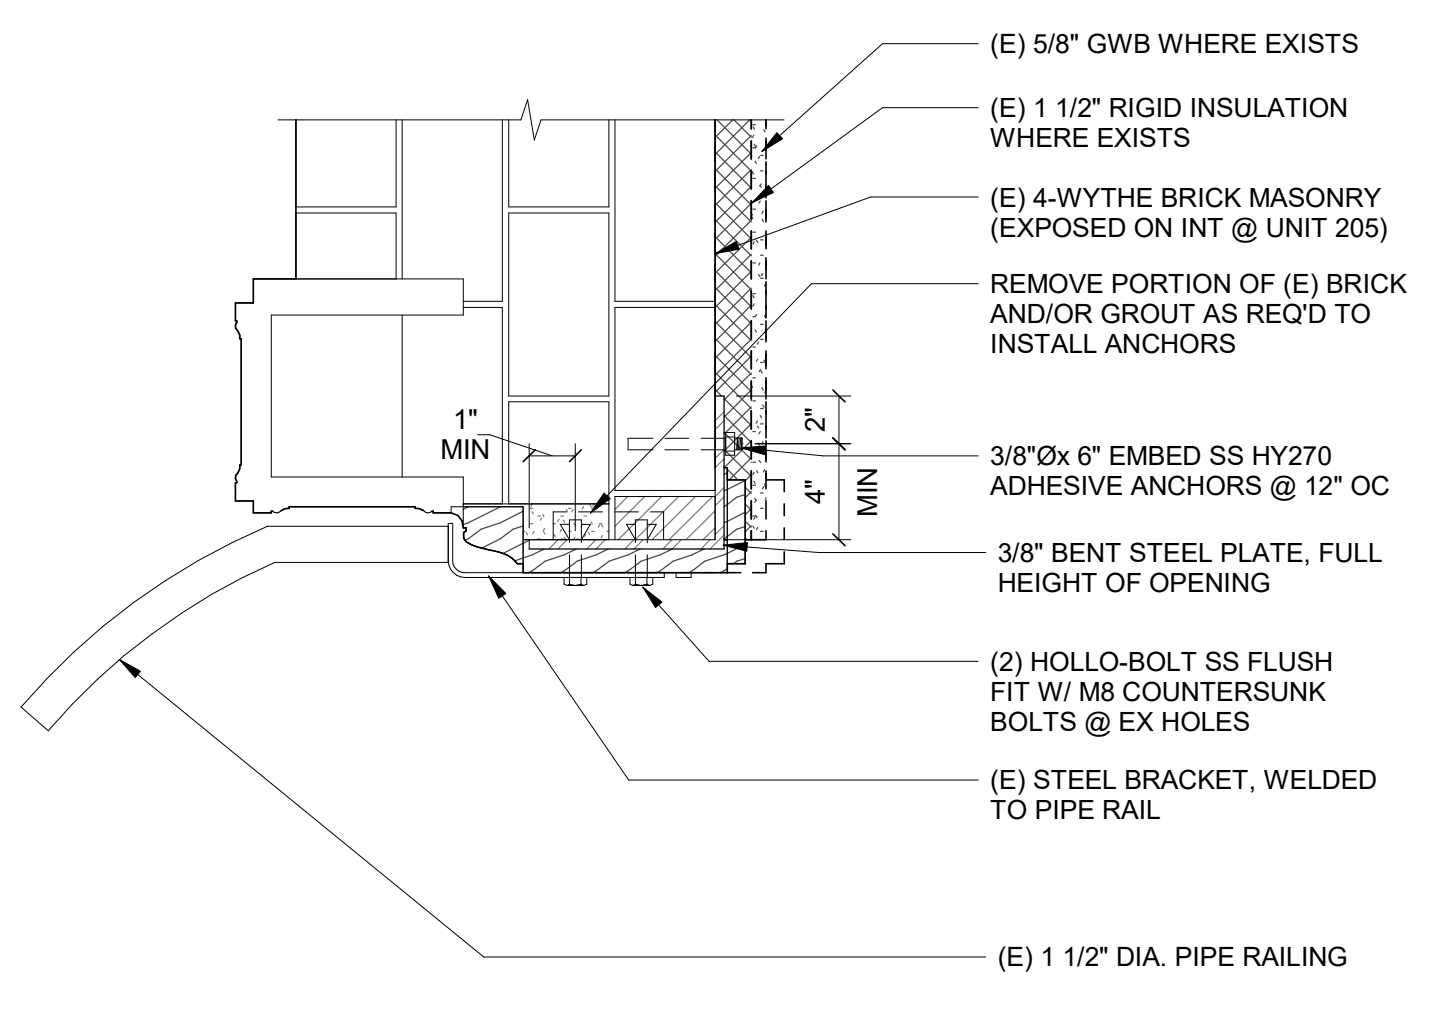
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No. Date Remarks

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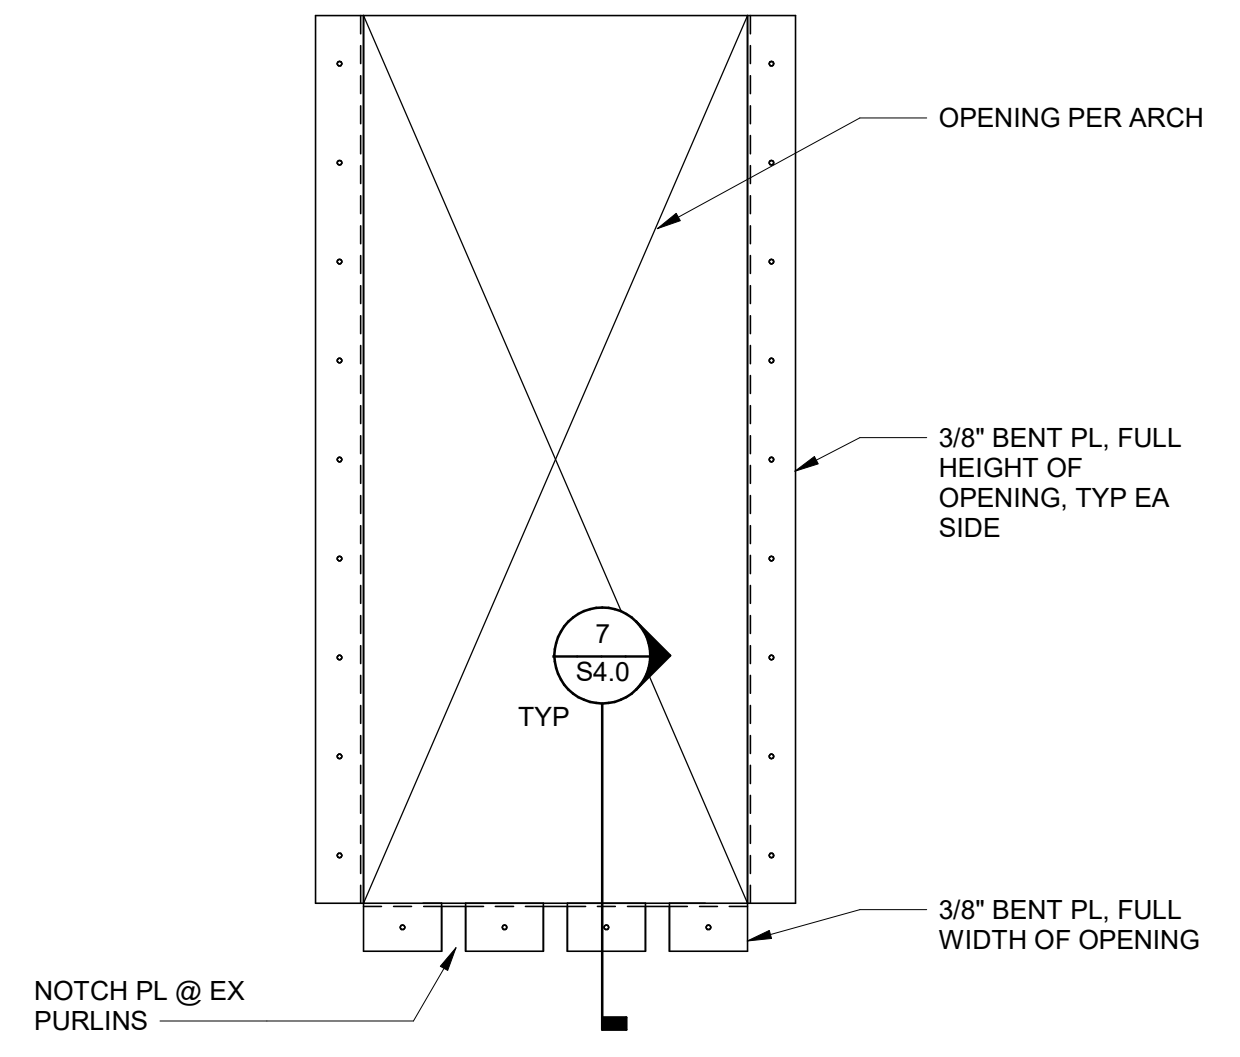
BALCONY
DETAILS
S4.0



7 BALCONY TYPE 1A SECTION
1 1/2" = 1'-0"



2 JAMB DETAIL
1 1/2" = 1'-0"



1 BALCONY TYPE 1A ELEVATION
NO SCALE

DCI APPROVAL STAMPS



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GRAND PACIFIC

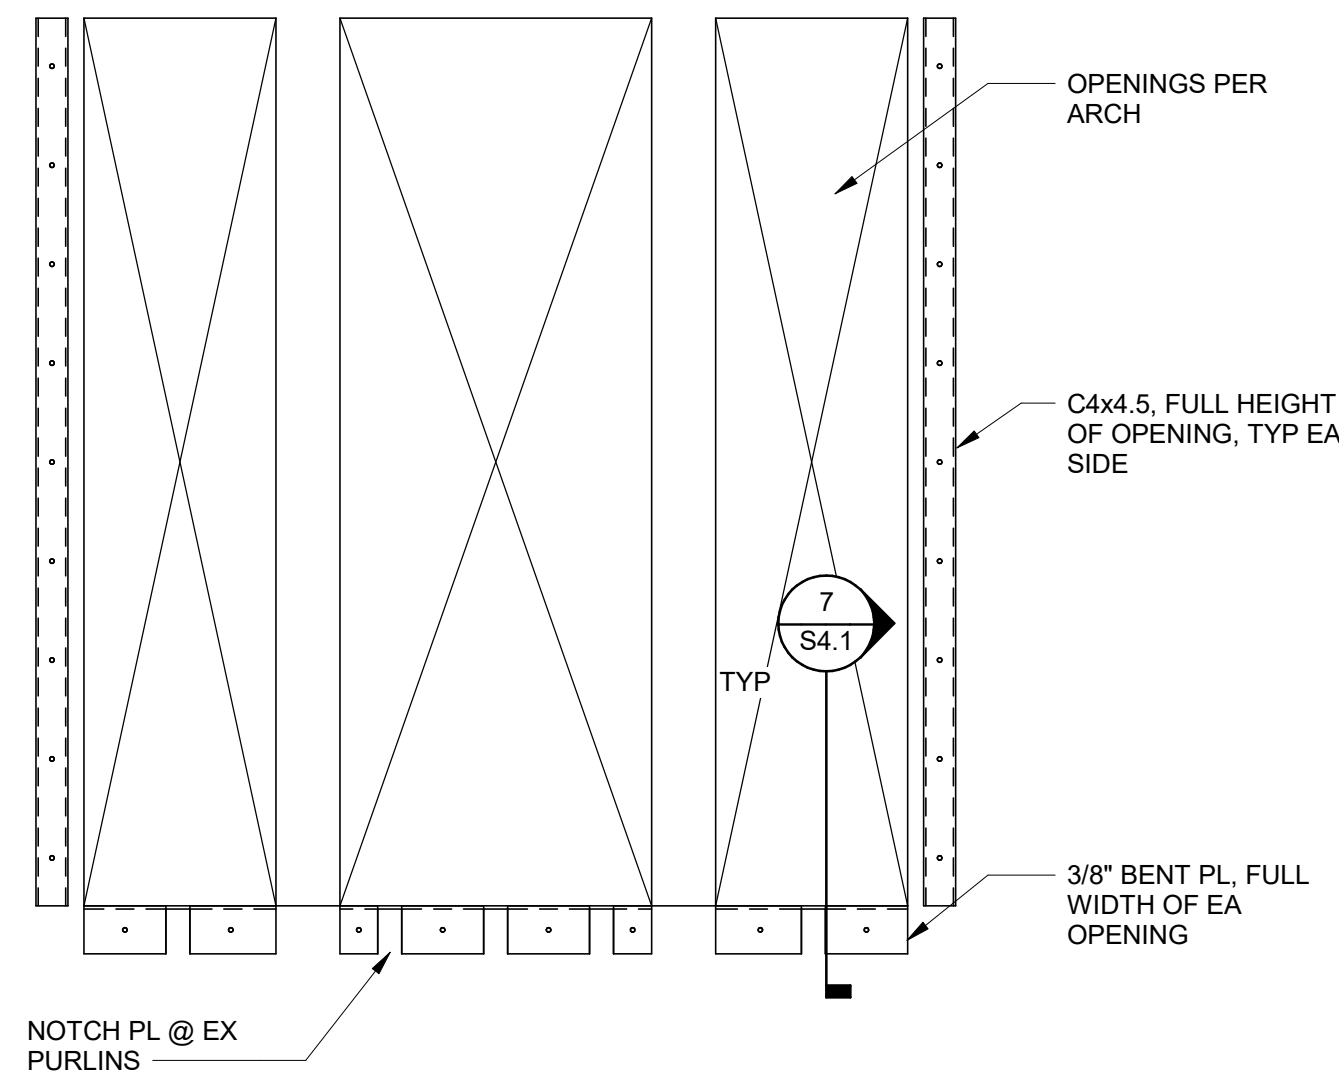
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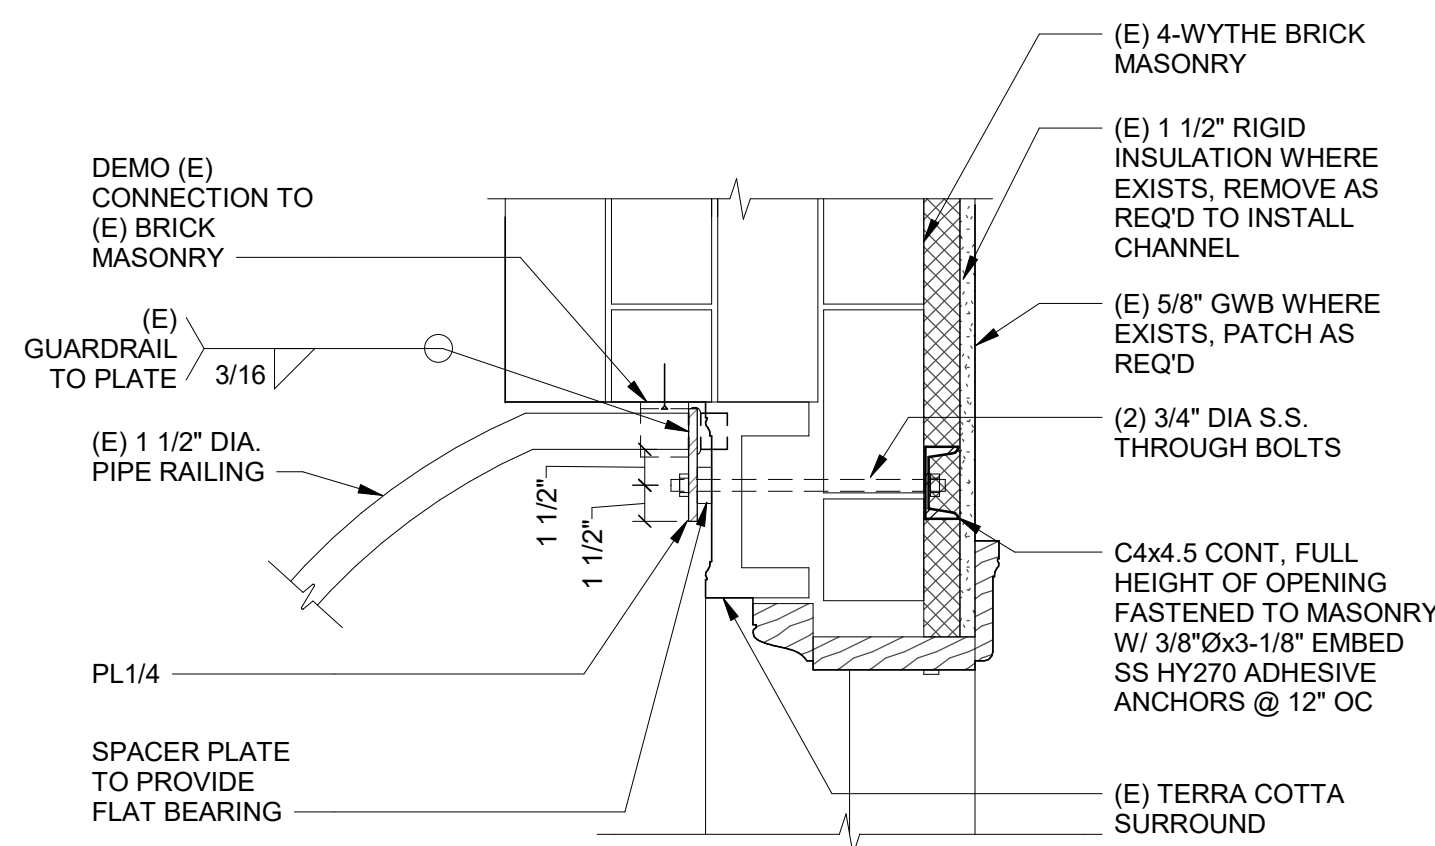
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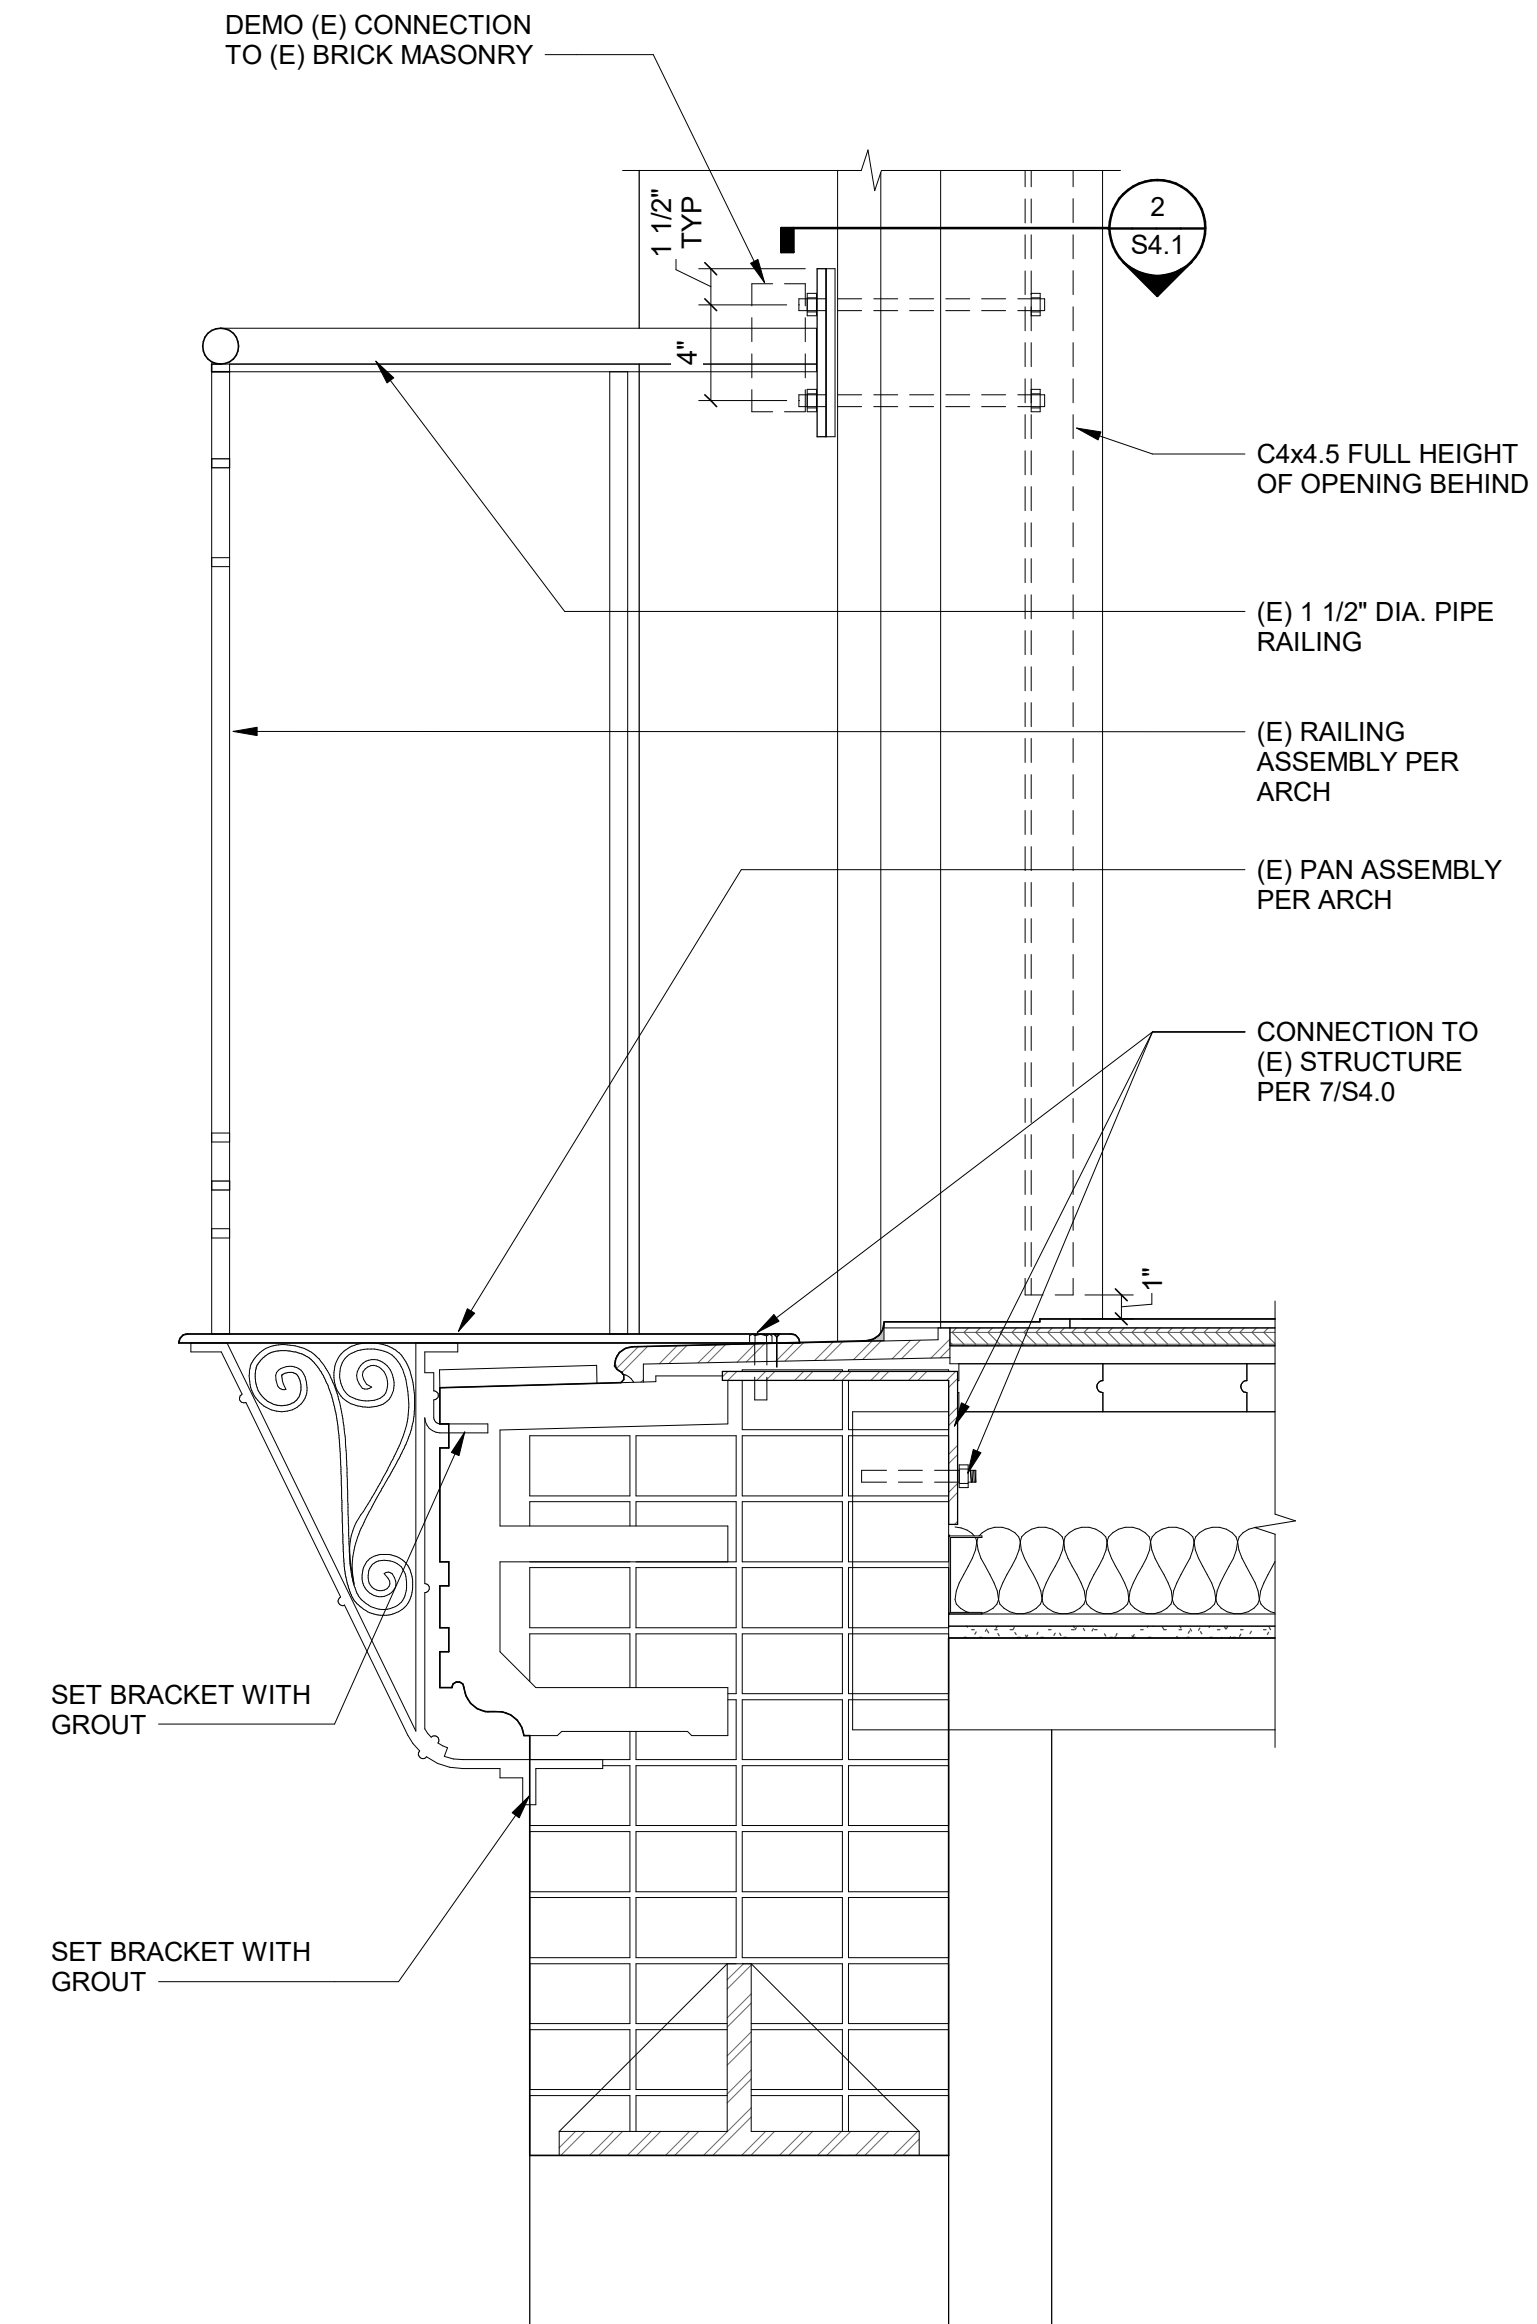
Revisions:
No. Date Remarks



1 BALCONY TYPE 2A ELEVATION
NO SCALE



2 JAMB DETAIL
1 1/2" = 1'-0"





7 BALCONY TYPE 2A SECTION
1 1/2" = 1'-0"


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NOT FOR CONSTRUCTION

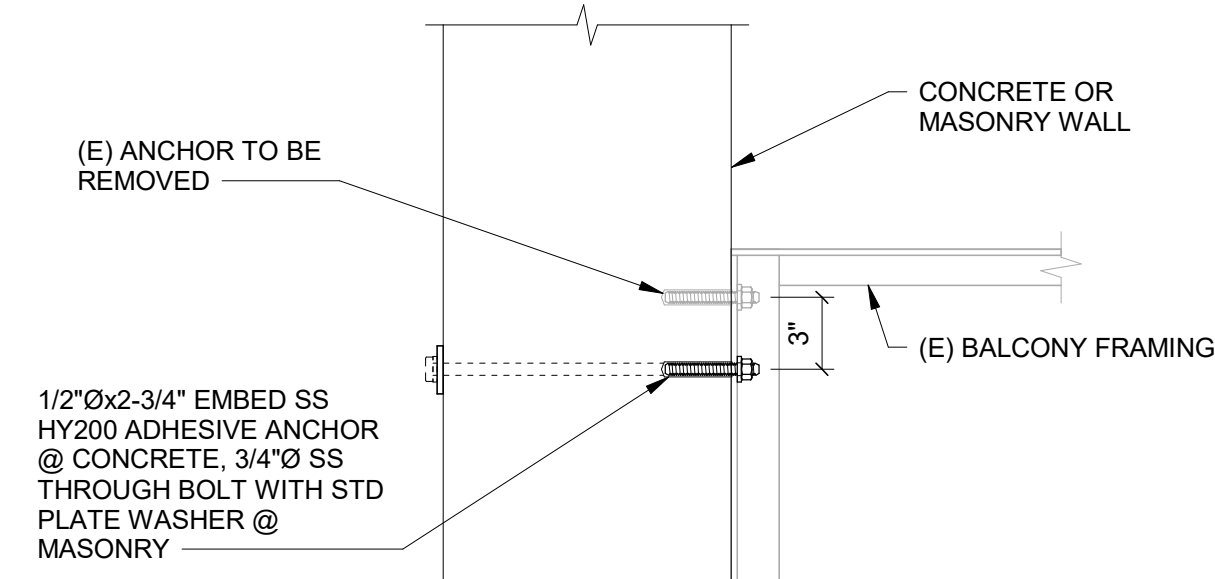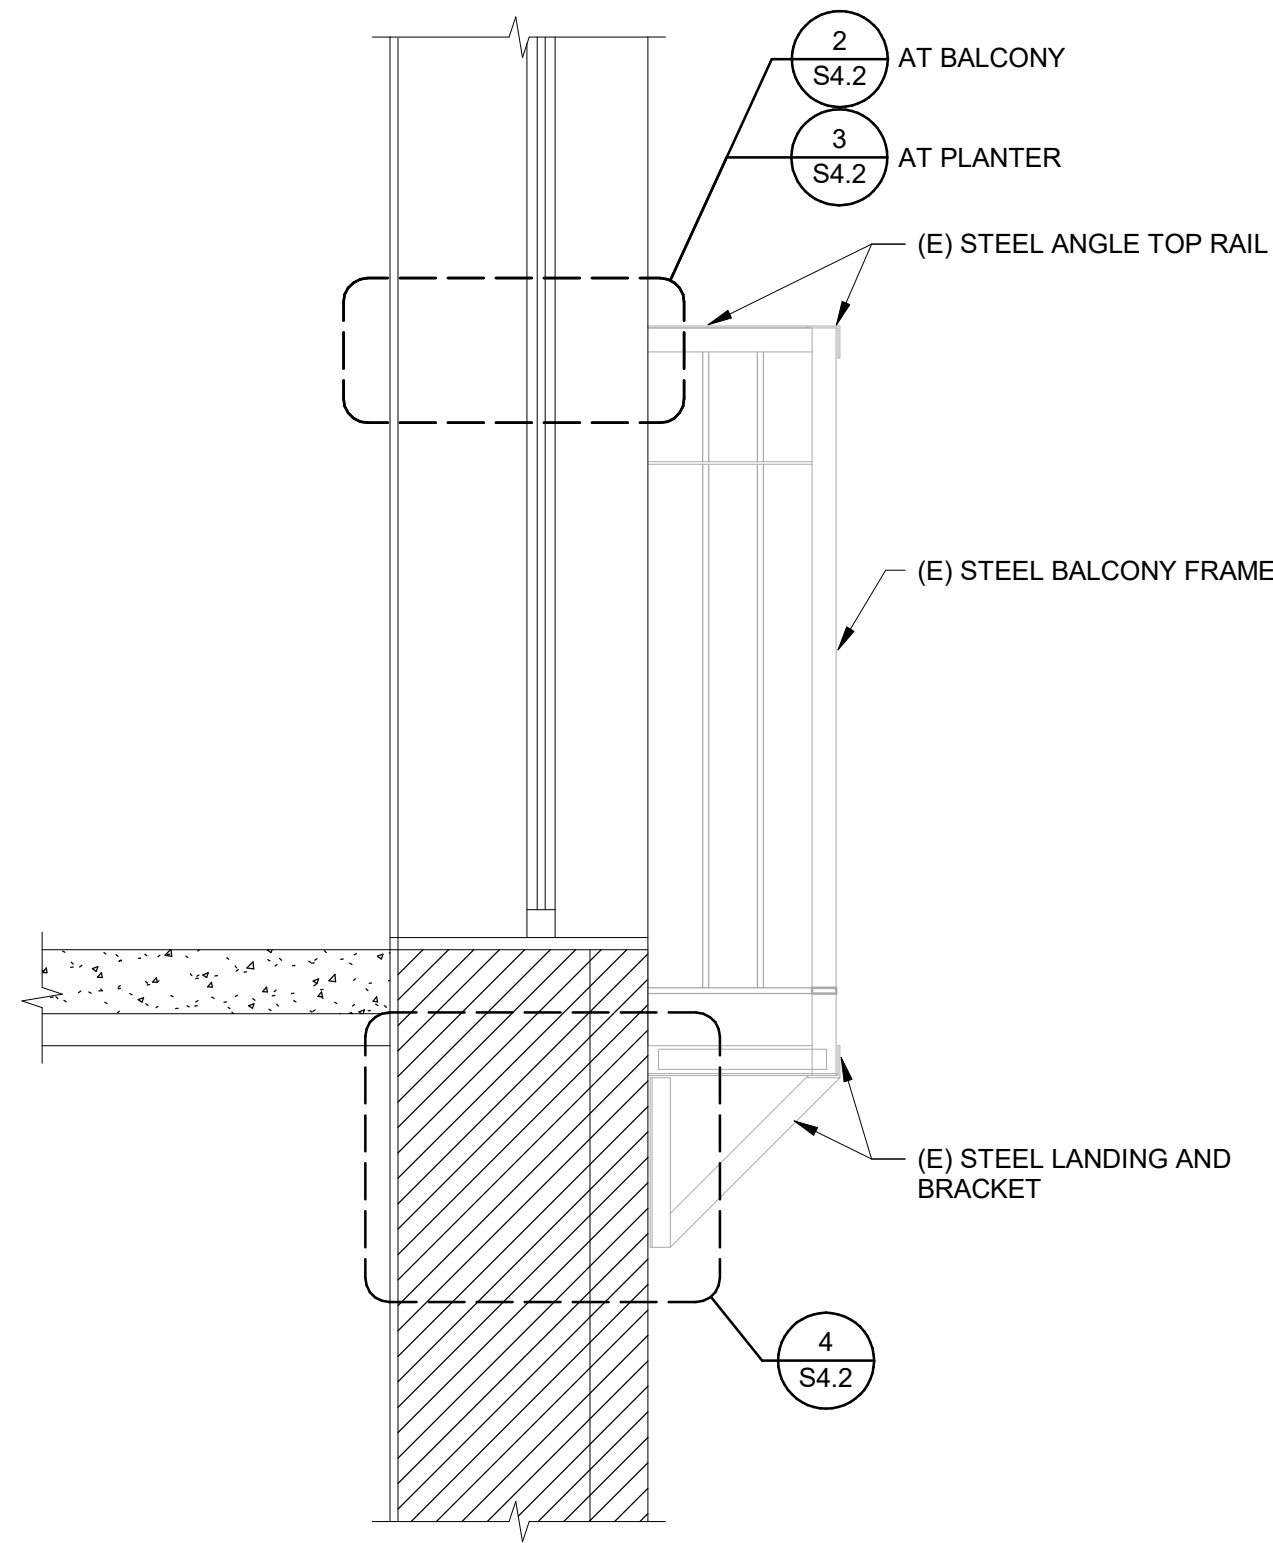
BALCONY
DETAILS
S4.1



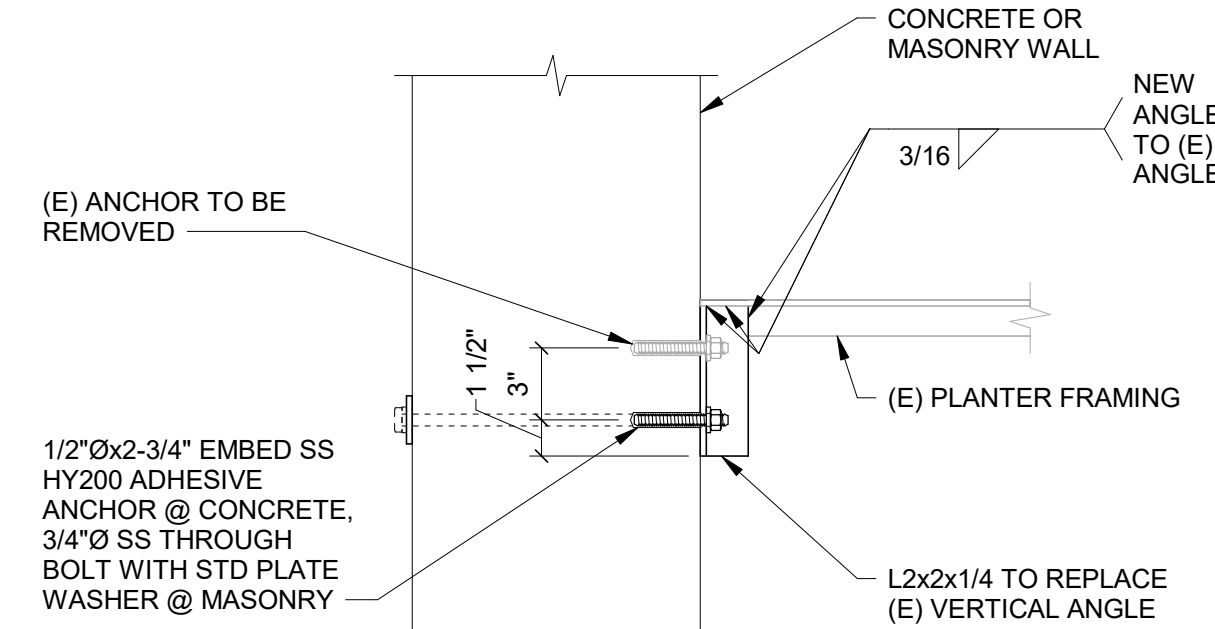2 TOP RAIL CONN AT CONT ANGLE
1 1/2" = 1'-0"



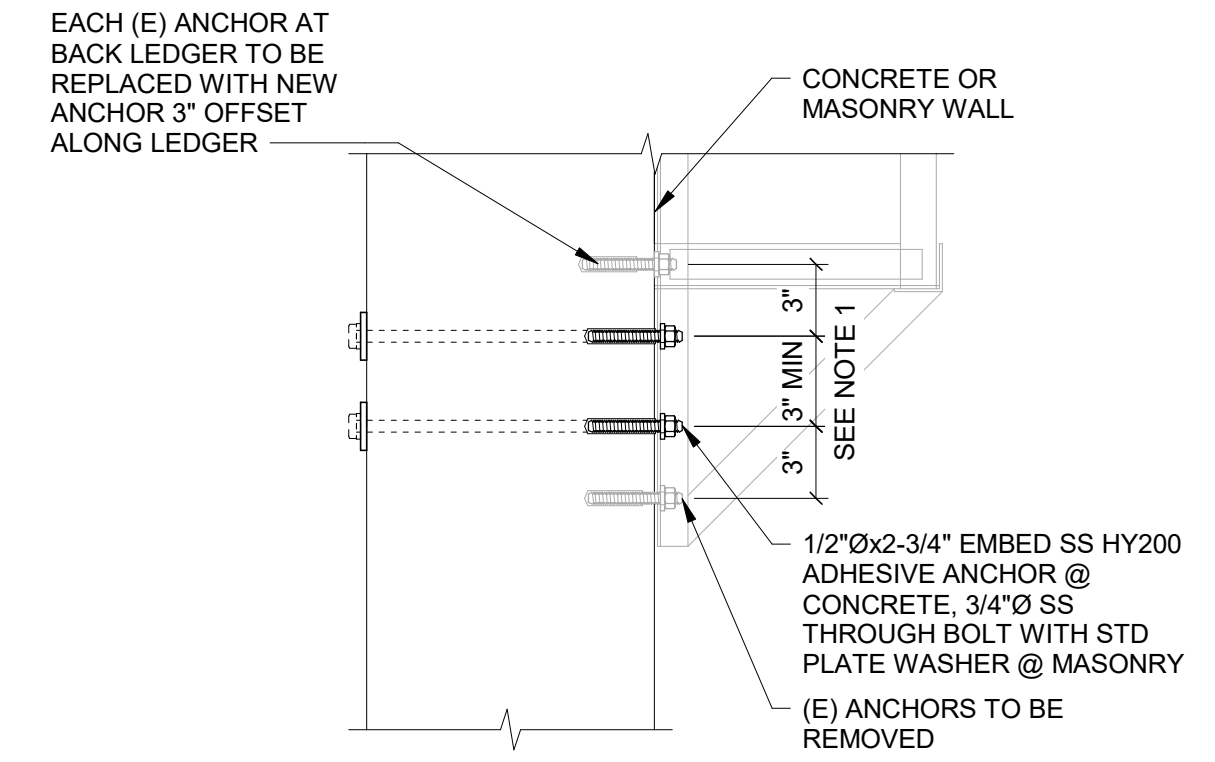3 TOP RAIL CONN AT STUB ANGLE
1 1/2" = 1'-0"




NOTES:
1. IF SPACE UNDERNEATH LANDING NOT AVAILABLE, TOPMOST ANCHOR MAY BE PLACED 3" ABOVE EXISTING ANCHOR LOCATION INSTEAD.

4 BALCONY LANDING CONN
1 1/2" = 1'-0"

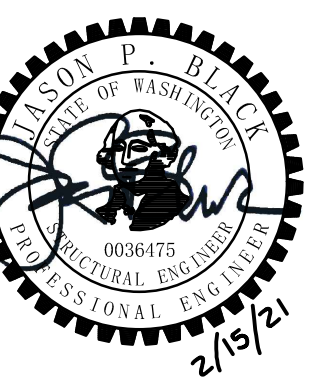5 BALCONY TYPE 3 AND 4 SECTION
1" = 1'-0"

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BALCONY
DETAILS
S4.2