66 Bell Street, Unit #1 Seattle, WA 98121 206,239,0850

Building 18 Project Narrative – Early Design Guidance Briefing

Outdoors for All HQ

Submittal Date April 01, 2021 SPARC Briefing April 13, 2021

Owner Seattle Parks & Recreation

Brian Judd

brian.judd@seattle.gov

Kevin Bergsrud

kevin.bergsrud@seattle.gov

Tenant Outdoors for All Foundation

Connor Inslee

connori@outdoorsforall.org

Site Address 6305 NE 74th Street

Seattle, WA 98115

Architect The Brandt Design Group

Colin Brandt, Architect Kate Miller, Architect 860.391.1008 (cell)

kate@brandtdesigninc.com

The scope of this project includes historic rehabilitation and tenant improvement of Building 18 and the surrounding site at Magnuson Park in Seattle, WA. The existing two-story building is the abandoned fire station located within the Sand Point Naval Air Station Landmark District that is proposed to be converted to the new headquarters for the Outdoors for All Foundation. Improvements include the following, please refer to the submitted drawings, photos and survey for supporting documentation:

- New concrete and asphalt paving as required at the exterior to improve drainage and code compliant accessible pathways around the full building perimeter.
- A new trash enclosure per SDCI and SPU requirements.
- Re-striped parking stalls including (2) accessible stalls as required per code.
- Removal of one tree, (2) new trees and addition of various low-maintenance plantings.
- A new building entry and code compliant vestibule at the south side of the building including a new canopy.
- Updates to interior space for indoor sports and recreation training on the main level with support spaces and offices on the upper level.
- A new elevator and secondary stair to support egress requirements and code compliant accessible access to the upper level.

- New, code compliant restrooms to support the proposed use for the interior spaces.
- A new roof deck adjacent to the proposed Break Room with planters, existing roof structure to be upgraded due to additional loading.
- New exterior doors and windows throughout with exception to one rehabilitated garage door. A window survey has been completed and the recommendation is to replace all original windows with 'in kind' units.
- New storefront entrances at the south side of the building.
- Remove existing, non-historic, small, east-end addition and replace with new addition in the same location with additional footprint as well as additional height, new siding, window and door.
- A full seismic retrofit to meet new code requirements including concrete shear walls at the Electrical Room and the existing hose tower (now labeled Unconditioned Storage) as well as two brace frames at the main level. The first is located adjacent to the garage door in Exercise Room 5 and the second is located in the Corridor / Gallery.
- New plumbing, mechanical and electrical throughout. New exterior lighting and louvers are shown on the exterior elevations and rooftop mechanical equipment is shown on the roof plan as well as in exterior elevations.

2

- Inspection and repair as needed of all existing exterior masonry.

Printed on 4/1/2021

Proposed Rehabilitation of Building 18

6305 NE 74th St, Seattle 98115 A Project of Outdoors for All

Owner: Seattle Parks and Recreation

SPARC Briefing | April 13, 2021

- Building 18 (Firehouse & Garage) is a contributing resource to the Sand Point Naval Air Station Landmark District.
- Built in 1936 (original one-story building), with additions in 1942 and 1952.
- Scope of application is for exterior, site work, and landscaping. Landmarks Preservation Board does not have purview over the building interior unless interior work affects exterior appearance.





Ca. 1936






Ca. 1945

Ca. 1945



West facade, looking east

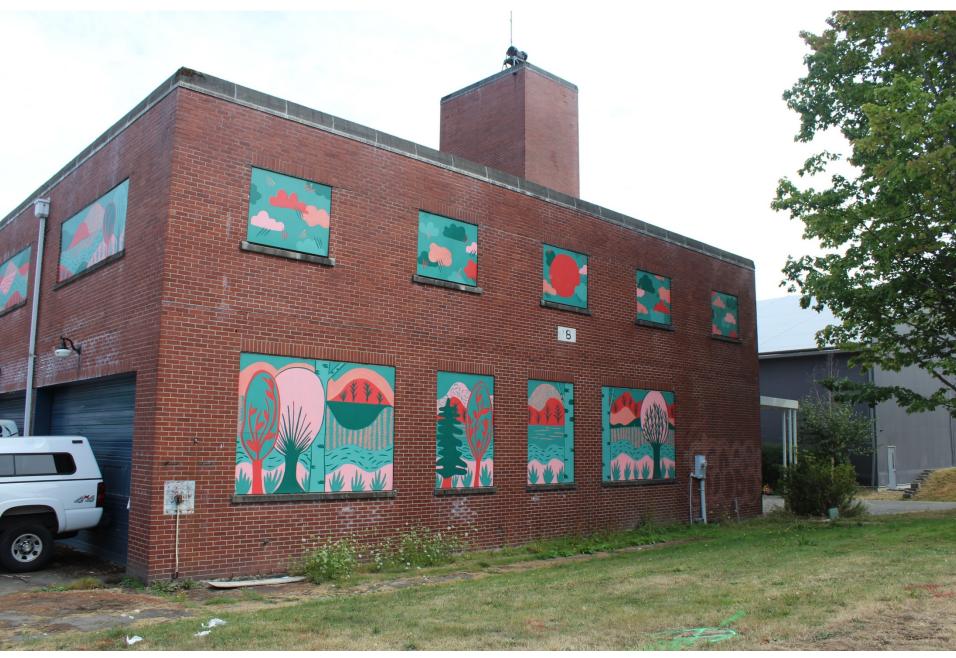

West facade and partial north facade, looking southeast



North facade, looking southeast



North facade, looking southeast. Non-historic garage doors.



Partial north facade, looking south. 1952 one-story addition partially visible (garage door to be repaired/restored).




East facade, looking southwest. Non-historic small addition (ca. 1950s) to be removed and replaced by new addition.



South and east facades, looking northwest. Non-historic small addition (ca. 1950s) on far right to be removed and replaced by new addition.



South facade, looking northeast.

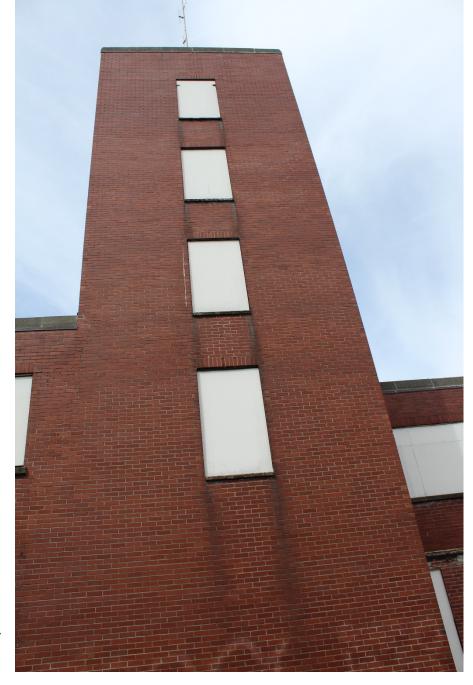

South facade of hose tower



Partial west facade and south facade with southwest corner entrance and portico, looking northeast.



Partial west facade with view of southwest corner entrance and portico, looking east.










Interior views, first floor









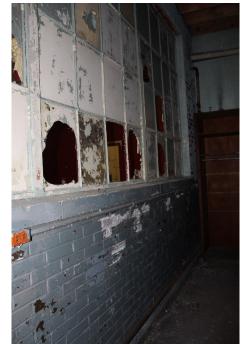









Interior views, second floor



Building 18 ca. 2014

Photographs by Outdoors for All



Building 18 in 2009

Photographs by Artifacts Consulting, Inc.

From National Register Historic District nomination and Landmark District nomination reports



West facade, looking southeast



West facade and south facades, looking east



North and west facades, looking southeast



North facade, looking southwest



North facade, looking southwest



North facade, looking south, with 1952 one-story addition



South and east facades, looking northwest (this view from this vantage point no longer exists due to construction of tennis center south of Building 18). Small onestory structure on south side removed after 2010.



South and east facades, looking northwest.
Small one-story portion of building on south side has since been removed.




Recessed south entrance (portion of building on right and canopy have since been removed).



South facade, looking north (view no longer exists from this vantage point)




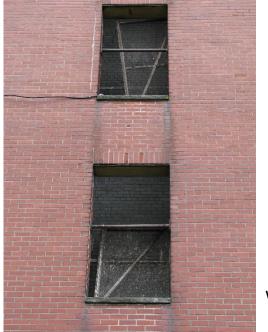

West and south facades, looking northeast



Southwest entrance and portico, looking north

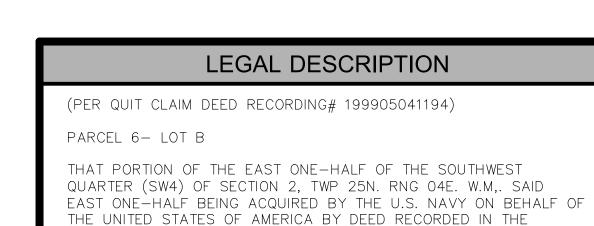

RECORDS OF KING CO.. WASHINGTON IN VOL. 1306 AT PG. 455.

DESCRIBED AS FOLLOWS:

COMMENCING AT THE WEST ONE-SIXTEENTH CORNER COMMON TO SECTIONS 2 AND 11. TWP 25N, RNG 04E, W.M., ACCEPTED AS BEING THE SAME AS THE CENTER-LINE INTERSECTION OF NE 65TH STREET AND SAND POINT WAY NE. THENCE N 00°48'49" W ON THE CENTERLINE OF SAND POINT WAY NE A DISTANCE OF 60.01 FEET, THENCE LEAVING SAID CENTERLINE S 89°35'06" E A DISTANCE OF 40.01 FEET TO A POINT ON THE EAST MARGIN OF SAID SAND POINT WAY NE, SAID POINT BEING 60.00 FEET NORTH OF THE SOUTH LINE OF SAID SECTION 2 AS MEASURED AT RIGHT ANGLES THERETO, THENCE CONTINUING S 89°35'06" E PARALLEL WITH THE SOUTH LINE OF SAID SECTION 2 A DISTANCE OF 489.94 FEET, THENCE N 00°19'00" W A DISTANCE OF 331.50 FEET, THENCE N 23°24'06" W A DISTANCE OF 323.73 FEET, THENCE N 00°01'23" W A DISTANCE OF 1211.94 FEET TO THE TRUE POINT OF BEGINNING OF THIS DESCRIPTION, THENCE CONTINUING N 00°01'23" W A DISTANCE OF 410.18 FEET, THENCE N 89°42'47" E A DISTANCE OF 796.53 FEET TO THE WEST BOUNDARY OF A TRACT OF LAND UNDER THE JURISDICTION OF THE NATIONAL OCEANIC & ATMOSPHERIC ADMINISTRATION (NOAA), THENCE S 00°02'51" W ON SAID NOAA BOUNDARY A DISTANCE OF 276.81 FEET TO A CONCRETE MONUMENT MARKING A BOUNDARY CORNER OF WARREN G MAGNUSON PARK AS ESTABLISHED IN 1975, THENCE CONTINUING S 00°02'51" W ON SAID PARK BOUNDARY A DISTANCE OF 159.18 FEET, THENCE LEAVING SAID PARK BOUNDARY S 89°44'09" W A DISTANCE OF 546.98 FEET, N 00°15'51" W A DISTANCE OF 25.49 FEET, THENCE S 89°44'09" W

BASIS OF BEARINGS

A DISTANCE OF 248.90 FEET TO THE TRUE POINT OF BEGINNING.

NAD83(2011) WASHINGTON NORTH ZONE STATE PLANE COORDINATES PER GPS OBSERVATIONS.

REFERENCES


R1. RECORD OF SURVEY, VOL. 273, PG. 91, RECORDS OF KING COUNTY, WASHINGTON.

VERTICAL DATUM

NAVD88 PER GPS OBSERVATIONS.

SURVEYOR'S NOTES

- THE TOPOGRAPHIC SURVEY SHOWN HEREON WAS PERFORMED IN SEPTEMBER OF 2020. THE FIELD DATA WAS COLLECTED AND RECORDED ON MAGNETIC MEDIA THROUGH AN ELECTRONIC THEODOLITE. THE DATA FILE IS ARCHIVED ON DISC OR CD. WRITTEN FIELD NOTES MAY NOT EXIST. CONTOURS ARE SHOWN FOR CONVENIENCE ONLY. DESIGN SHOULD RELY ON SPOT
- 2. ALL MONUMENTS SHOWN HEREON WERE LOCATED DURING THE COURSE OF THIS SURVEY UNLESS OTHERWISE NOTED.
- 3. THE TYPES AND LOCATIONS OF ANY UTILITIES SHOWN ON THIS DRAWING ARE BASED ON INFORMATION PROVIDED TO US. BY OTHERS OR GENERAL INFORMATION READILY AVAILABLE IN THE PUBLIC DOMAIN INCLUDING, AS APPLICABLE, IDENTIFYING MARKINGS PLACED BY UTILITY LOCATE SERVICES AND OBSERVED BY TERRANE IN THE FIELD. AS SUCH, THE UTILITY INFORMATION SHOWN ON THESE DRAWINGS ARE FOR INFORMATIONAL PURPOSES ONLY AND SHOULD NOT BE RELIED ON FOR DESIGN OR CONSTRUCTION PURPOSES; TERRANE IS NOT RESPONSIBLE OR LIABLE FOR THE ACCURACY OR COMPLETENESS OF THIS UTILITY INFORMATION. FOR THE ACCURATE LOCATION AND TYPE OF UTILITIES NECESSARY FOR DESIGN AND CONSTRUCTION, PLEASE CONTACT THE SITE OWNER AND THE LOCAL UTILITY LOCATE SERVICE (800-424-5555).
- 4. SUBJECT PROPERTY TAX PARCEL NO. 0225049062.
- 5. PROJECT LIMITED IN SCOPE AS DIRECTED BY THE CLIENT.
- 6. THIS SURVEY WAS PERFORMED WITHOUT THE BENEFIT OF A TITLE REPORT. EASEMENTS AND OTHER ENCUMBRANCES MAY EXIST THAT ARE NOT SHOWN HEREON.
- 7. FIELD DATA FOR THIS SURVEY WAS OBTAINED BY DIRECT FIELD MEASUREMENTS WITH A CALIBRATED ELECTRONIC 5-SECOND TOTAL STATION AND/OR SURVEY GRADE GPS OBSERVATIONS. ALL ANGULAR AND LINEAR RELATIONSHIPS ARE ACCURATE AND MEET THE STANDARDS SET BY WAC 332-130-090.

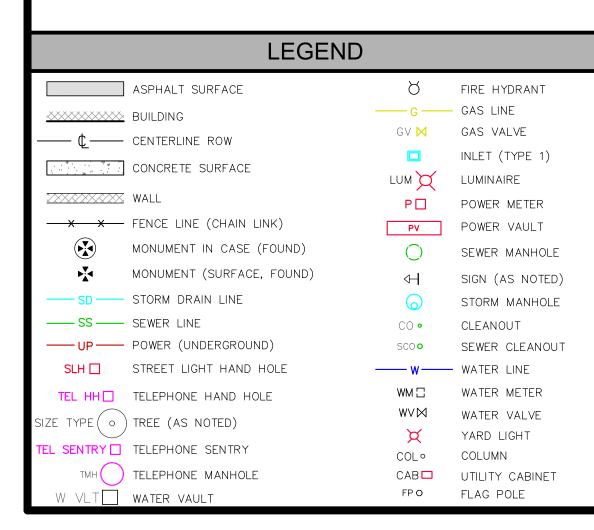

THE LIMITS AND EXTENT OF ANY STEEP SLOPES ASSOCIATED WITH ANY SETBACKS OR

OTHER DESIGN OR CONSTRUCTION PARAMETERS MUST BE DISCUSSED AND APPROVED

BY THE REVIEWING AGENCY BEFORE ANY CONSTRUCTION CAN OCCUR.

TOPOGRAPHIC & BOUNDARY SURVEY

VICINITY MAP

201391


JGM/RLS


SHEET NUMBER


1 OF 1


1" = 20'

09/17/2020

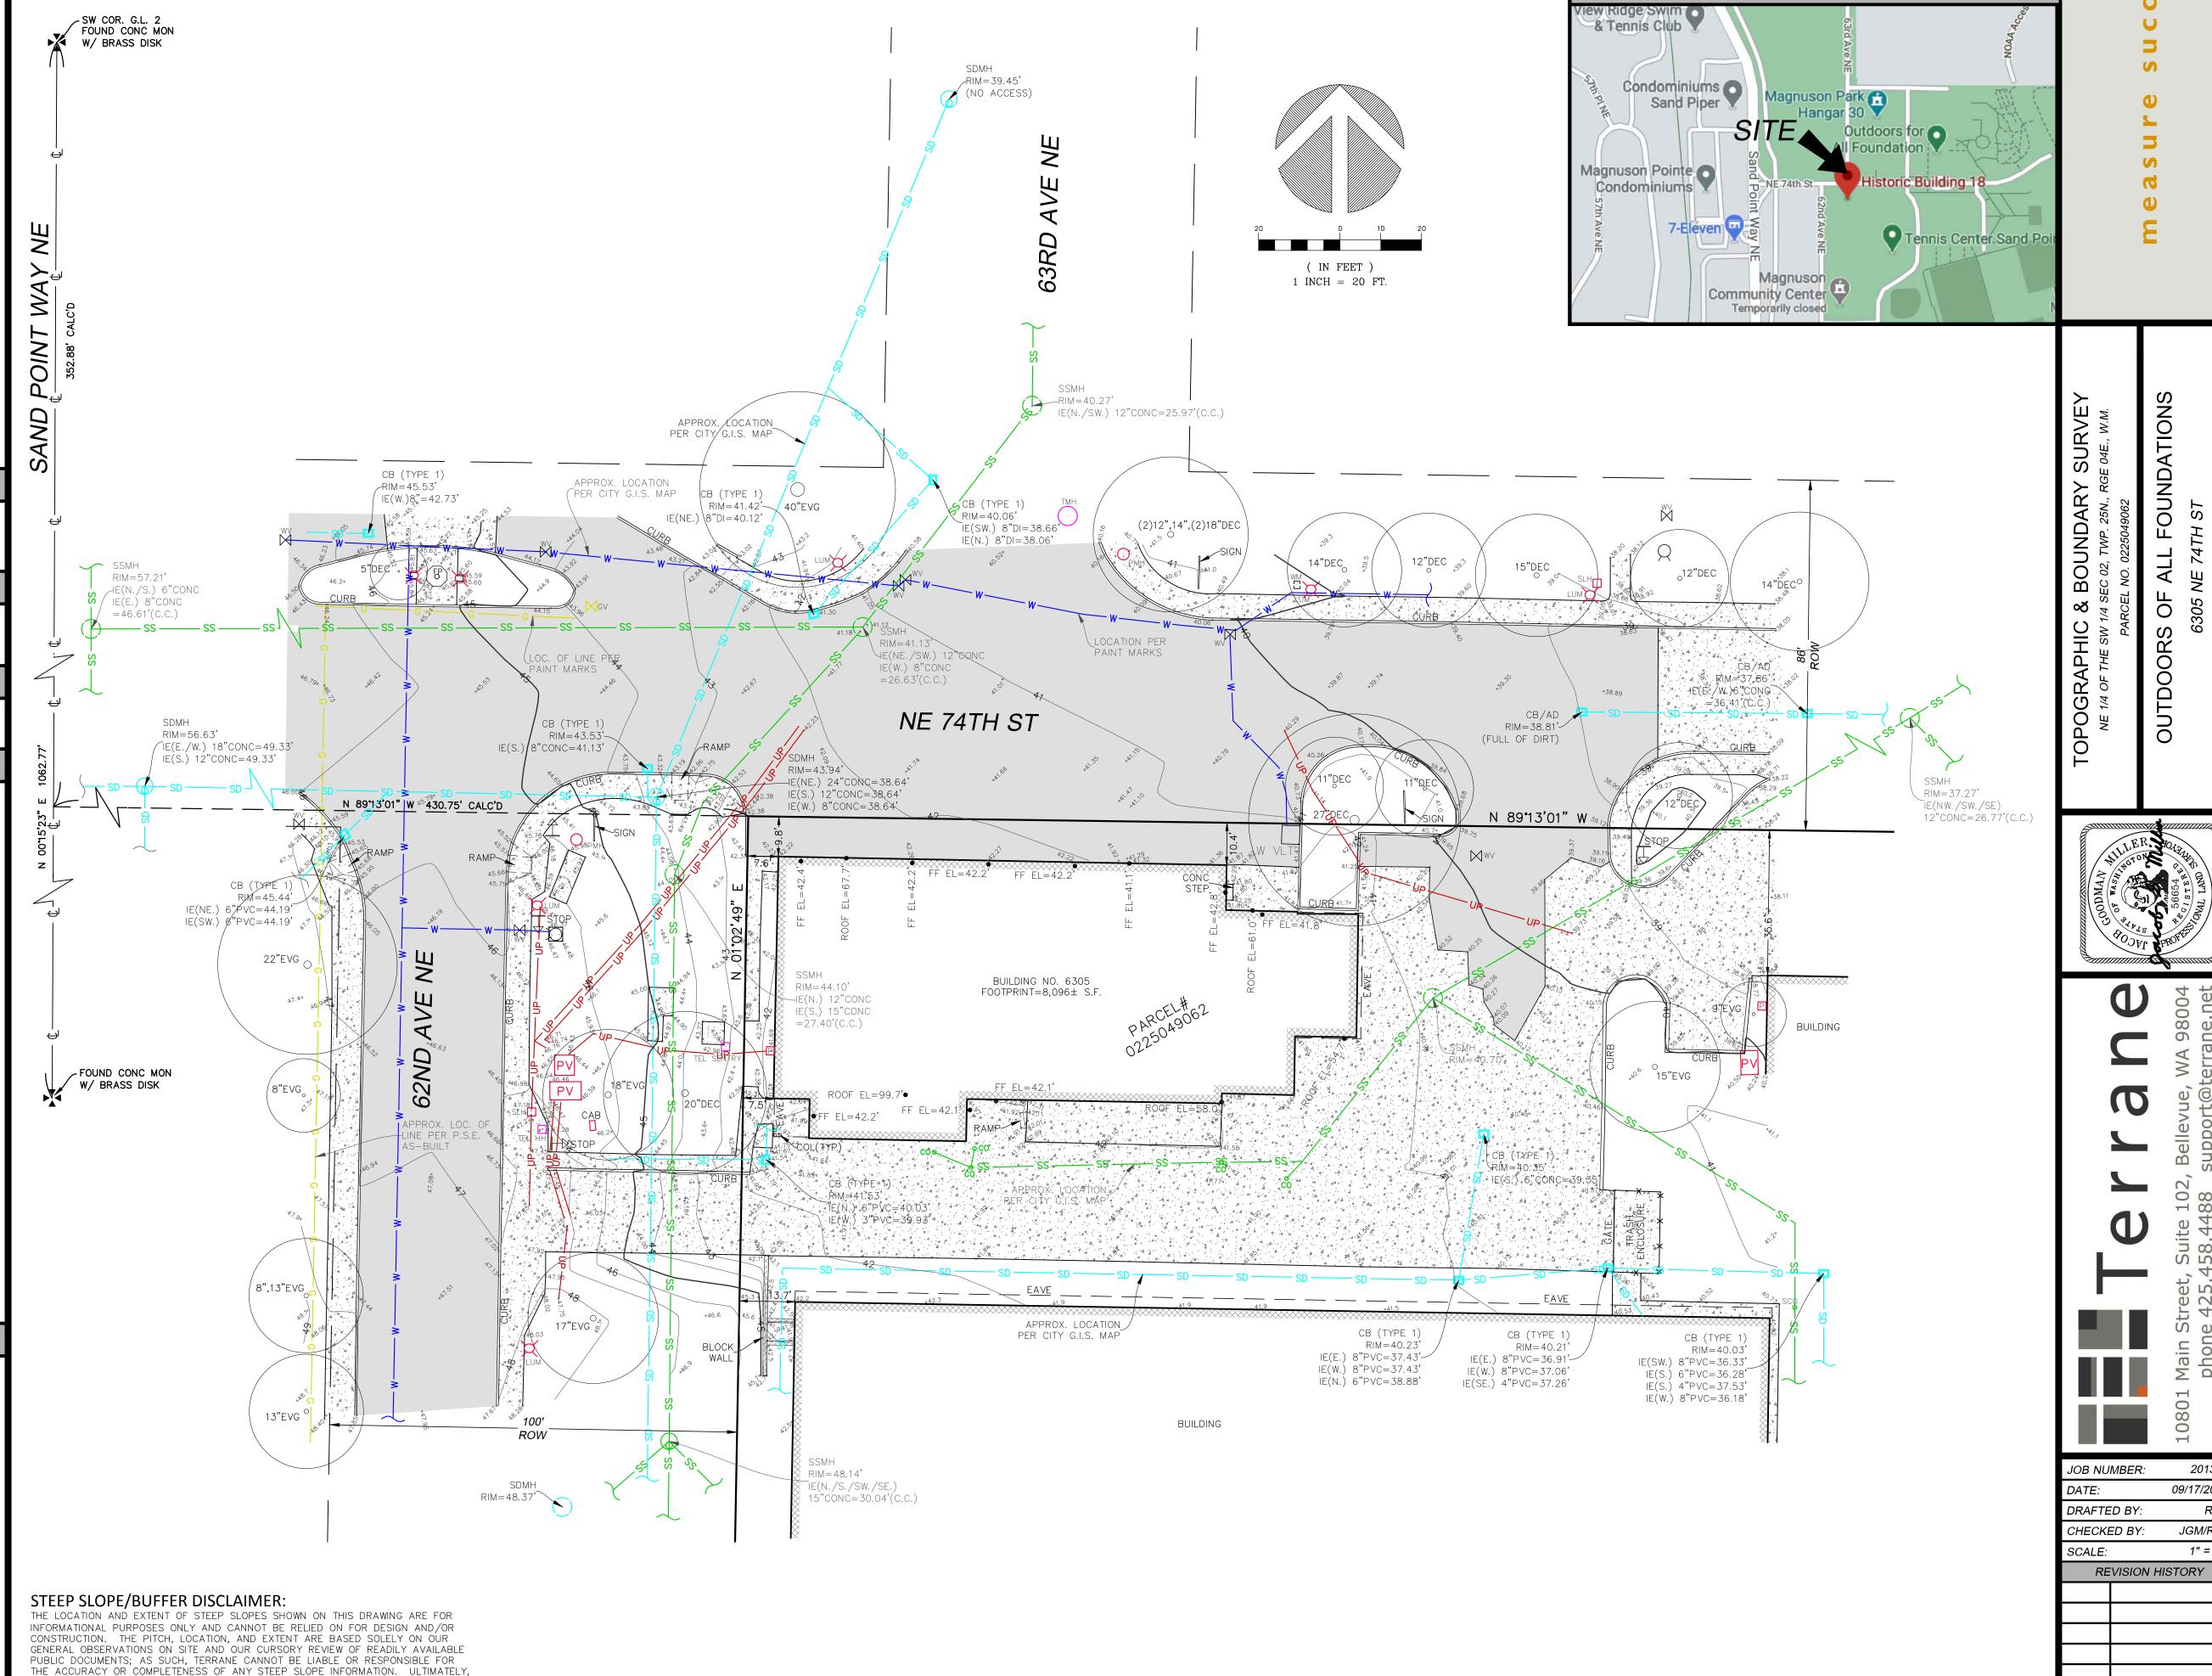

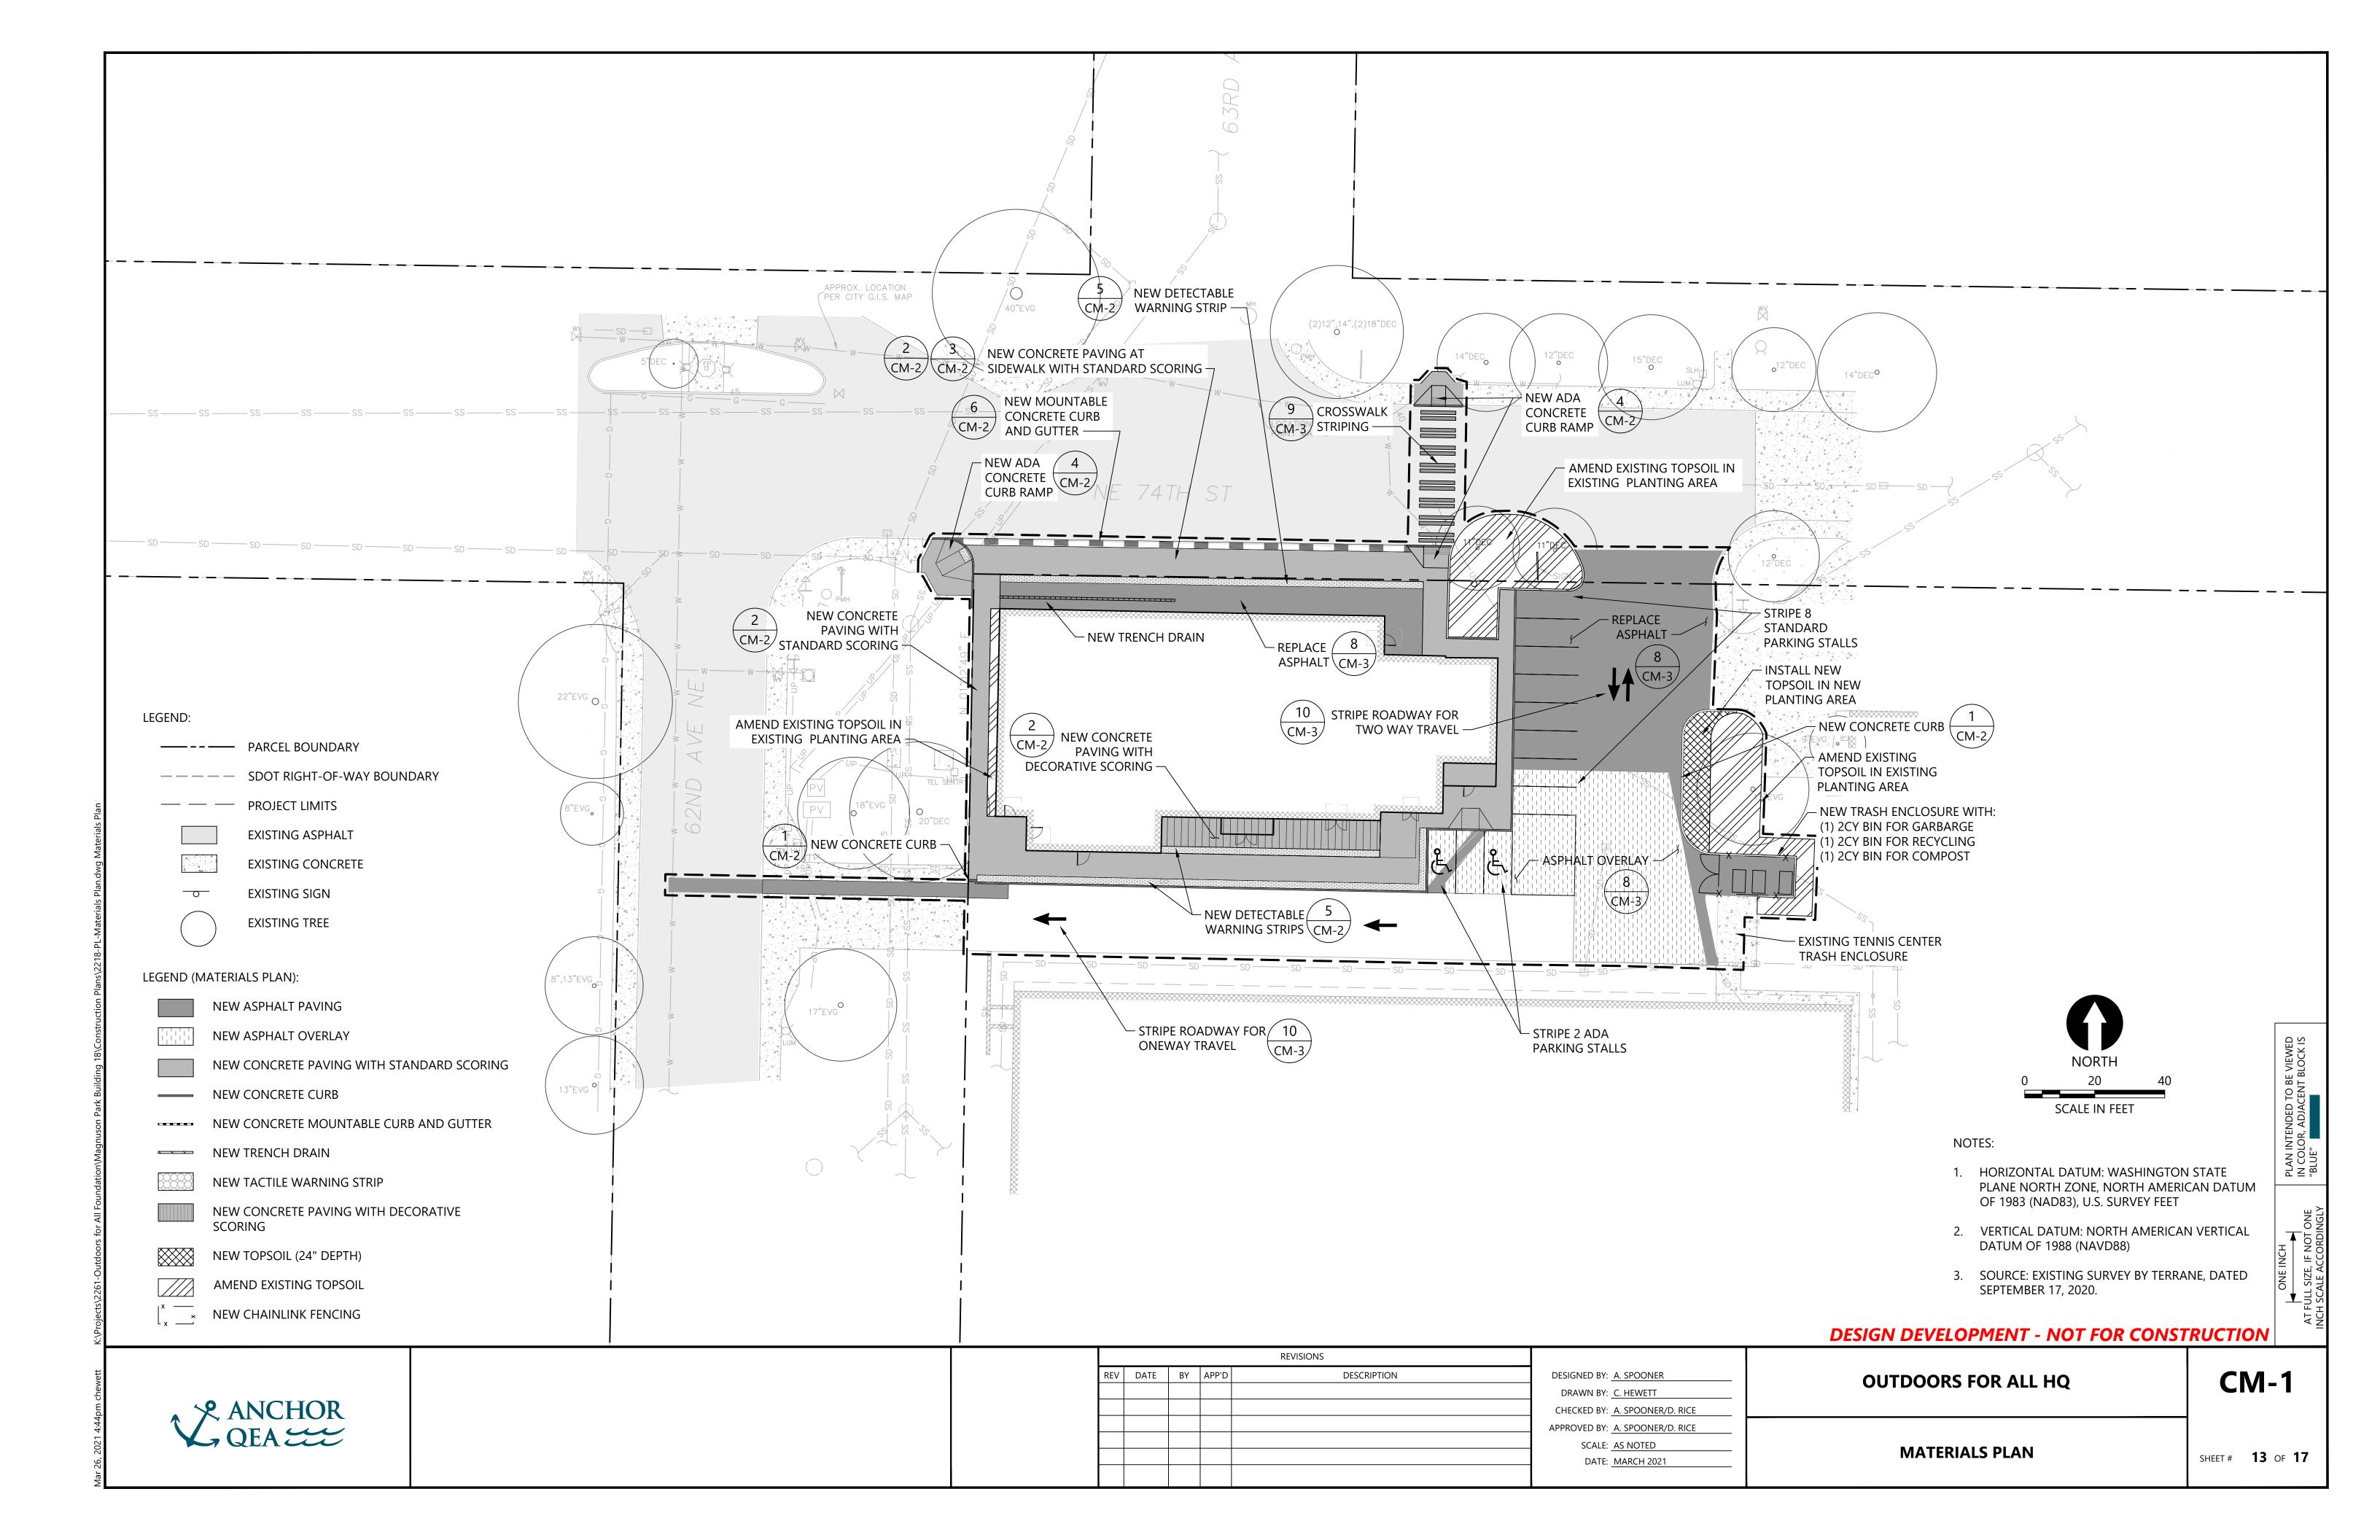

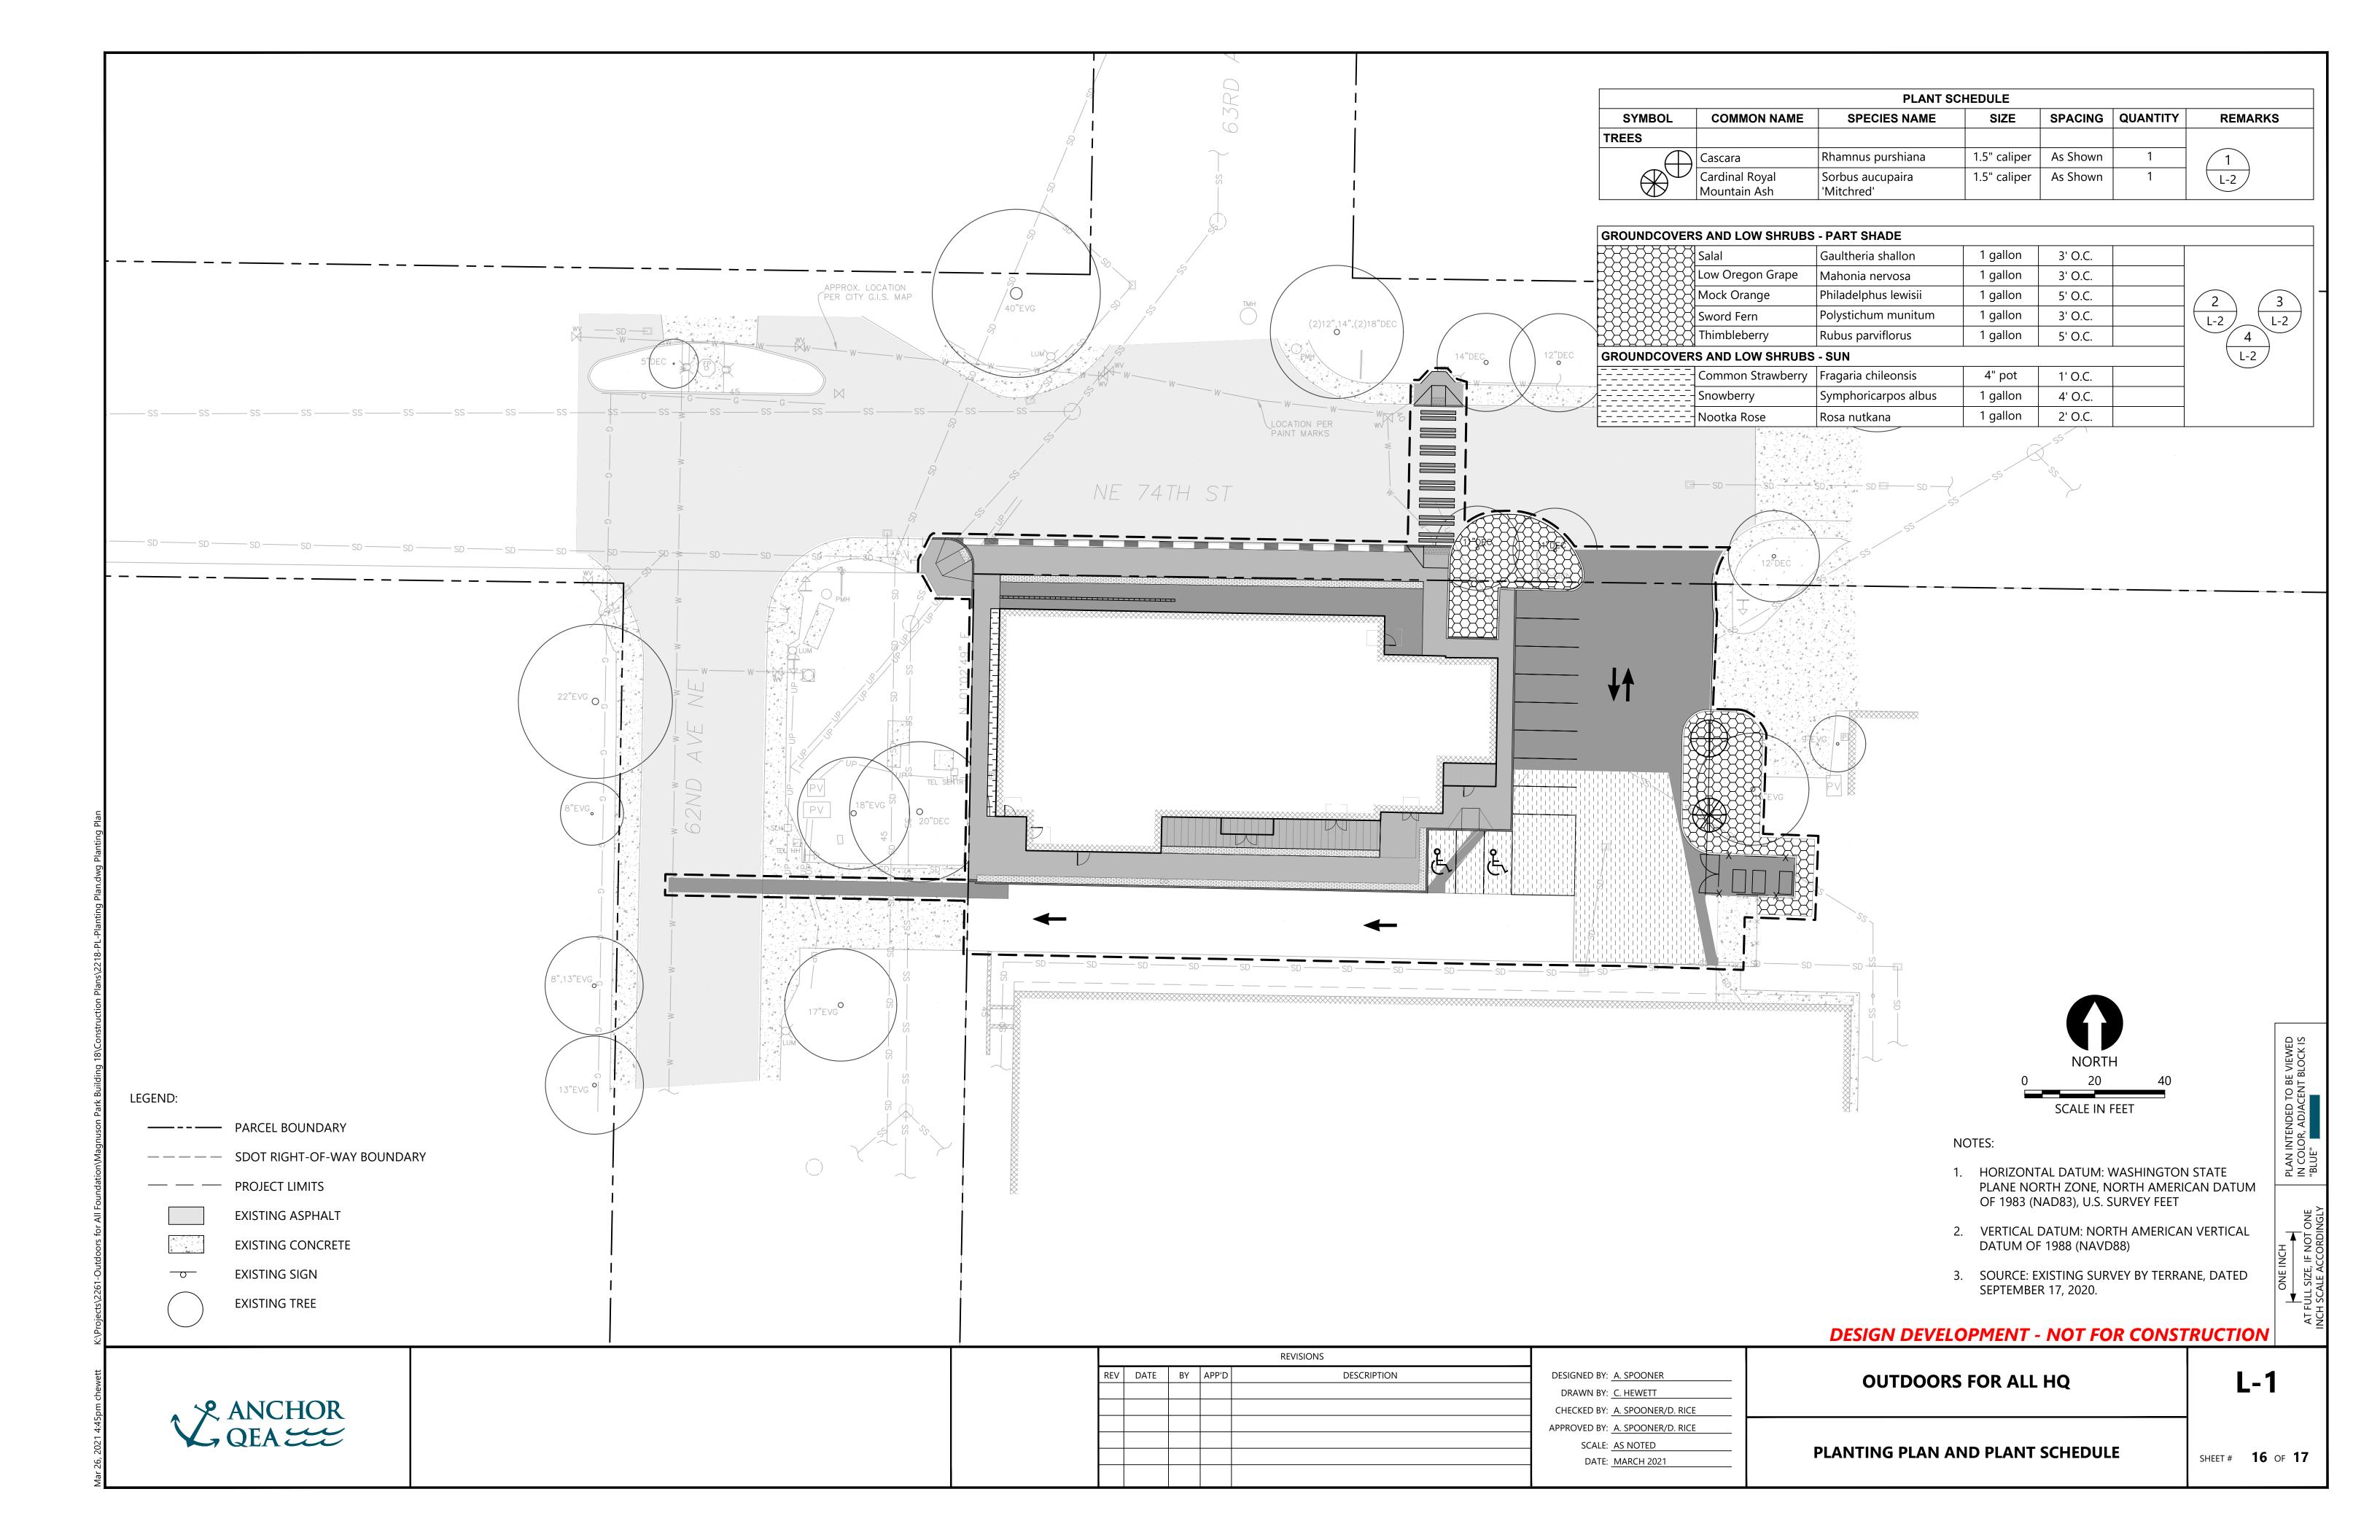

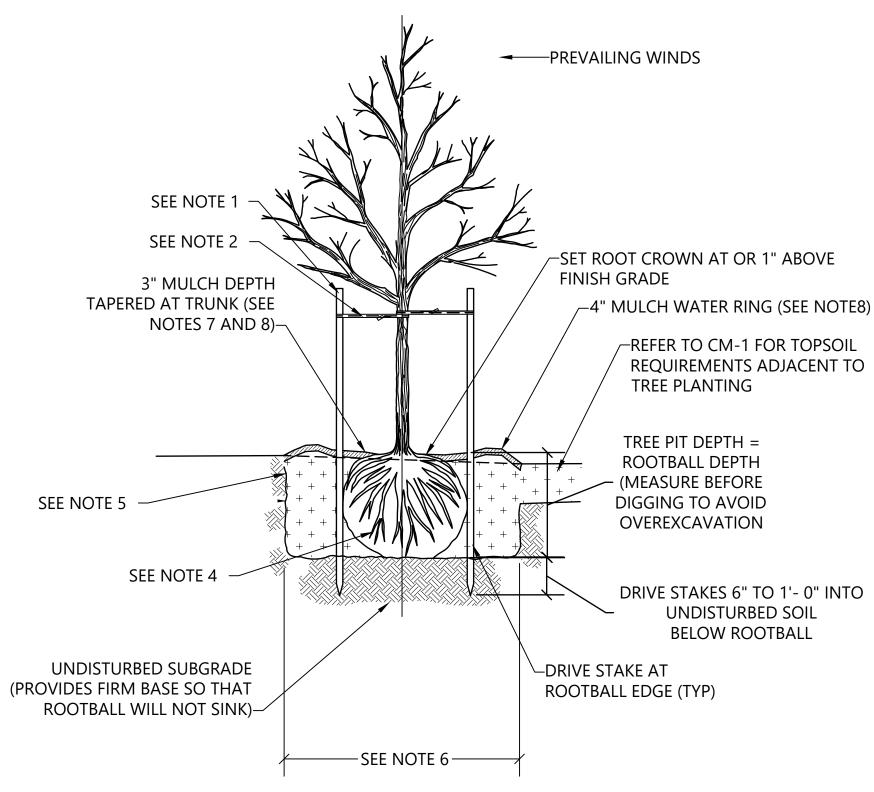


L-1 SCALE:NTS


DECIDUOUS TREE PLANTING & STAKING

1. STAKE TREES WITH (2) 2" DIAMETER (8'-0" LENGTH) LODGE POLE PINE


- OR DOUGLAS FIR STAKES. 2. CHAINLOCK TREE TIE. LOOP EACH TIE AROUND TREE LOOSELY TO
- PROVIDE 1" SLACK FOR DIAMETER GROWTH. 3. ONE STAKE PER TREE ON WINDWARD SIDE; SECOND STAKE ON
- LEEWARD SIDE.
- 4. REMOVE ALL WIRE, STRING, BURLAP, AND PLASTIC.
- 5. SHAPE SOIL TO PROVIDE 5' DIAMETER OR TWO TIMES ROOTBALL DIAMETER, WHICHEVER IS GREATER, WATERING RING.
- 6. ROUGHEN SIDES OF PLANTING HOLE MAXIMIZE EXCAVATED AREA WITHOUT UNDERMINING ADJACENT PAVING/CURB.
- 7. MULCH AREA TO BE CLEAR OF GRASS, WEEDS, ETC. TO REDUCE COMPETITION WITH TREE ROOTS.
- 8. MULCH SHALL CONFORM TO WSDOT 9-14.5(8) FINE COMPOST AND SHALL BE BROWN IN COLOR.

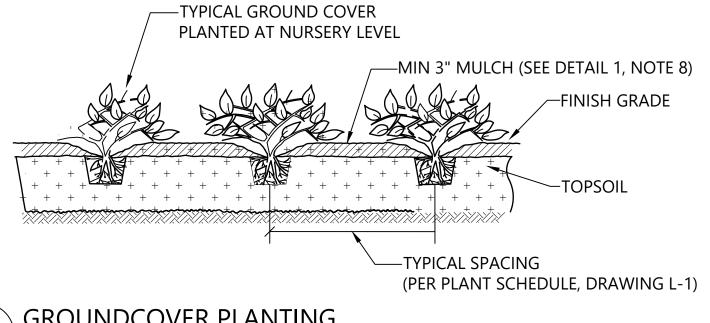



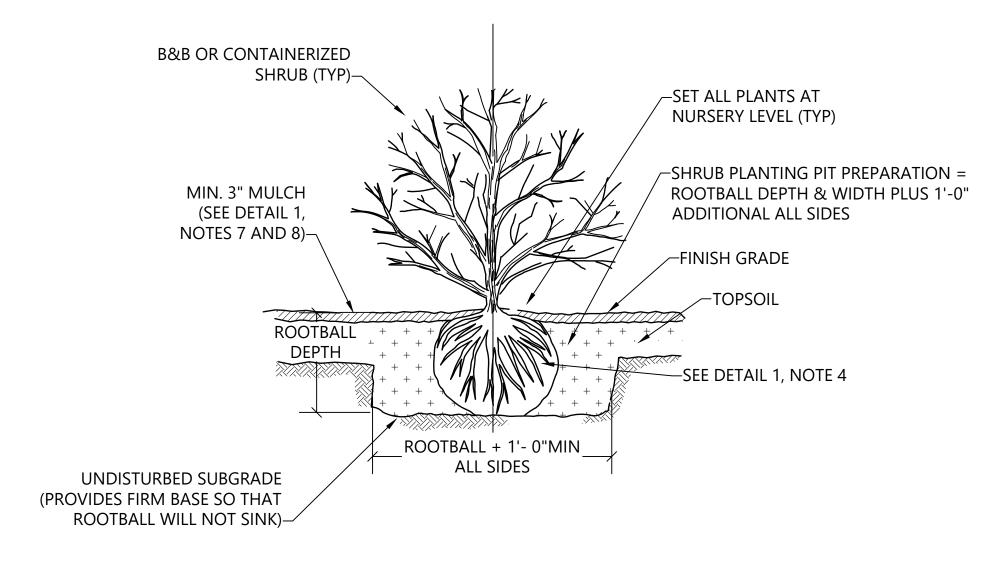

SHRUB PLANTING SCALE:NTS

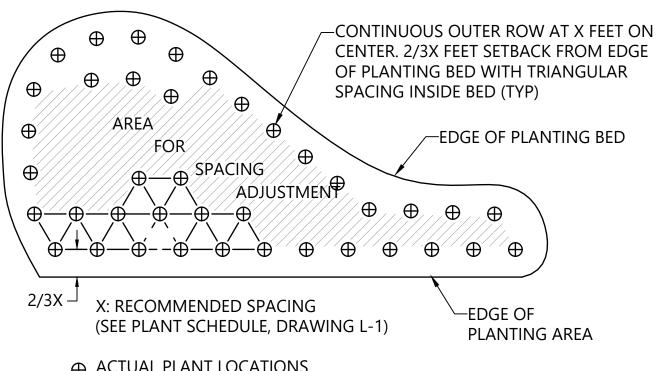

⊕ ACTUAL PLANT LOCATIONS

NOTES: APPLY PLANTING PATTERN FOR SHRUB AND GROUNDCOVER PLANTINGS



DESIGN DEVELOPMENT - NOT FOR CONSTRUCTION

				REVISIONS
REV	DATE	BY	APP'D	DESCRIPTION

DESIGNED BY: I. LASTNAME	
DRAWN BY: <u>C. HEWETT</u>	
CHECKED BY: A. SPOONER/D. RICE	
APPROVED BY: A. SPOONER/D. RICE	
SCALE: AS NOTED	
DATE: MARCH 2021	

OUTDOORS FOR ALL HQ

PLANTING DETAILS

SHEET # 17 OF 17

L-2

BUILDING 18 AT MAGNUSON PARK **PROJECT ADDRESS** 6305 NE 74th STREET SEATTLE, WA 98115

STREET IMPROVEMENT PERMIT: **PERMIT NUMBERS** SUSIP0000139 MASTER USE PERMIT: 3037518-LU **BUILDING PERMIT:** 6818112-CN

ASSESSOR'S PARCEL # 022504-9062

LEGAL DESCRIPTION PORTION STR 02-25-04 DESCRIBED AS FOLLOWS:

COMMENCING AT QTR CORNER COMMON TO SECTIONS 2 & 11-25-04 TH N15-58-06 W 2978.33 FT TO CONCRETE MONUMENT STAMPED 10 AS SET BY NOAA TH N 89-57-50 E 690.52 FT TO CONCRETE MONUMENT STAMPED 9 TH S 00-01-58 E 546.89 FT TO TPOB TH CONTG S 00-01-58 E 276.81 FT TO CONCRETE MONUMENT STAMPED 10-6 TH N 89-57-50 E 447.35 FT TO CONCRETE MONUMENT STAMPED 10-5 TH N 20-12-50 E 298.36 FT TH S 89-38-18 W 550.63 FT TO TPOB TGW PORTIONS STR 02-25-04 AS DESCRIBED IN DEED TO CITY OF SEATTLE UNDER REC NO 9905041194 AS PARCEL 1-LOT A, PARCEL 1-LOT B PARCEL 1-LOT C, PARCEL 1-LOT D, PARCEL 1-LOT E, PARCEL 3-LOT E, PARCEL 6-LOT A, PARCEL 6-LOT B, PARCEL 6-LOT C, PARCEL 6-LOT D, PARCEL 6-LOT F, PARCEL 6-LOT G, & PARCEL 6B WESTERN SEGMENT

HISTORIC REHABILITATION AND TENANT IMPROVEMENT OF **PROJECT DESCRIPTION** BUILDING 18 AT MAGNUSON PARK.

SF 7200

ZONE OVERLAYS SAND POINT OVERLAY DISTRICT & SAND POINT PARK

AREA - SUBAREA B MANDATORY HOUSING AFORDABILITY (MHA) FEE AREA

(MEDIUM AREA) FREQUENT TRANSIT SERVICE AREA (PROPERTY MAY BE ELIGIBLE FOR A REDUCED PARKING

REQUIREMENT BASED ON THE ZONE AND PROPOSED USE. SMC23.54.015 AND SMC23.54.020.)

SAND POINT NAVAL AIR STATION LANDMARK DISTRICT **HISTORIC DISTRICT**

BUILDING TYPE COMMERCIAL

PEAT SETTLEMENT PRONE AREA - ECA11; CATEGORY 2 **ENVIRONMENTAL CRITICAL AREA**

R.O.W DESIGNATION

NE 74TH STREET & 62ND AVENUE NE - NEIGHBORHOOD YIELD STREETS

NOTES


- 1. SITE INFORMATION IS BASED ON SURVEY BY TERRANE DATED 09/17/20
- 2. SEE LANDSCAPE DRAWINGS FOR PLANTINGS, HARDSCAPE AND IMPERVIOUS SURFACE CALCULATIONS
- 3. SEE CIVIL DRAWINGS FOR PROPOSED DRAINAGE AND UTILITIES
- 4. FINISH GRADES TO BE COORDINATED WITH CIVIL ENGINEER AND ARCHITECT
- 5. SEE CIVIL FOR ALL SCOPE OF WORK IN THE RIGHT-OF-WAY
- 6. SEE BUILDING SECTIONS FOR BUILDING HEIGHT INFORMATION

TACTILE WARNING STRIP

7. GRADING MUST BE STABILIZED BY OCTOBER 31ST, AND NO EXCAVATION OR FILL PLACEMENT CAN BE PERFORMED BETWEEN OCTOBER 31ST AND APRIL 1ST WITHOUT A CITY OF SEATTLE APPROVED DRY-SEASON GRADING EXTENSION, AS REQUIRED.

SITE PLAN 1/16" = 1'-0"

SITE PLAN LEGEND — – – — PARCEL LIMITS (E) TREE TO REMAIN **BUILDING FOOTPRINT** PAVING / HARDSCAPE / DECK — — — ROOF OVERHANG ---- - RIGHT OF WAY CENTERLINE (E) TREE TO BE REMOVED ACCESSIBLE ROUTE | | | | | SCORED CONCRETE

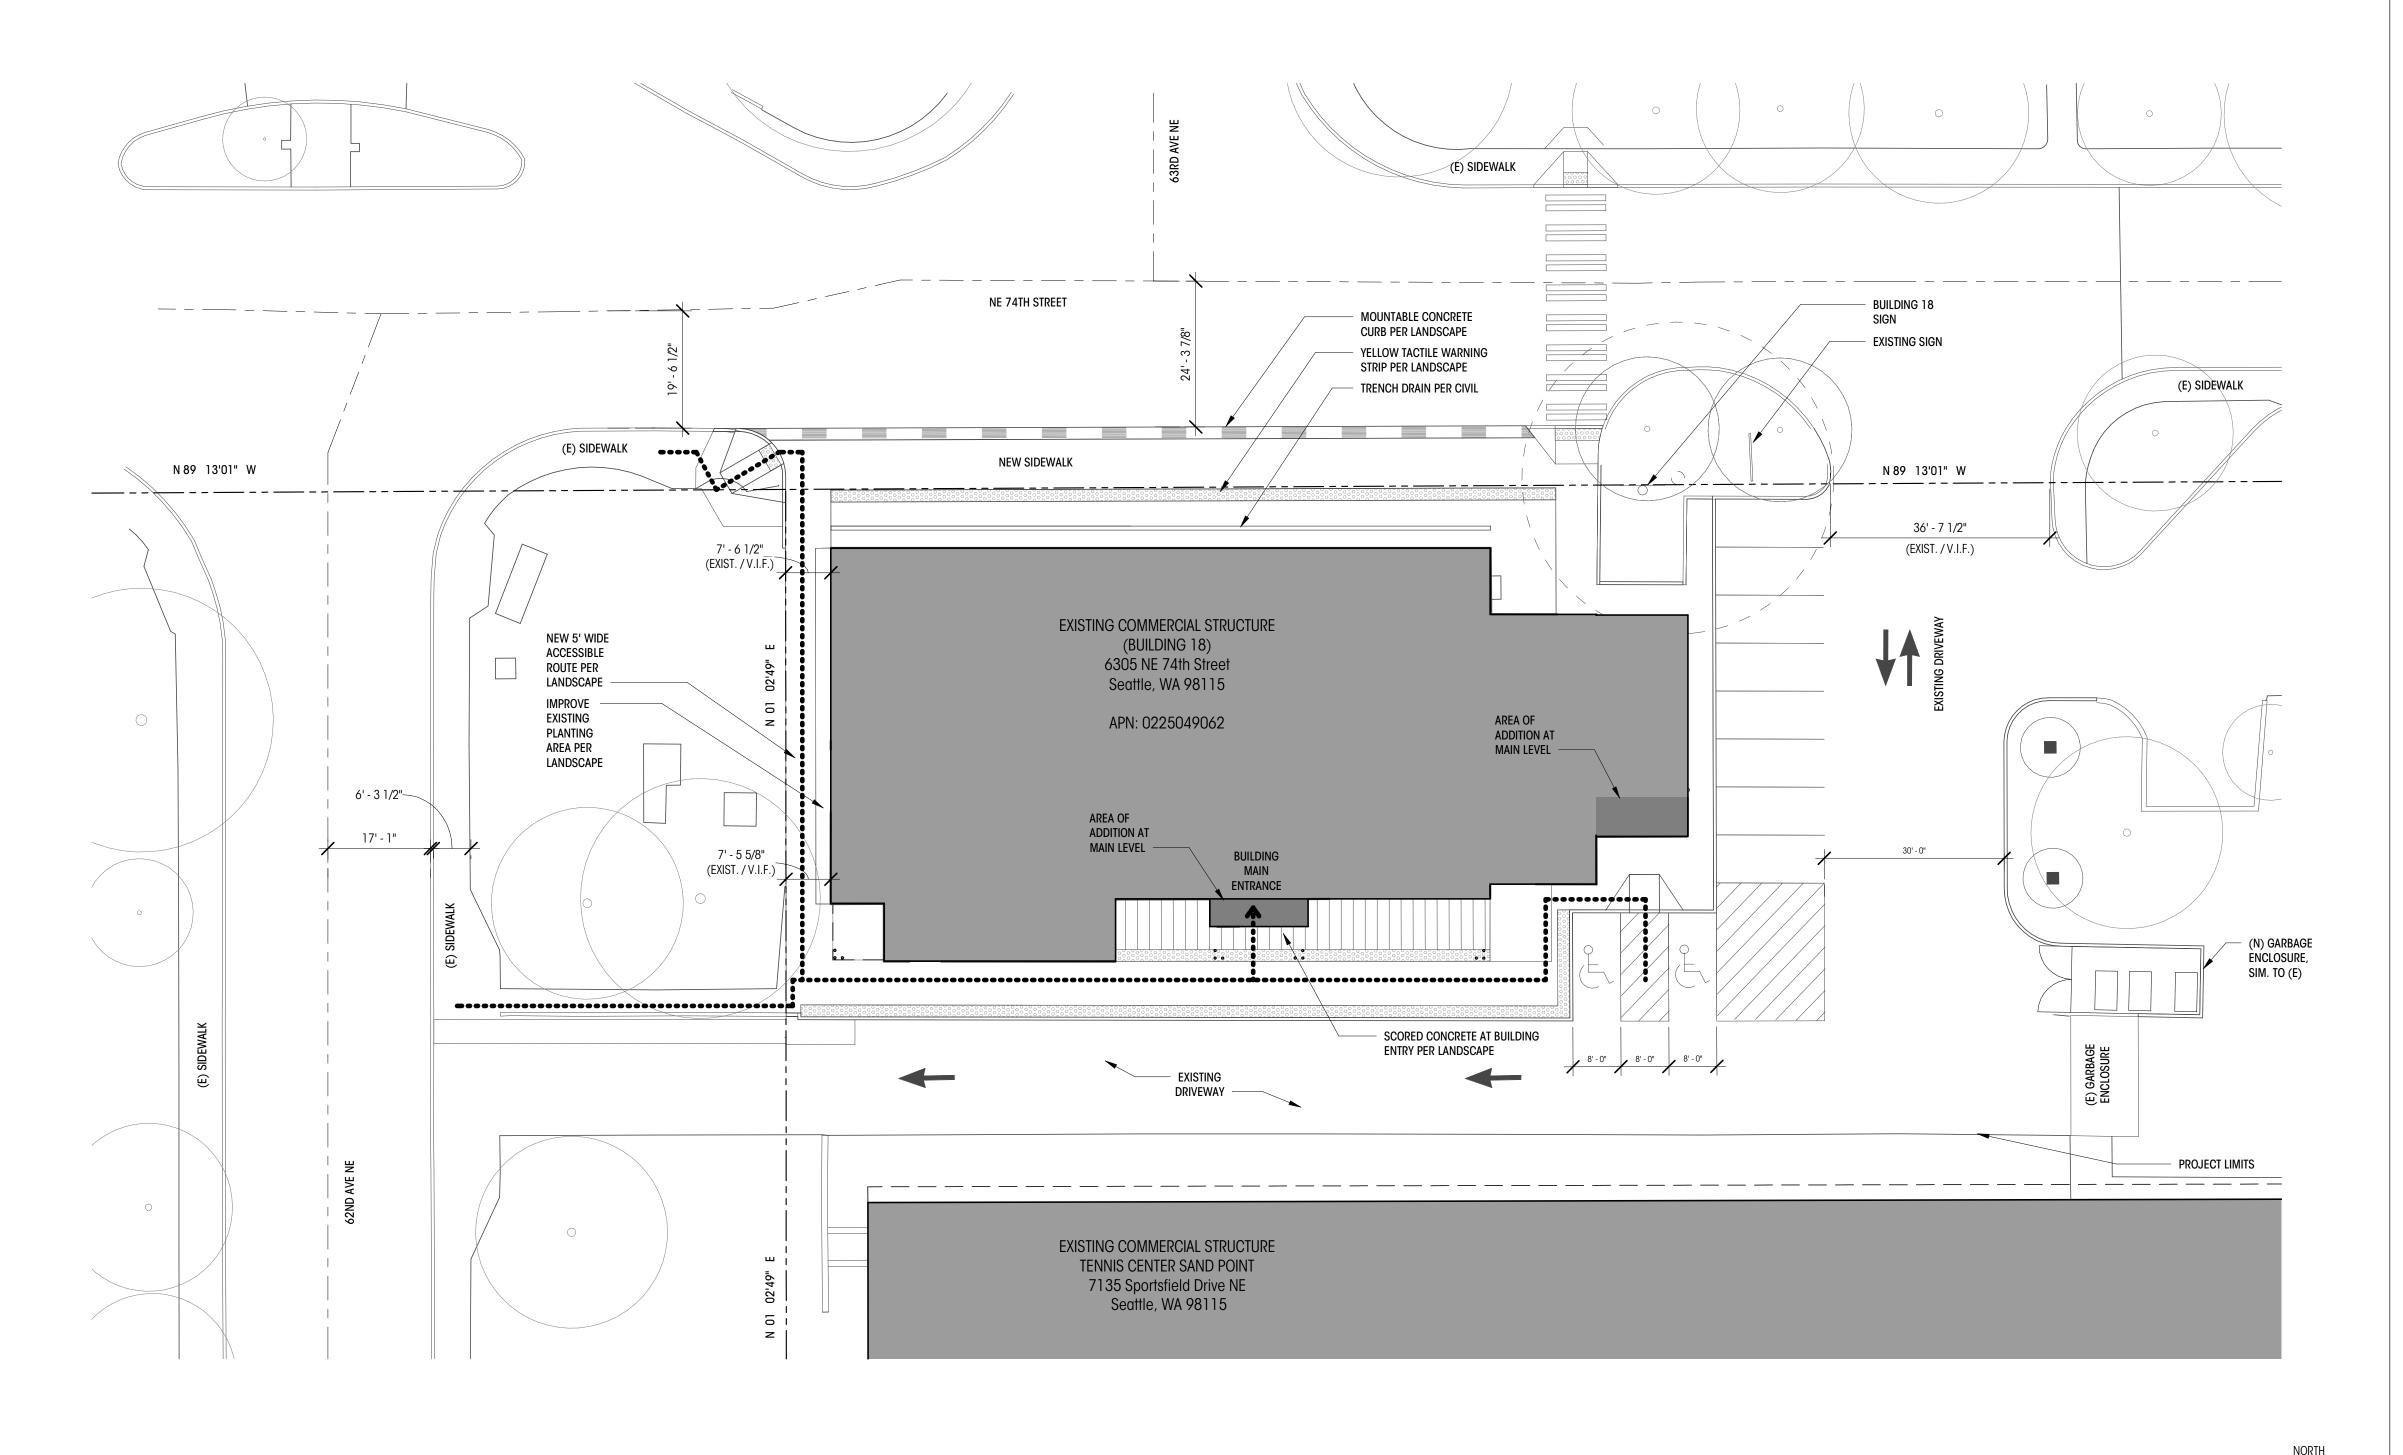

Design Group

66 Bell Street Unit 1 Seattle, WA 98121

206.239.0850

brandtdesigninc.com

100% DD SET

03/29/21


DATE: SHEET SIZE: D (24X36) **REVISIONS**

DRAWN BY: DD

CHECKED BY: KM

SITE PLAN

As indicated

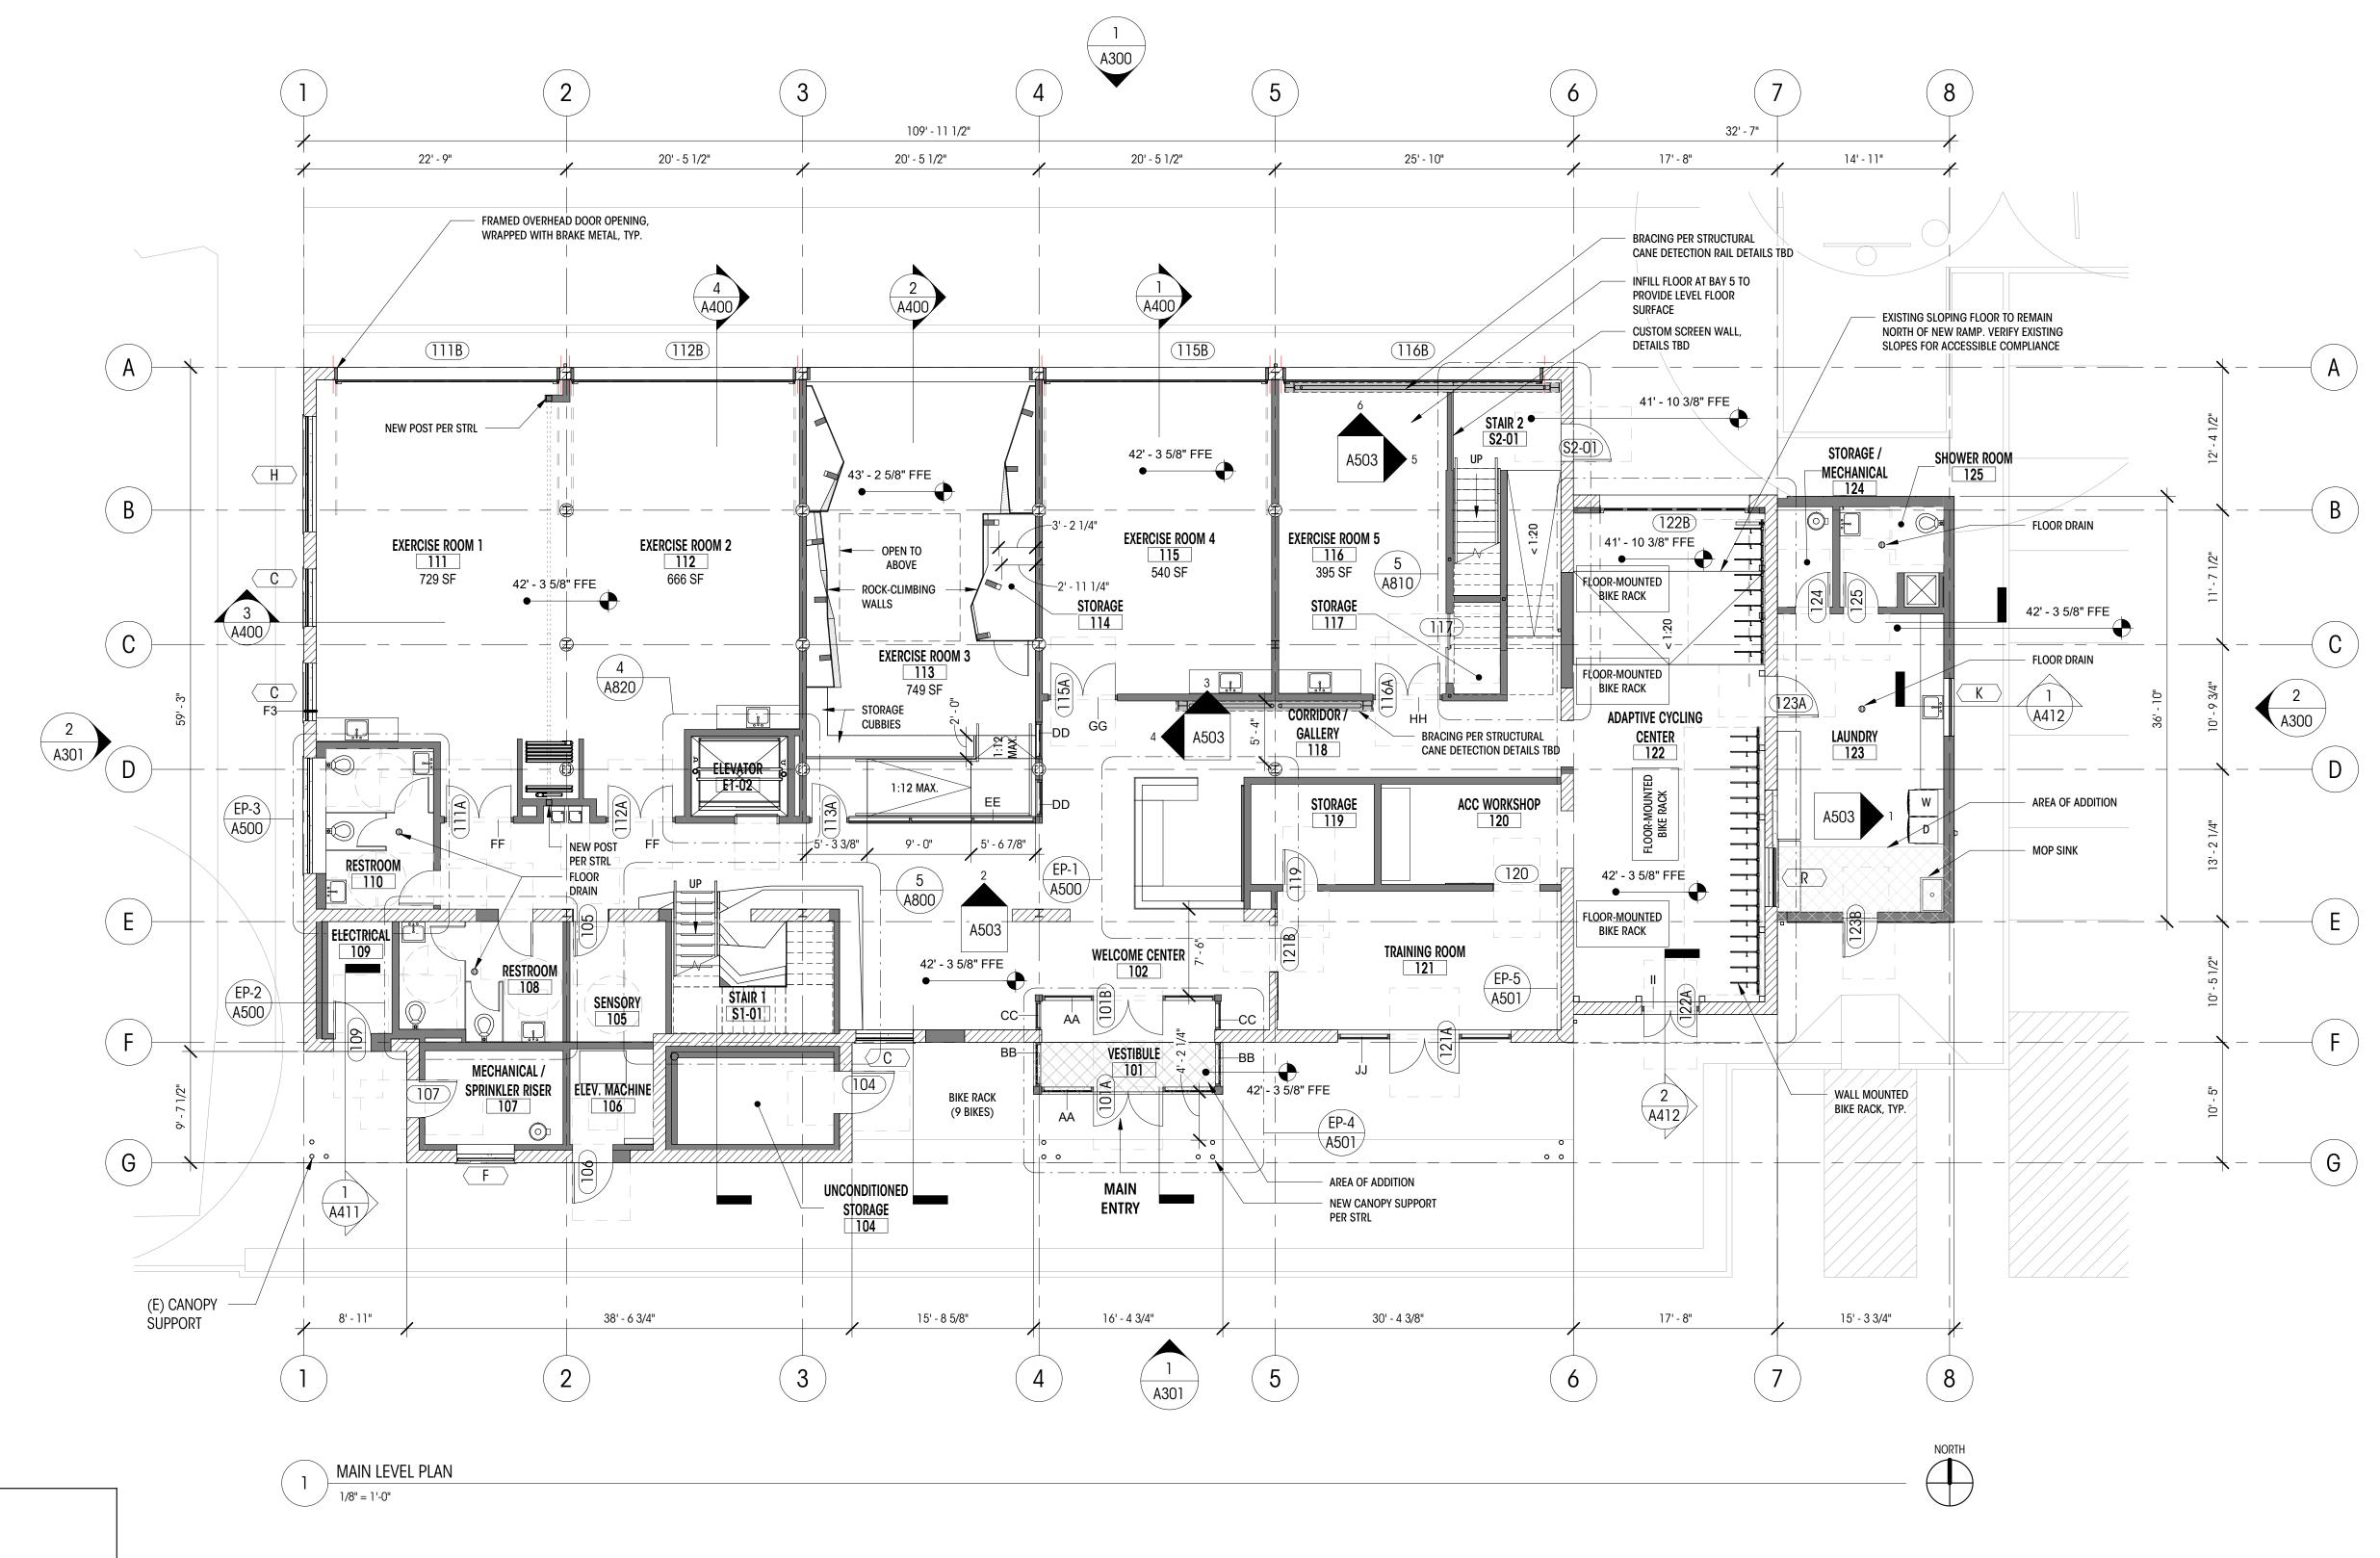



NOTES

ALL DIMENSIONS AT EXTERIOR WALLS TO FACE OF FRAMING AT EXTERIOR FACE OF WALL.
 ALL DIMENSIONS AT INTERIOR WALLS TO FACE OF FRAMING OR CONCRETE, U.N.O.
 CONTRACTOR TO ROUGH IN ALL DASHED PLUMBING. FINAL CASEWORK AND FINISH SCOPE

4. FLOOR, CEILING, AND WALL ASSEMBLIES ARE LISTED ON SHEETS A700.5. ALL WALLS ARE TYPE W6a U.N.O. REFERENCE ENLARGED PLANS FOR WALLS NOT TAGGED ON OVERALL PLAN.

6. MECHANICAL EQUIPMENT IS UNDER A SEPARATE PERMIT.

7. ELECTRIC CHARGING CAR STATIONS TBD AND PER ELECTRICAL.

8. SEE STRUCTURAL PLANS FOR LOCATIONS OF ALL COLUMNS AND SHEAR WALLS.

9. CONTRACTOR TO COORDINATE ALL MECHANICAL AND PLUMBING PENETRATIONS.

10. CONTRACTOR TO COORDINATE ROUGH OPENINGS FOR DOORS, WINDOWS AND LOUVERS.11. EXISTING ROOF SLOPES AND DRAINAGE SHOWN. FINAL ROOF DRAINAGE TBD PER

LEGEND

COORDINATION WITH SDCI.

200A WINDOW ID

EL= 148.5' (+0'-0")

MAIN LEVEL FIN. FLR.

100A DOOR ID

100A FINISH ID

NEW WALL

WALL TO REMAIN

ELEVATION DATUM

GRIDLINE

AREA OF NEW ADDITION

Brandt

Design Group

66 Bell Street Unit 1 Seattle, WA 98121

206.239.0850

brandtdesigninc.com

naidesigninc.com

OUTDOORS FOR ALL 305 NE 74th St Seattle 98115

100% DD SET

DATE: 03/29/21
SHEET SIZE: D (24X36)

SHEET SIZE: D (24X36)

REVISIONS
NO: DATE:


DRAWN BY: DD CHECKED BY: KM

MAIN LEVEL PLAN

SCALE: As indicated

N OOTO

DEDICATED
APPROVAL

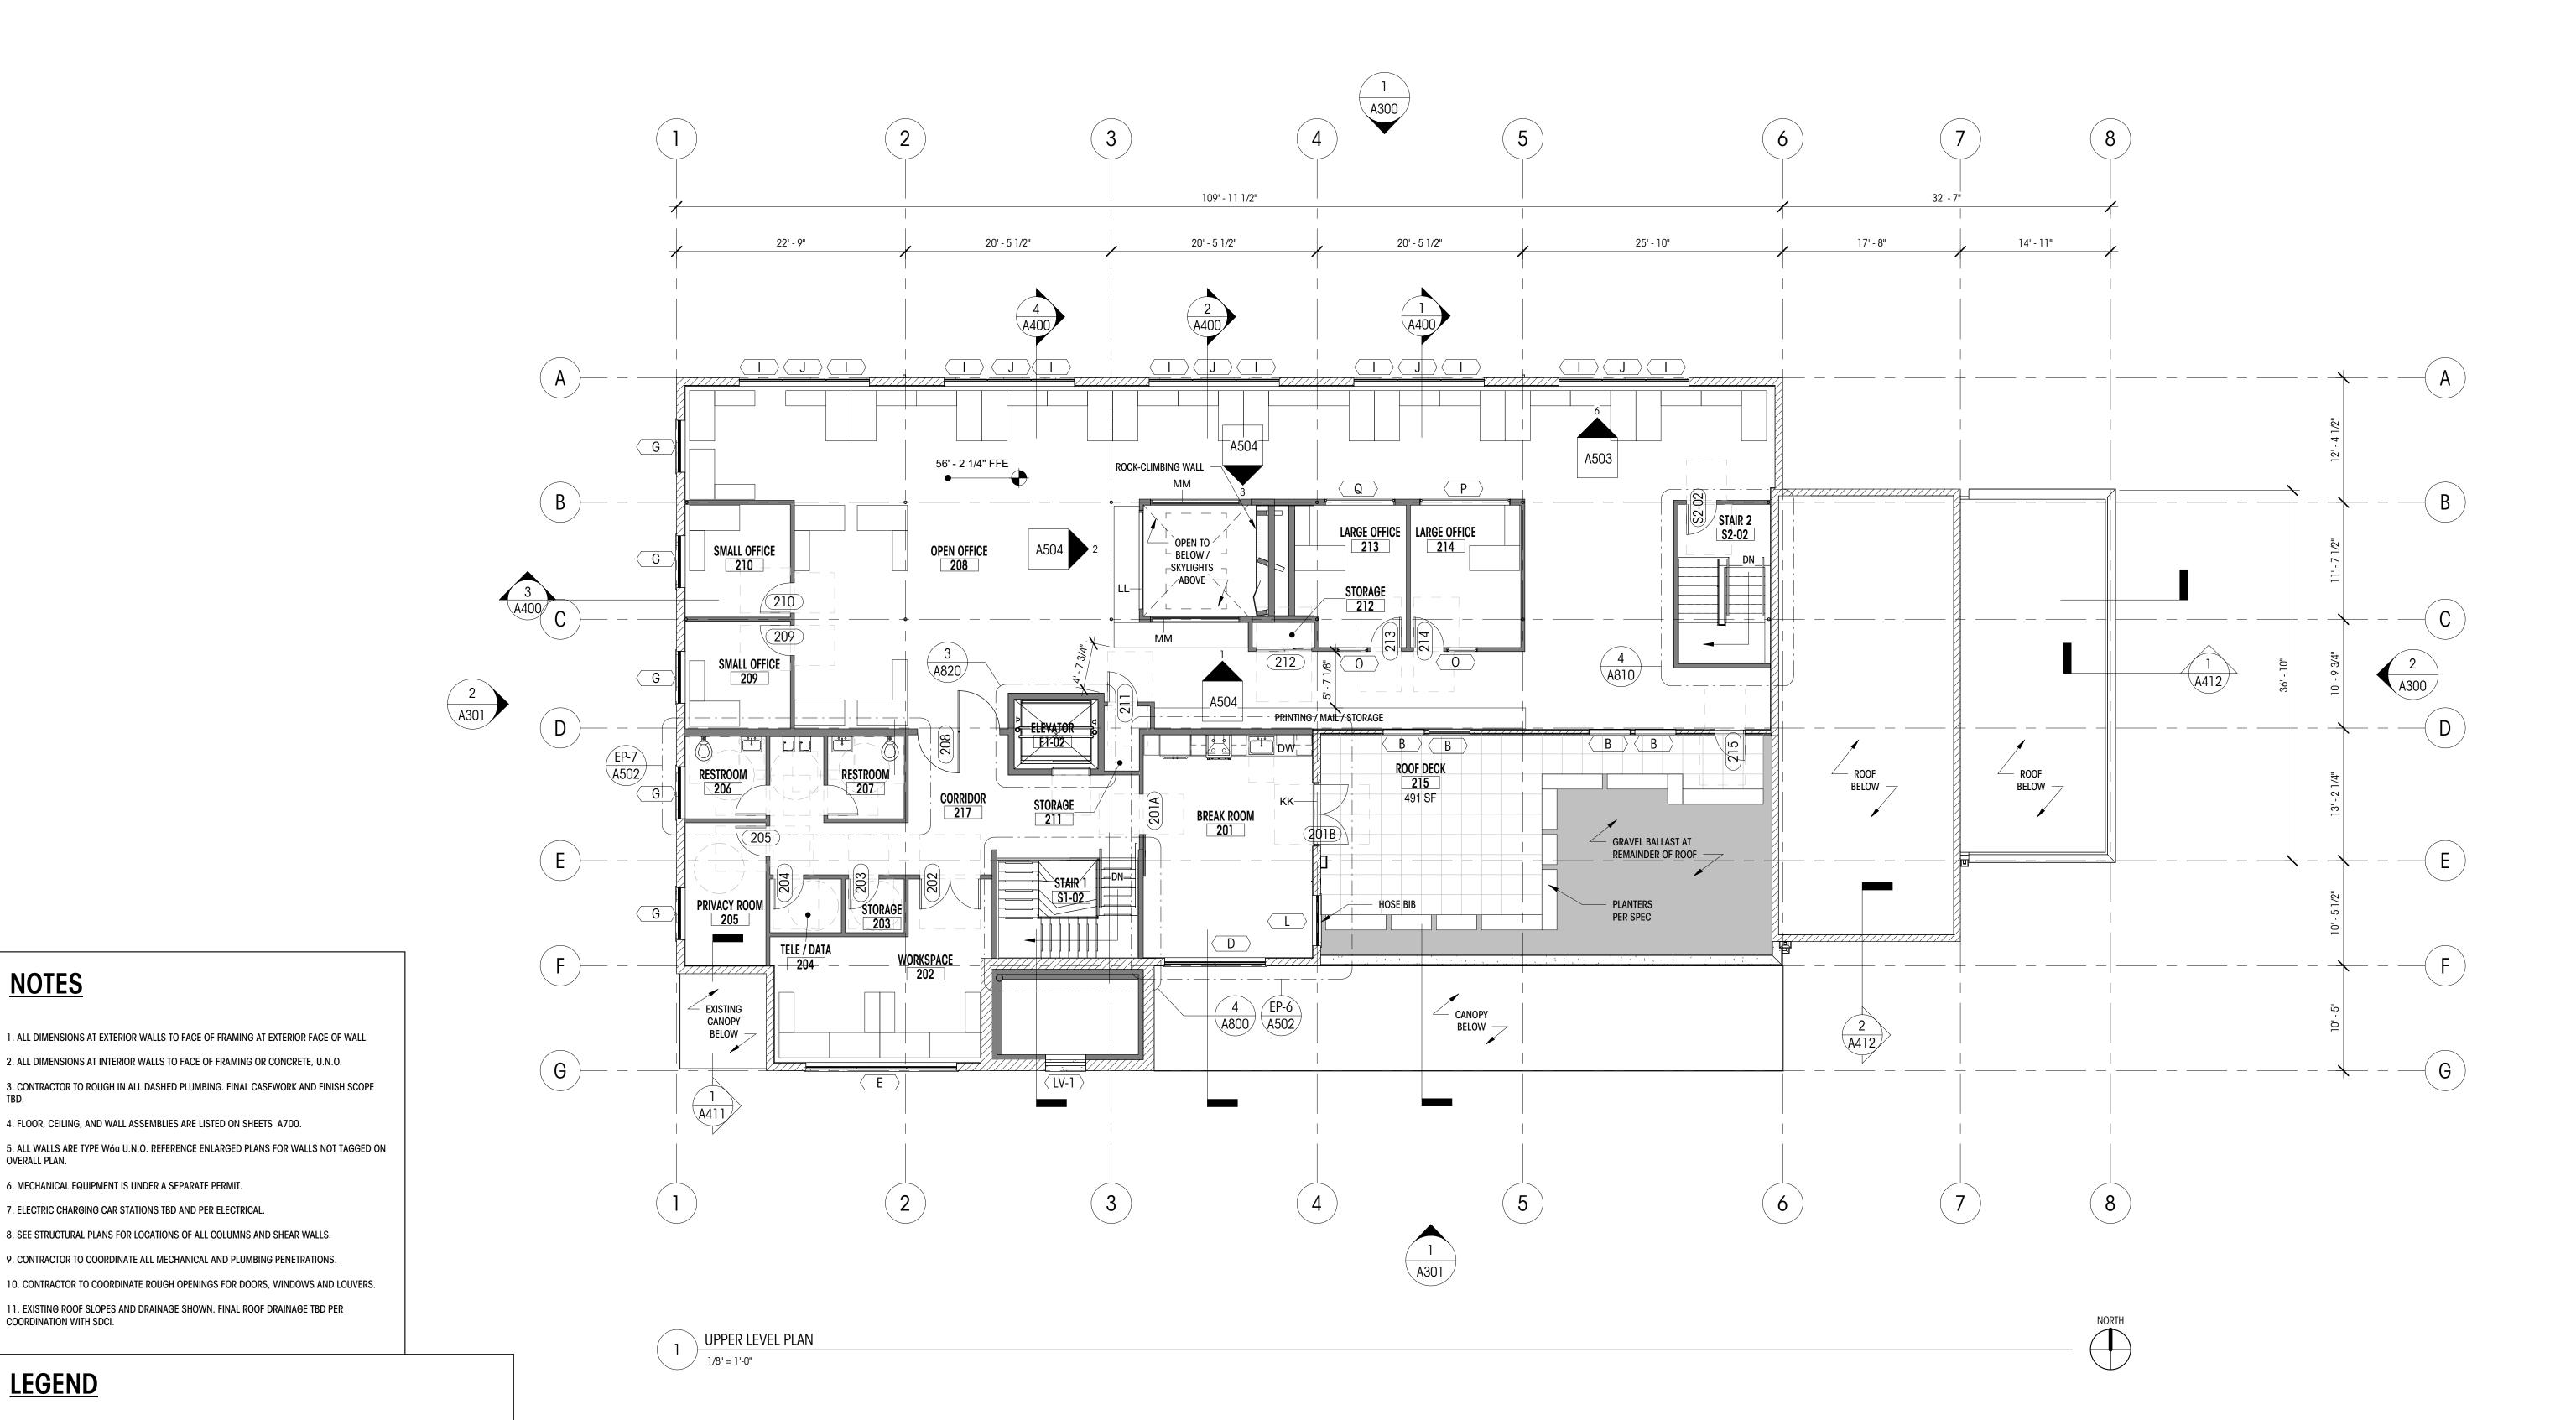

NOTES

OVERALL PLAN.

COORDINATION WITH SDCI.

LEGEND

WINDOW ID

DOOR ID

FINISH ID

WALL TO REMAIN

ELEVATION DATUM

AREA OF NEW ADDITION

 $\langle 200A \rangle$

100A

100A

4. FLOOR, CEILING, AND WALL ASSEMBLIES ARE LISTED ON SHEETS A700.

6. MECHANICAL EQUIPMENT IS UNDER A SEPARATE PERMIT.

7. ELECTRIC CHARGING CAR STATIONS TBD AND PER ELECTRICAL.

Brandt

Design Group

66 Bell Street Unit 1 Seattle, WA 98121

206.239.0850

brandtdesigninc.com

DOORS The St Seattle 98115


100% DD SET

DATE: 03/29/21 SHEET SIZE: D (24X36) **REVISIONS**

DRAWN BY: DD CHECKED BY: KM

UPPER LEVEL PLAN

As indicated

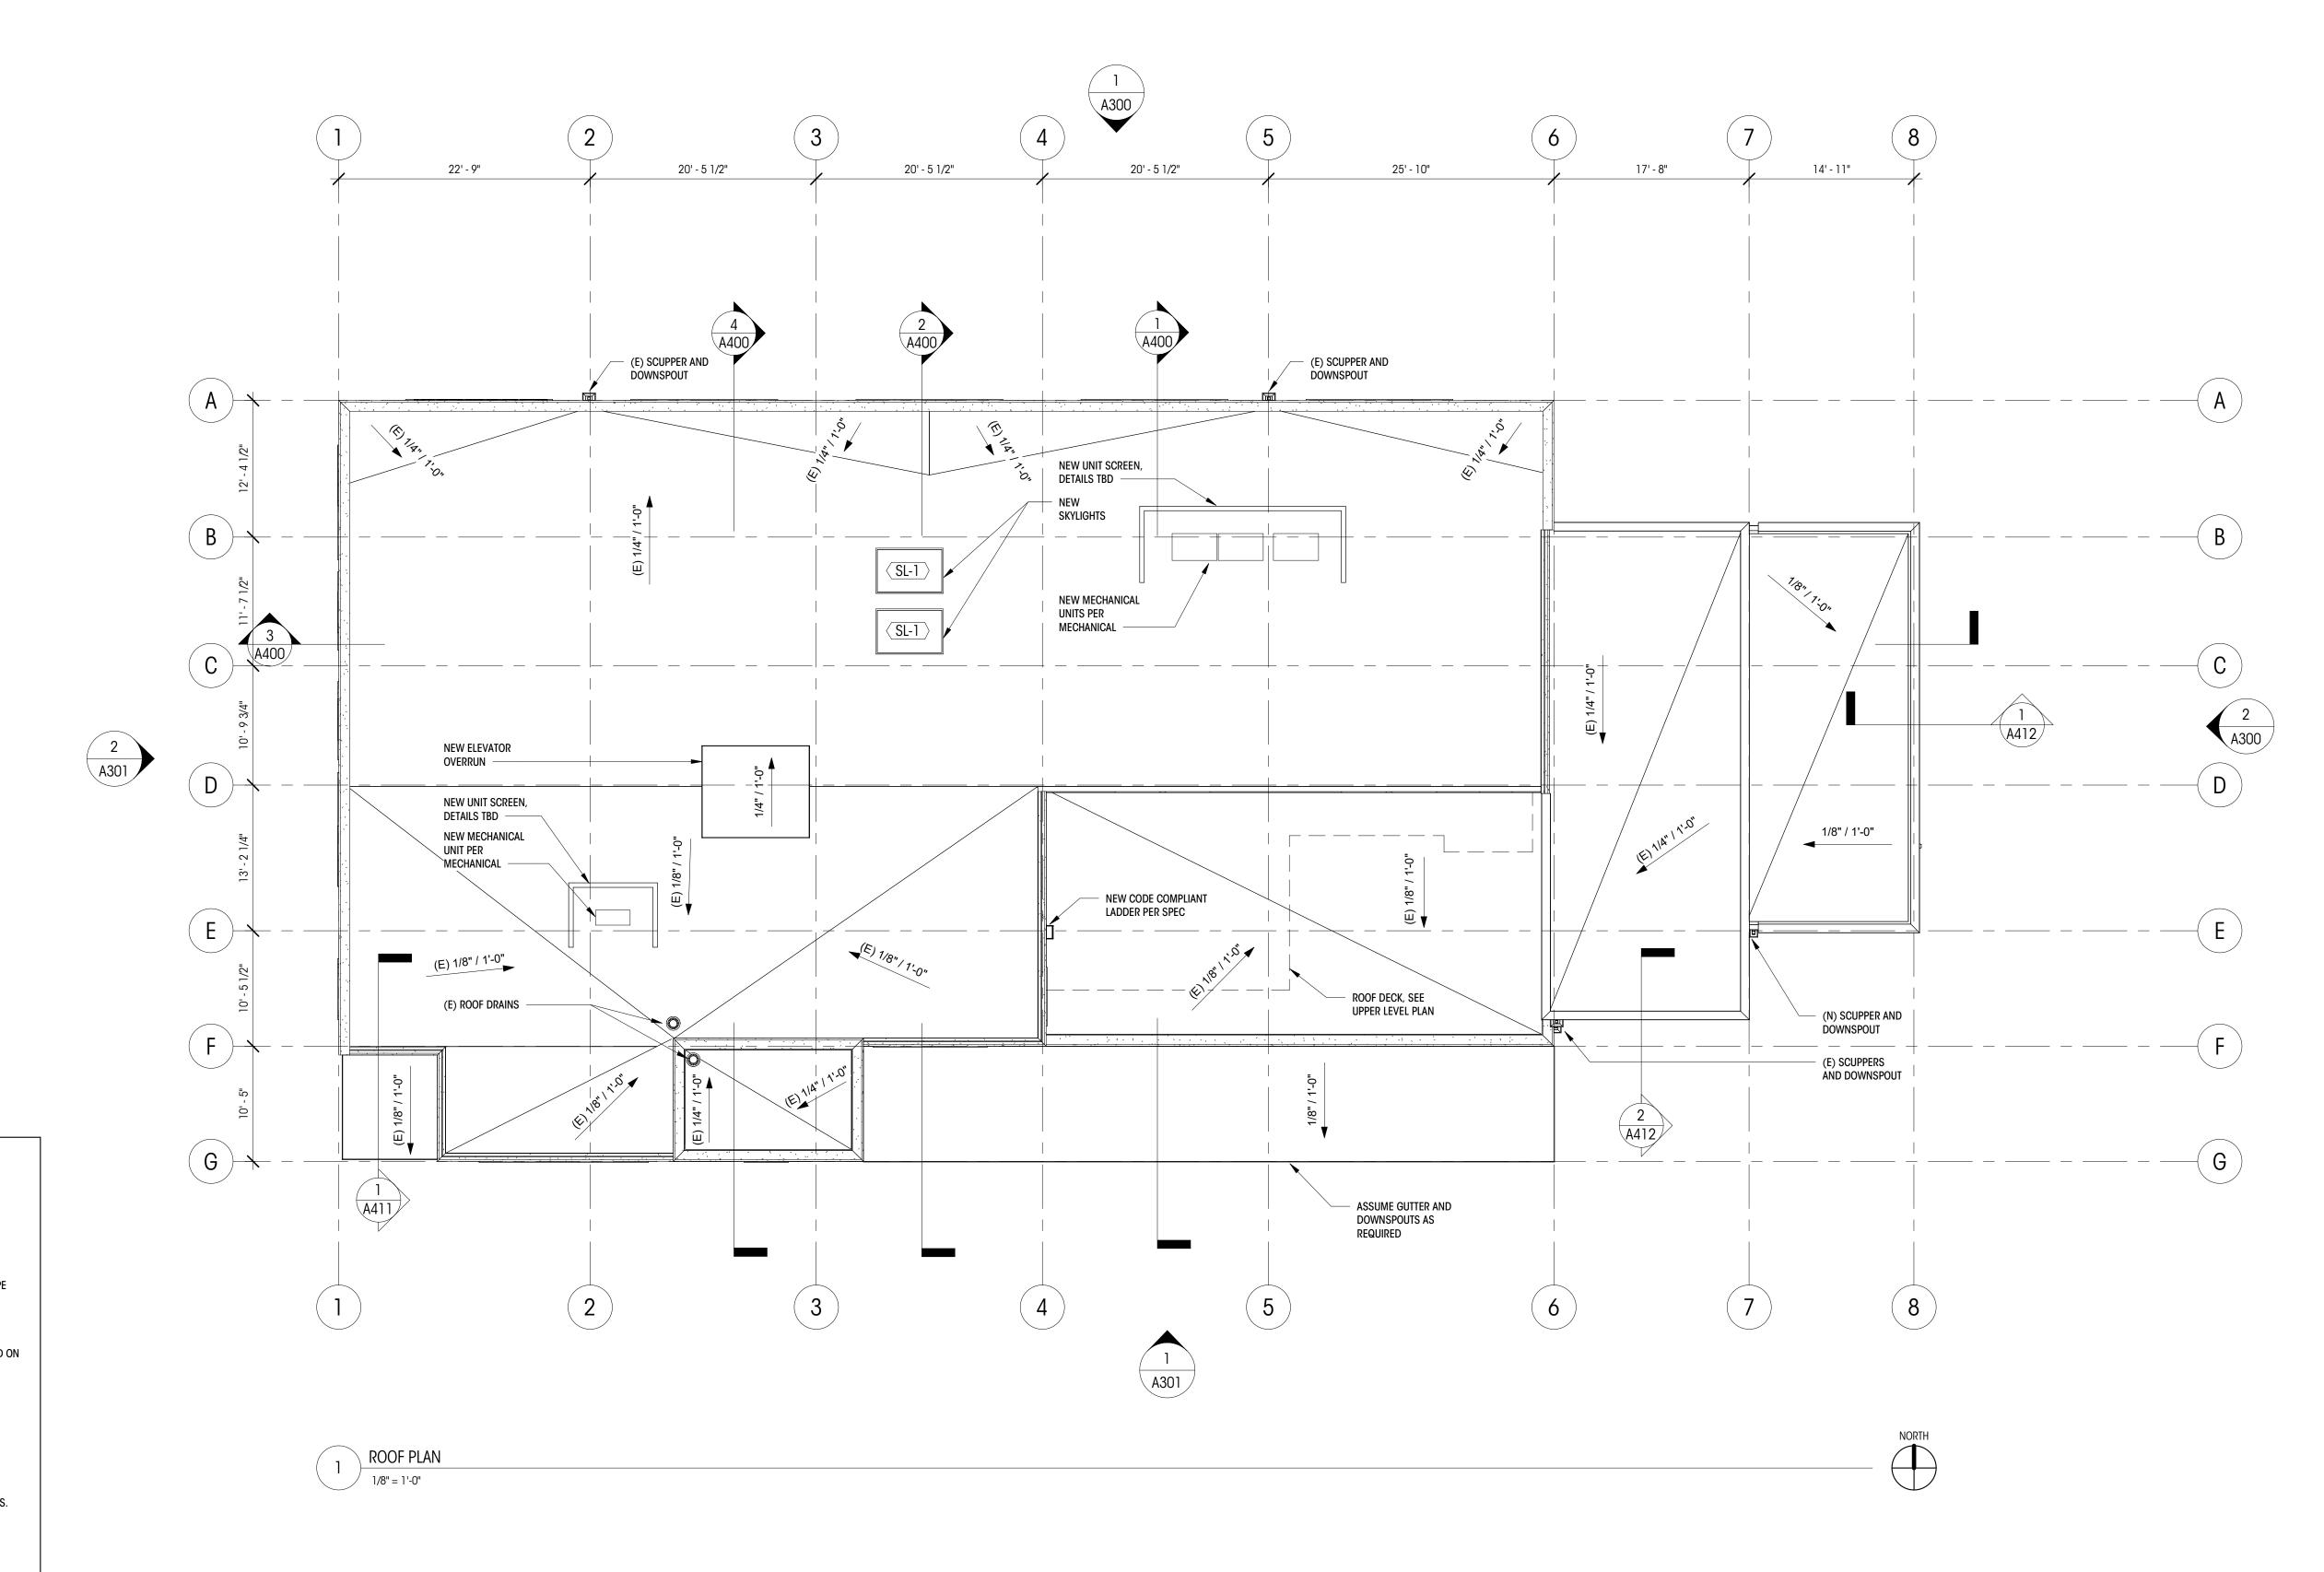

NOTES

ALL DIMENSIONS AT EXTERIOR WALLS TO FACE OF FRAMING AT EXTERIOR FACE OF WALL.
 ALL DIMENSIONS AT INTERIOR WALLS TO FACE OF FRAMING OR CONCRETE, U.N.O.

CONTRACTOR TO ROUGH IN ALL DASHED PLUMBING. FINAL CASEWORK AND FINISH SCOPE TBD.

4. FLOOR, CEILING, AND WALL ASSEMBLIES ARE LISTED ON SHEETS A700.5. ALL WALLS ARE TYPE W6a U.N.O. REFERENCE ENLARGED PLANS FOR WALLS NOT TAGGED ON OVERALL PLAN.

6. MECHANICAL EQUIPMENT IS UNDER A SEPARATE PERMIT.

7. ELECTRIC CHARGING CAR STATIONS TBD AND PER ELECTRICAL.

8. SEE STRUCTURAL PLANS FOR LOCATIONS OF ALL COLUMNS AND SHEAR WALLS.

9. CONTRACTOR TO COORDINATE ALL MECHANICAL AND PLUMBING PENETRATIONS.

10. CONTRACTOR TO COORDINATE ROUGH OPENINGS FOR DOORS, WINDOWS AND LOUVERS.

11. EXISTING ROOF SLOPES AND DRAINAGE SHOWN. FINAL ROOF DRAINAGE TBD PER COORDINATION WITH SDCI.

LEGEND

/0004

WINDOW ID

0 — — — GRIDL

Brandt

Design Group

66 Bell Street Unit 1 Seattle, WA 98121

206.239.0850

brandtdesigninc.com

OUTDOORS FOR ALL 5305 NE 74th St Seattle 98115

100% DD SET

DATE: 03/29/21

SHEET SIZE: D (24X36)

REVISIONS
NO: DATE:


DRAWN BY: DD CHECKED BY: KM


ROOF PLAN

SCALE: As indicated

A203

DEDICATED
APPROVAL

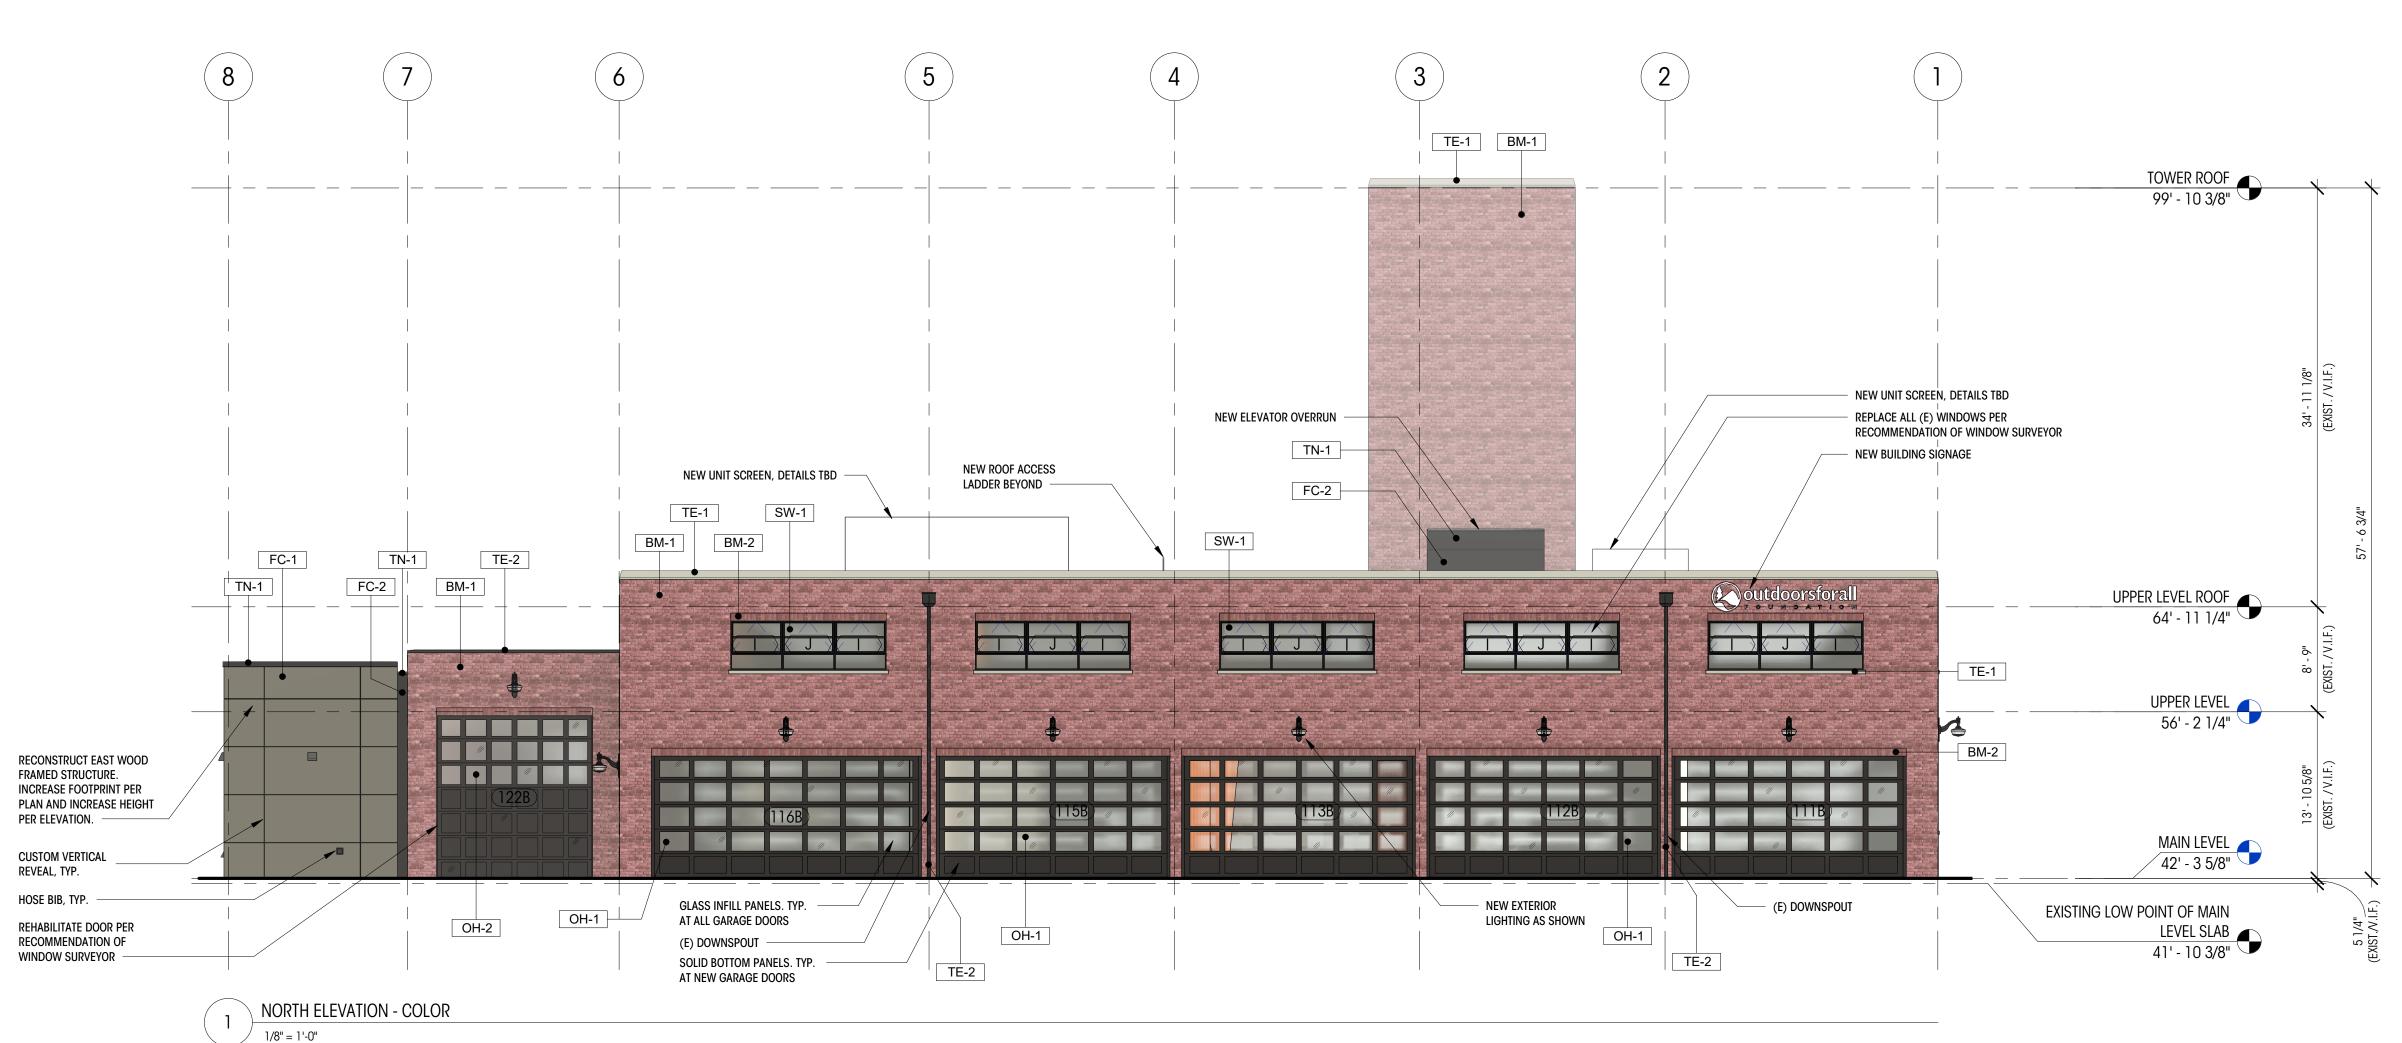

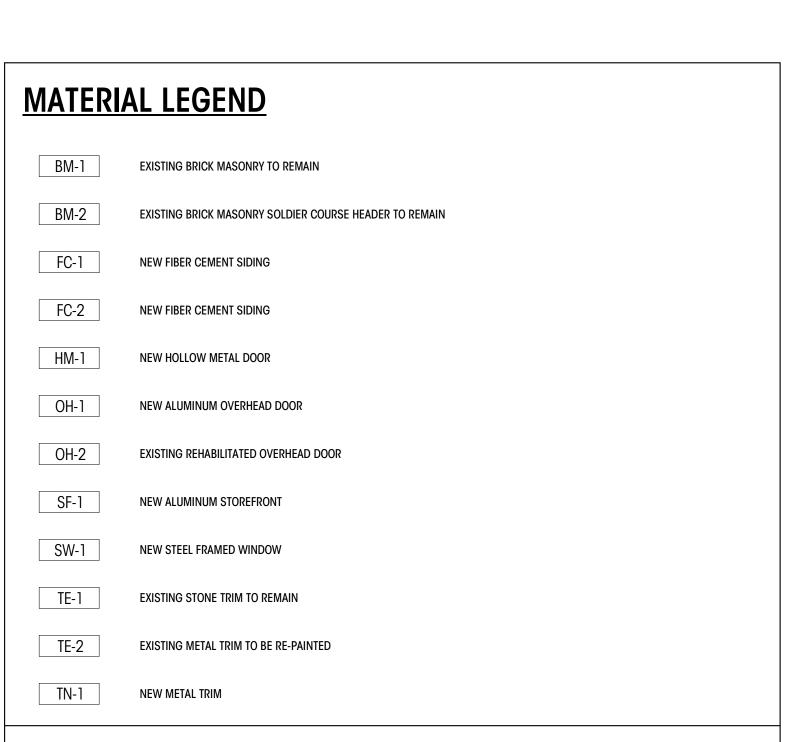


GENERAL ELEVATION NOTES

1. ALL ENVIRONMENTAL AIR EXHAUST OUTLETS SHALL BE A MINIMUM OF 3 FEET FROM OPERABLE OPENINGS INTO THE BUILDING PER SMC 501.3.1.
2. REFER TO SHEETS G004, A600 AND A601 FOR U-VALUE, SHGC, ADDITIONAL ENERGY REQUIREMENTS, INCLUIDING ENERGY EFFICIENCY OPTIONS AND HEATING SYSTEM.

3. JOINTS SHOWN ON ELEVATIONS ARE REVEALS, UNLESS NOTED OTHERWISE OR DETAILED.

4. SEE COLOR ELEVATIONS ON SHEETS A310 AND A311.5. ALL EXTERIOR MASONRY TO BE INSPECTED AND REPAIRED AS FOLLOWS:

SCRAPE ALL LOOSE AND WEAKENED MORTAR OUT TO FULL DEPTH OF THE DETERIORATION; REMOVE AND REPLACE ALL LOOSE MASONRY UNIT; CHECK FOR LOOSE FACING BRICK VENEERS, TUCK POINT ALL JOINTS SOLID. ALL MASONRY RESTORATION AND REPAIR SHALL BE PERFORMED IN SUCH A MANNER THAT THE EXISTING STRUCTURE IS NOT WEAKENED OR LEFT UNSUPPORTED DURING THE PROCESS OF THE WORK. ALL EXTERIOR APPENDAGES SUCH AS FIRE ESCAPES, CORNICES, AND EYEBROWS SHALL BE INSPECTED FOR STRUCTURAL INTEGRITY AND THE CONDITION OF THE CONNECTIONS TO THE STRUCTURE. CONTRACTOR TO PROVIDE THE STRUCTRUAL ENGINEER WITH THE RESULTS OF THE INSPECTION.

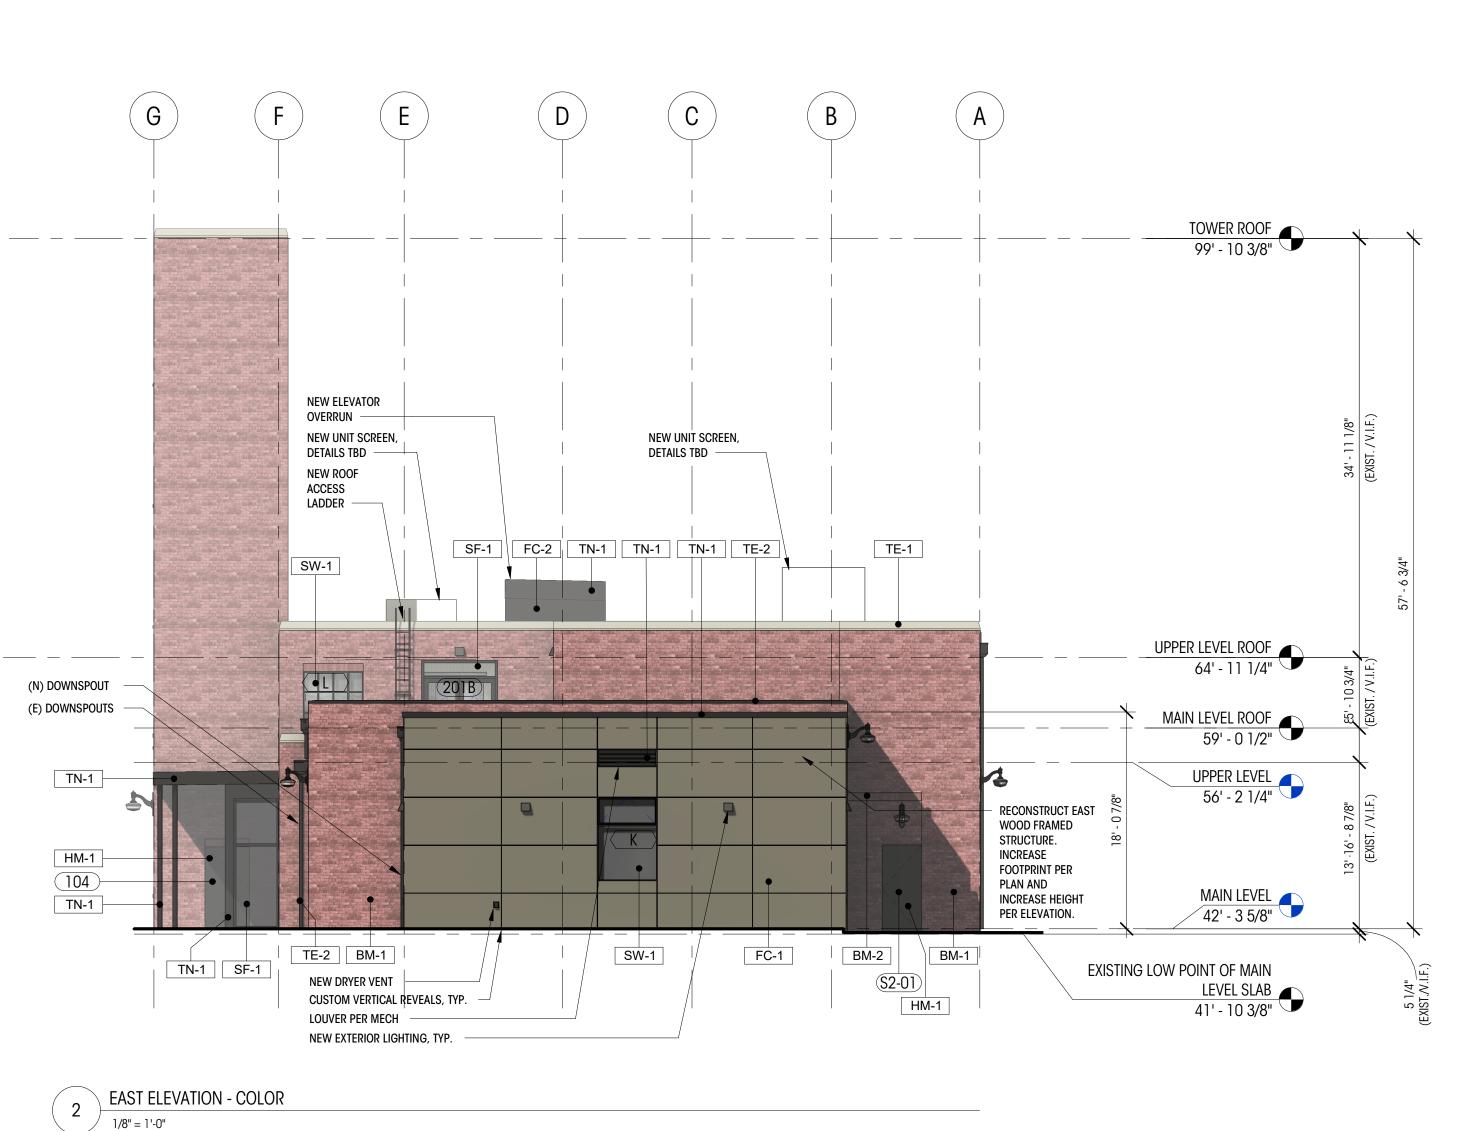

Brandt

Design Group

66 Bell Street Unit 1 Seattle, WA

98121

brandtdesigninc.com

TDOORS FOR ALL H

100% DD SET

DATE: 03/29/21
SHEET SIZE: D (24X36)

REVISIONS


DRAWN BY: DD CHECKED BY: KM

COLOR EXTERIOR ELEVATIONS


ALE: As indicated

A310^{ct}

DEDICATED
APPROVAL

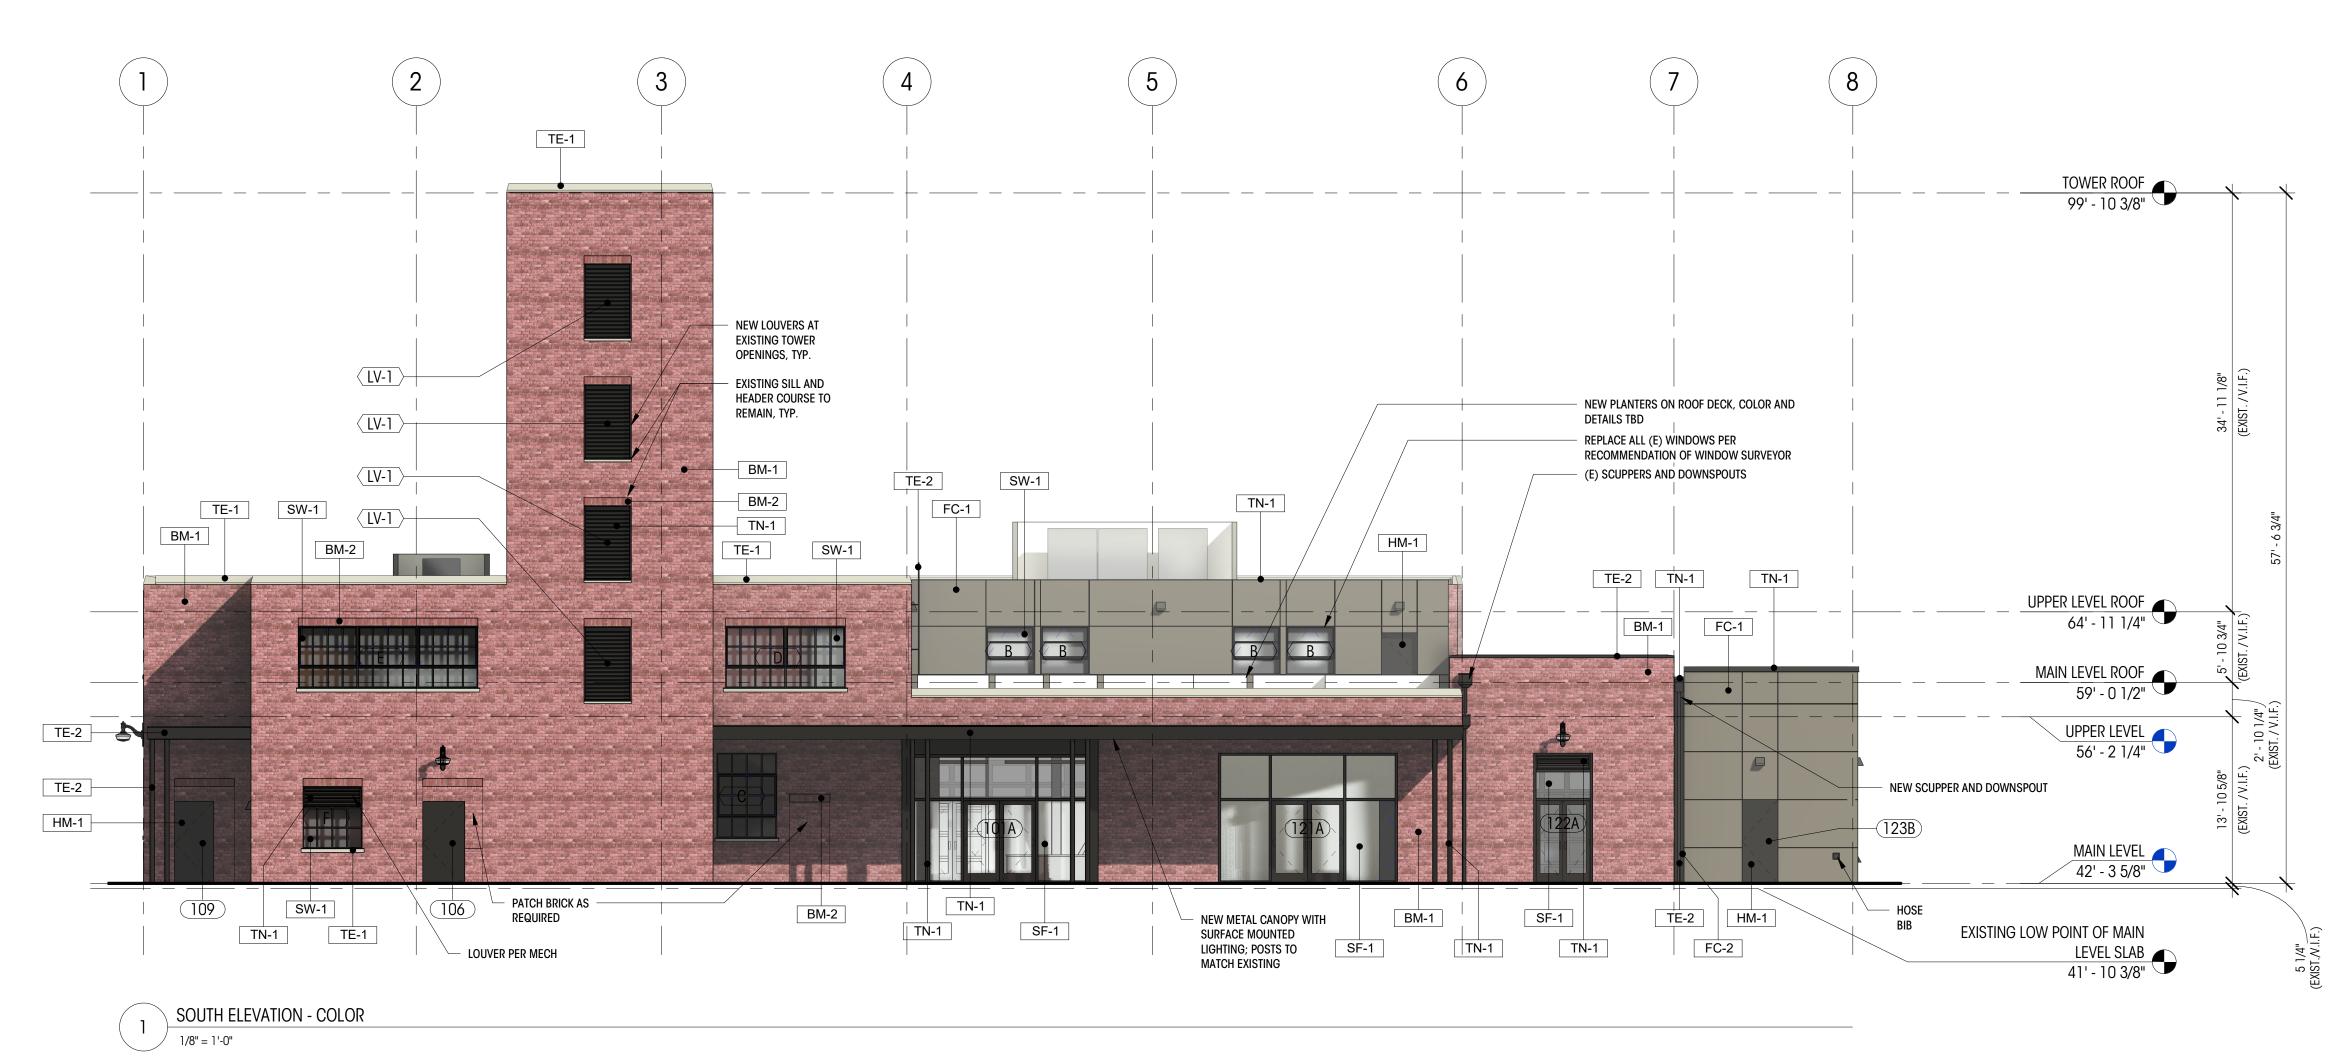

WEST ELEVATION - COLOR

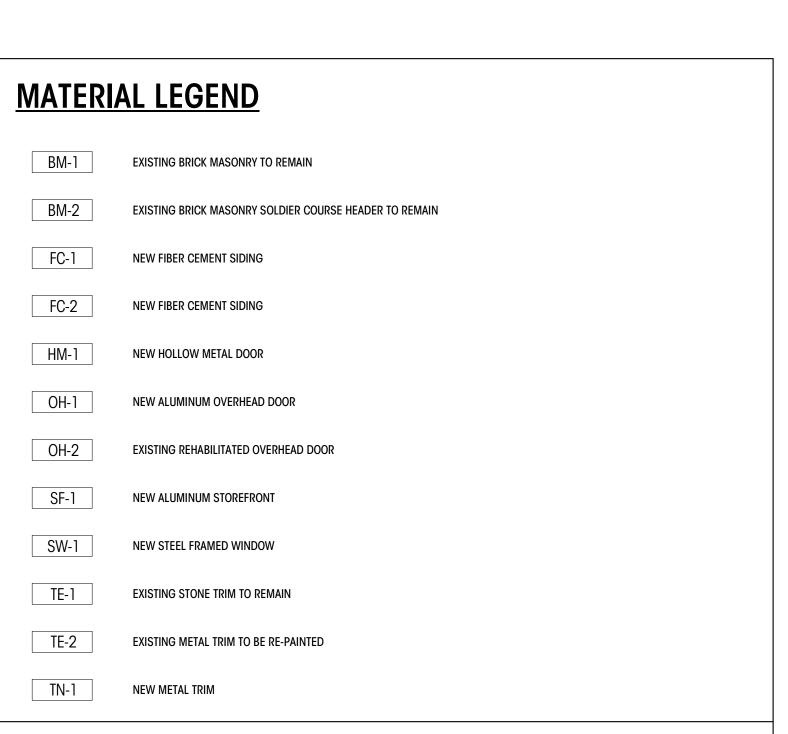


GENERAL ELEVATION NOTES

1. ALL ENVIRONMENTAL AIR EXHAUST OUTLETS SHALL BE A MINIMUM OF 3 FEET FROM OPERABLE OPENINGS INTO THE BUILDING PER SMC 501.3.1.
2. REFER TO SHEETS G004, A600 AND A601 FOR U-VALUE, SHGC, ADDITIONAL ENERGY REQUIREMENTS, INCLUIDING ENERGY EFFICIENCY OPTIONS AND HEATING SYSTEM.

3. JOINTS SHOWN ON ELEVATIONS ARE REVEALS, UNLESS NOTED OTHERWISE OR DETAILED.

4. SEE COLOR ELEVATIONS ON SHEETS A310 AND A311.
5. ALL EXTERIOR MASONRY TO BE INSPECTED AND REPAIRED AS FOLLOWS:

SCRAPE ALL LOOSE AND WEAKENED MORTAR OUT TO FULL DEPTH OF THE DETERIORATION; REMOVE AND REPLACE ALL LOOSE MASONRY UNIT; CHECK FOR LOOSE FACING BRICK VENEERS, TUCK POINT ALL JOINTS SOLID. ALL MASONRY RESTORATION AND REPAIR SHALL BE PERFORMED IN SUCH A MANNER THAT THE EXISTING STRUCTURE IS NOT WEAKENED OR LEFT UNSUPPORTED DURING THE PROCESS OF THE WORK. ALL EXTERIOR APPENDAGES SUCH AS FIRE ESCAPES, CORNICES, AND EYEBROWS SHALL BE INSPECTED FOR STRUCTURAL INTEGRITY AND THE CONDITION OF THE CONNECTIONS TO THE STRUCTURE. CONTRACTOR TO PROVIDE THE STRUCTRUAL ENGINEER WITH THE RESULTS OF THE INSPECTION.

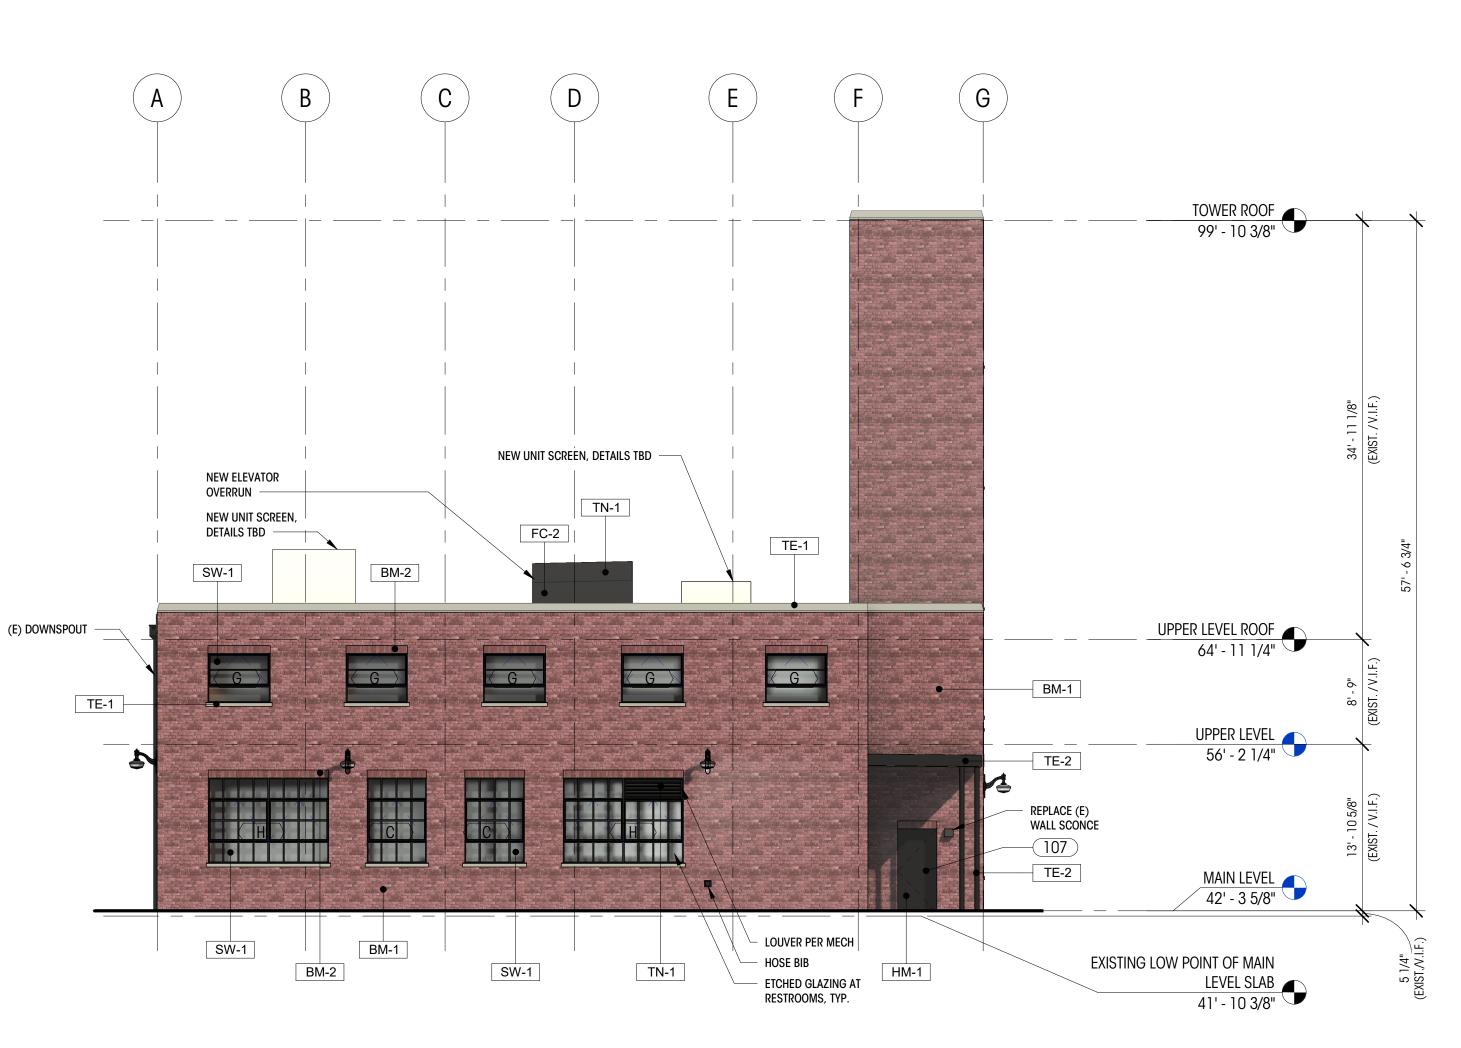

Brandt

Design Group

66 Bell Street Unit 1 Seattle, WA

98121

206.239.0850

brandtdesigninc.com

UTDOORS FOR ALL 15 NE 74th St Seattle 98115

1000/ DD 0E1

100% DD SET

DATE: 03/29/21

REVISIONS
NO: DATE:

DRAWN BY: DD

CHECKED BY: KM

COLOR EXTERIOR

ELEVATIONS

CALE: As indicated



DEDICATED APPROVAL STAMP SPACE


	R SCHEDULE													
LAN ID	ROOM	DOOR TYPE	DOOR FINISH	FRAME TYPE	FRAME FINISH	WIDTH (ft.)	HEIGHT (ff.)	AREA (sf.)	U VALUE	UA	CLOSER	PANIC HW	CARD READER	NOTES
1014	VESTIBULE	•				41 OII	41 10 2/411	41 CE						
101A		C				6' - 0"	6' - 10 3/4"	41 SF			•	•	•	2
101B	VESTIBULE CTOPAGE	C				6' - 0"	6' - 10 3/4"	41 SF			•	•		2
104	UNCONDITIONED STORAGE	A				3' - 8"	7' - 0"	26 SF						
105	SENSORY	В				3' - 0"	6' - 10"	21 SF						2
106	ELEV. MACHINE	A				3' - 6"	7' - 0"	25 SF						
107	MECHANICAL / SPRINKLER RISER	A				3' - 3"	7' - 0"	23 SF						
108	RESTROOM	A				3' - 0"	7' - 0"	21 SF			•			
109	ELECTRICAL	A				3' - 3"	7' - 0"	23 SF			_			
110	RESTROOM	A				3' - 0"	7' - 0"	21 SF			•			
111A	EXERCISE ROOM 1	С				5' - 7"	7' - 0"	39 SF						2
111B	EXERCISE ROOM 1	Н				19' - 1 1/4"	10' - 3 1/4"	196 SF						1/2
112A	EXERCISE ROOM 2	С				5' - 7"	7' - 0"	39 SF						2
112B	EXERCISE ROOM 2	Н				19' - 1 1/4"	10' - 3 1/4"	196 SF						1/2
113A	EXERCISE ROOM 3	В				3' - 0"	7' - 0"	21 SF			•			2
113B	EXERCISE ROOM 3	Н				19' - 1 1/4"	10' - 3 1/4"	196 SF						1/2
115A	EXERCISE ROOM 4	С				5' - 7"	6' - 11 7/8"	39 SF						2
115B	EXERCISE ROOM 4	Н				19' - 1 1/4"	10' - 3 1/4"	196 SF						1/2
116A	EXERCISE ROOM 5	С				5' - 7"	6' - 11 7/8"	39 SF						2
116B	EXERCISE ROOM 5	G				22' - 1 3/4"	10' - 3 1/4"	227 SF						1/2
117	STORAGE	D				6' - 0"	6' - 8"	40 SF						
119	STORAGE	Α				3' - 0"	7' - 0"	21 SF						
120	ACC WORKSHOP	E				4' - 0"	7' - 0"	28 SF						2
121A	TRAINING ROOM	С				6' - 0"	6' - 10 3/4"	41 SF						2
121B	TRAINING ROOM	E				4' - 0"	7' - 0"	28 SF						2
122A	ADAPTIVE CYCLING CENTER	С				4' - 6 3/4"	6' - 10 3/4"	31 SF						2
122B	ADAPTIVE CYCLING CENTER	J				13' - 0"	14' - 0"	182 SF						2
123A	LAUNDRY	Α				3' - 6 1/2"	6' - 9 1/8"	24 SF						
123B	LAUNDRY	Α				3' - 0"	7' - 0"	21 SF						
201A	BREAK ROOM	E				4' - 0"	7' - 0"	28 SF						2
201B	BREAK ROOM	C				5' - 11"	6' - 11 3/4"	41 SF					•	2
202	WORKSPACE	C				6' - 0"	6' - 8"	40 SF						2
203	STORAGE	A				3' - 0"	7' - 0"	21 SF						
204	TELE / DATA	A				3' - 0"	7' - 0"	21 SF						
205	PRIVACY ROOM	A				3' - 0"	7' - 0"	21 SF						
206	RESTROOM	A				3' - 0"	7'-0"	21 SF			•			
207	RESTROOM	A				3' - 0"	7 - 0"	21 SF			•			
208	OPEN OFFICE	F				8' - 2"	7 - 0"	57 SF					•	
209	SMALL OFFICE	В				3' - 0"	7 - 0"	21 SF					_	2
209 210	SMALL OFFICE	В				3' - 0"	7 - 0"	21 SF						2
	STORAGE					3' - 0"	7 - 0"	21 SF 21 SF						
211		A					-							
212	STORAGE	D				5' - 6"	6' - 8"	37 SF						
213	LARGE OFFICE	В				3' - 0"	7' - 0"	21 SF						2
214	LARGE OFFICE	В				3' - 0"	7' - 0"	21 SF						2
215	ROOF DECK	A				3' - 0"	7' - 0"	21 SF					•	
32-01	STAIR 2	Α				3' - 3"	7' - 5 1/4"	24 SF			•	•		
2-02	STAIR 2	Α				3' - 0"	7' - 0"	21 SF			•	•		


GENERAL DOOR NOTES:

- ALL DIMENSIONS SHOWN ARE FINISHED DIMENSIONS, R.O. PER CONTRACTOR.
- CONTRACTOR TO VERIFY ALL SIZES AND DIMENSIONS IN FIELD WITH ARCHITECT BEFORE ORDERING.
- ALL NEW DOORS TO BE NFRC CERTIFIED
- REFER TO SHEET GOO4 FOR U-FACTOR & SHGC REQUIREMENTS FOR EXTERIOR ENVELOPE DOORS. UNO OPAQUE DOORS TO MEET SEATTLE ENERGY CODE MIN. U-VALUES PER SEC C402.3.1 & C402.2.7 & TABLE C402.2. SWINGING
- DOORS WITH LESS THAN 50% GLASS AREA TO BE MIN. U-0.37.
- UNO GLAZING IN EXTERIOR ENVELOPE DOORS THAT EXCEED 50% OF THE DOOR AREA ARE TO MEET MIN. GLAZING U-VALUES & SHGC FACTORS FOR SEATTLE ENERGY CODE FENESTRATION C402.3. REFER TO THE ENERGY SHEET G004.
- REFER TO PLANS AND TAGS FOR LOCATION AND OPERATION.
- ALL ELEVATIONS ARE FROM THE EXTERIOR. SILL, JAMB AND HEAD DETAILS ON SHEET A720.
- ALL DOORS TO BE SOLID-CORE WOOD VENEER FLAT PANELS UNO
- TEMPERED GLASS / SAFETY GLAZING AS REQUIRED AT ALL DOORS PER SBC 2406

SPECIFIC NOTES

- 1. MOTOR ASSUMED TO BE MOUNTED IN CENTER MOUNT / JACKSHAFT ORIENTATION AND TYPE RSX OR RHX PER
- 2. "*" DENOTES SAFTEY GLAZING ON ELEVATIONS (ALL DOORS TO BE LABELED)

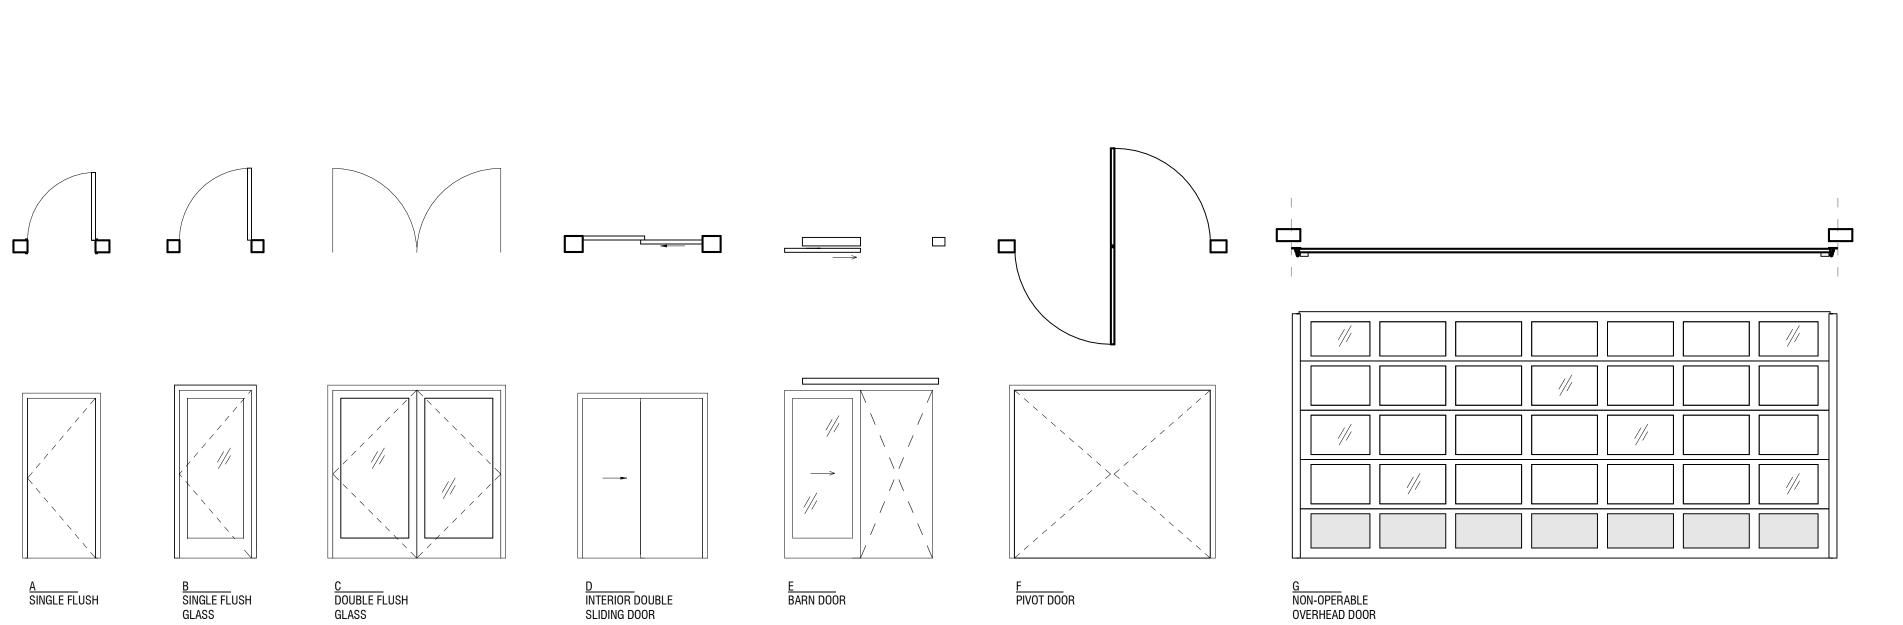

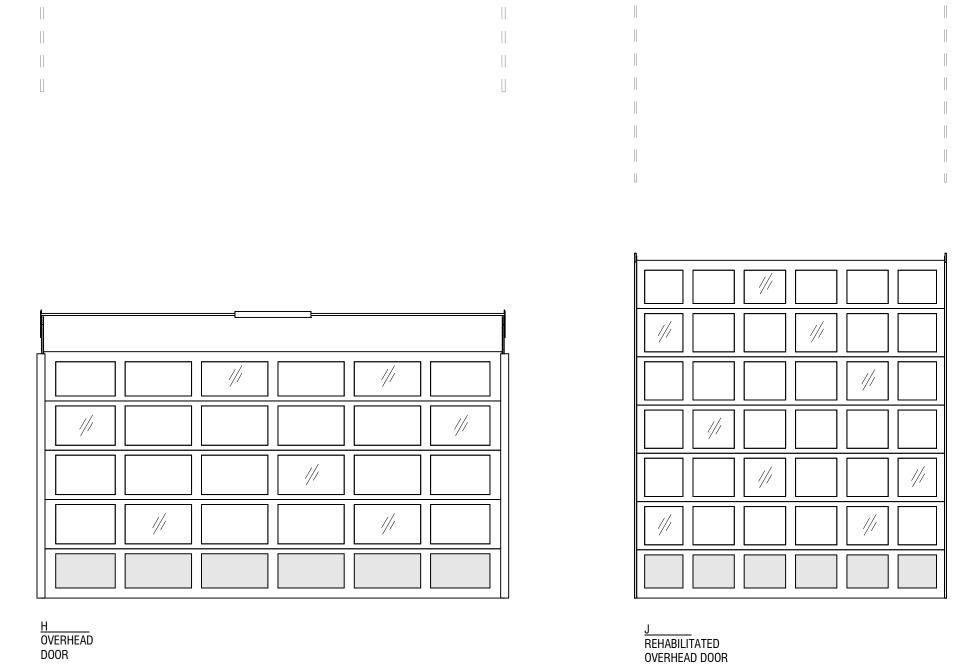

Design Group

66 Bell Street Unit 1 Seattle, WA 98121

206.239.0850

brandtdesigninc.com

100% DD SET

DATE: 03/29/21 SHEET SIZE: D (24X36) REVISIONS NO: DATE

CHECKED BY: KM

DRAWN BY: DD

DOOR SCHEDULE


1/4" = 1'-0"





<u>VIND</u>	<u>ow sc</u>	HEDU	<u>LE</u>			
				UNIT AREA		
PLAN ID	TYPE	WIDTH (ft)	HEIGHT (ft)	(sf)	U VALUE	UA
В	В	4' - 1"	4' - 1"	17 SF		
С	В Е	4' - 11 3/4"	7' - 1"	35 SF		
D	F	10' - 0"	5' - 2"	52 SF		
E	J	15' - 0"	5' - 2"	78 SF		
F	D	4' - 11 3/4"	5' - 2"	26 SF		
G	В	5' - 2"	4' - 1"	21 SF		
Н		10' - 0"	7' - 1"	71 SF		
I	В	4' - 3 3/4"	4' - 1"	18 SF		
J	В	4' - 4"	4' - 1"	18 SF		
K	Α	5' - 0"	7' - 0"	35 SF		
L	С	5' - 0"	5' - 2"	26 SF		
LV-1	M	4' - 0"	6' - 2"	25 SF		
LV-2	M	5' - 0"	1' - 6"	8 SF		
0	K	3' - 0"	6' - 0"	18 SF		
Р	K	9' - 0"	2' - 0"	18 SF		
Q	K	7' - 0"	2' - 0"	14 SF		
R	Е	5' - 0 3/4"	7' - 1"	36 SF		
SL-1	L	6' - 0"	4' - 0"	24 SF		


GENERAL WINDOW NOTES:

- ALL DIMENSIONS SHOWN ARE FINISHED DIMENSIONS, R.O. PER CONTRACTOR. CONTRACTOR TO VERIFY ALL SIZES AND DIMENSIONS IN FIELD WITH ARCHITECT BEFORE
- ALL NEW WINDOWS TO BE NFRC CERTIFIED.
- REFER TO SHEET GOO4 FOR NFRC U FACTOR AND SHGC VALUES. REFER TO PLANS AND TAGS FOR LOCATION AND OPERATION.
- ALL ELEVATIONS ARE FROM THE EXTERIOR.
- SILL, JAMB AND HEAD DETAILS ON SHEET A721.
- PROVIDE ETCHED PRIVACY GLAZING AT RESTROOMS PER ELEVATIONS AND SPEC. PER SBC 2406, GLAZING IN AN INDIVIDUAL FIXED OR OPERABLE PANEL NEEDS TO BE
- TEMPERED GLASS / SAFETY GLAZING IN THE FOLLOWING HAZARDOUS LOCATIONS: GLAZING IN DOORS GLAZING ADJACENT TO DOORS WITHIN 24" AND LESS THAN 60" A.F.F
- THE EXPOSED AREA OF AN INDIVIDUAL PANE IS LARGER THAN 9 SF
- THE BOTTOM EDGE OF THE GLAZING IS LESS THAN 18" ABOVE THE FLOOR THE TOP EDGE OF THE GLAZING IS MORE THAN 36 " AVOVE THE FLOOR
- ONE OR MORE WALKING SURFACES ARE WITHING 36", MEASURE HORIZONTALLY IN A STRAIGHT LINE OF THE GLAZING
- GLAZING IN GUARDS AND RAILINGS GLAZING ADJACENT TO STAIRWAYS AND RAMPS
- GLAZING ADJACENT TO THE BOTTOM STAIRWAY LANDING " * " DENOTES SAFTEY GLAZING ON ELEVATIONS (EXACT LOCATIONS TBD)

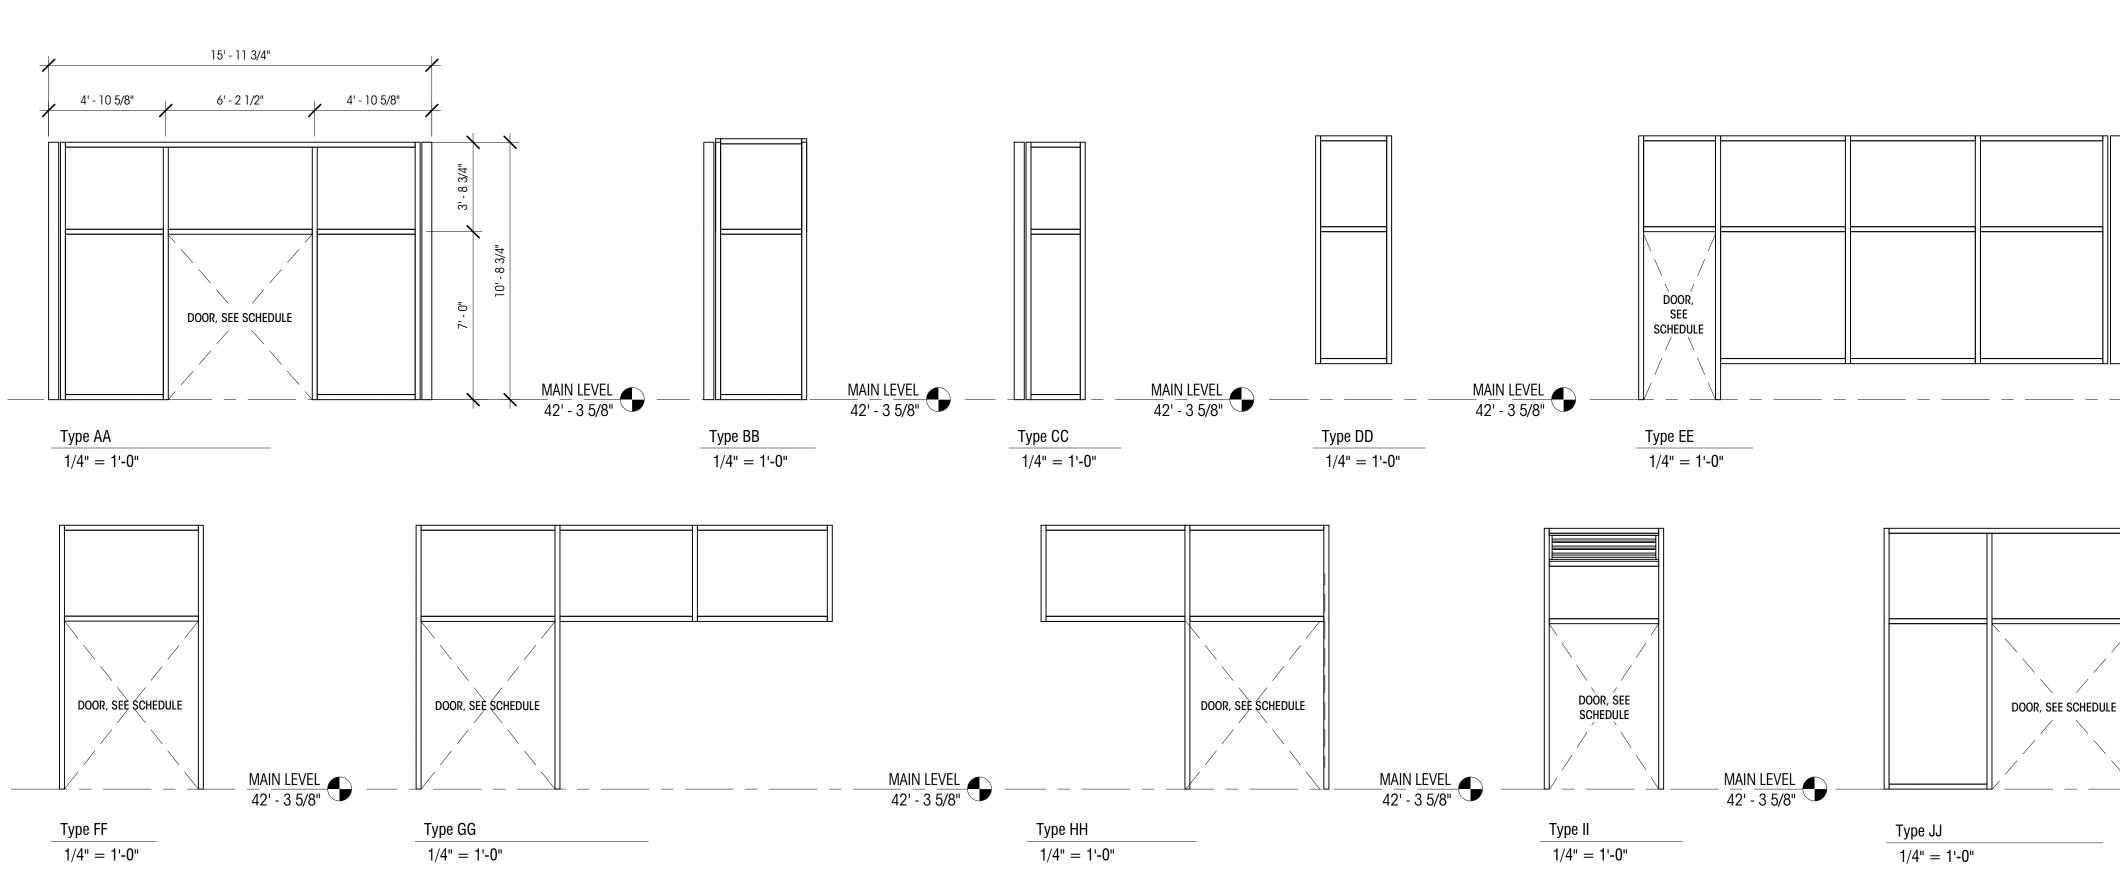

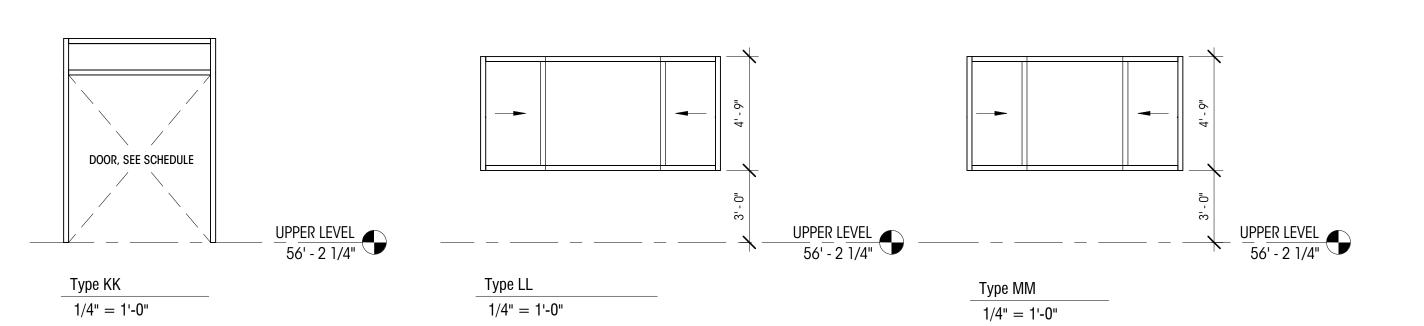

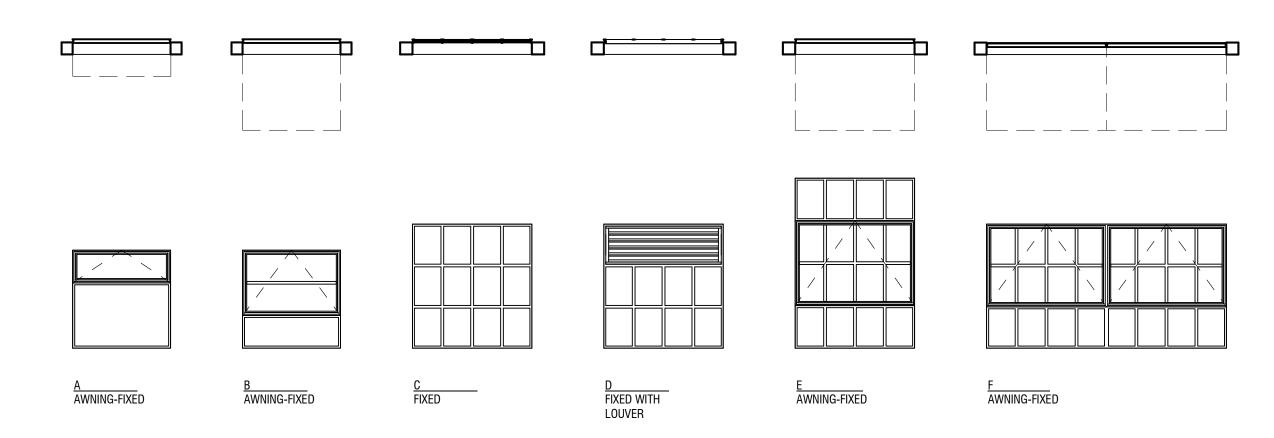

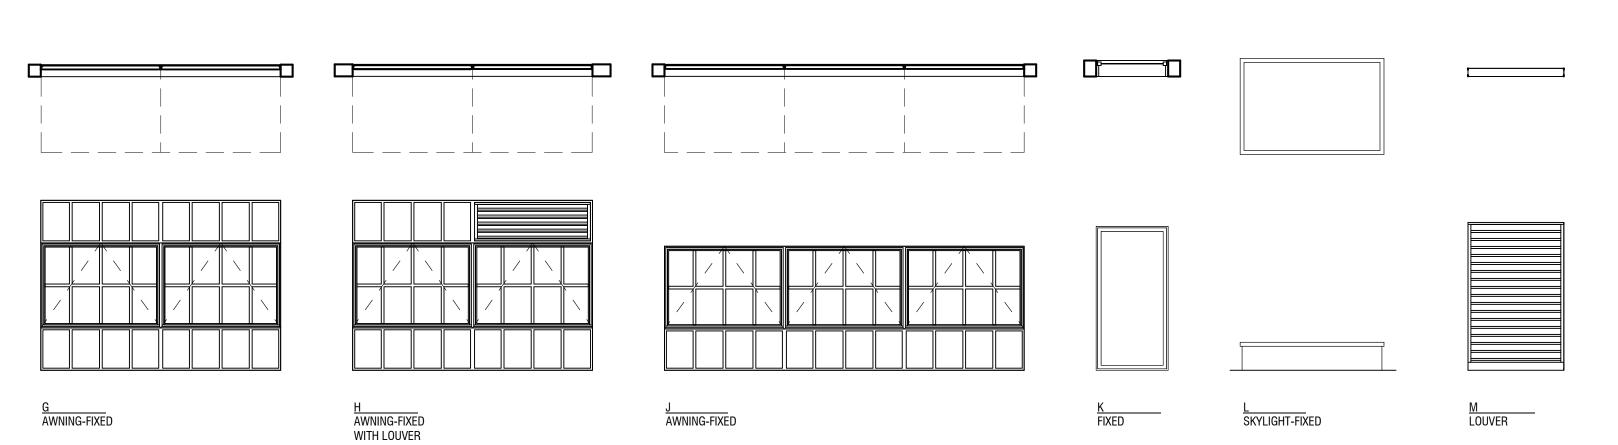

Brandt

Design Group

66 Bell Street Unit 1 Seattle, WA

98121 206.239.0850

brandtdesigninc.com

MAIN LEVEL 42' - 3 5/8"

MAIN LEVEL 42' - 3 5/8"

DOORS


100% DD SET


DATE: 03/29/21 SHEET SIZE: D (24X36) REVISIONS NO: DATE:

DRAWN BY: DD CHECKED BY: KM

WINDOW SCHEDULE

1/4" = 1'-0"

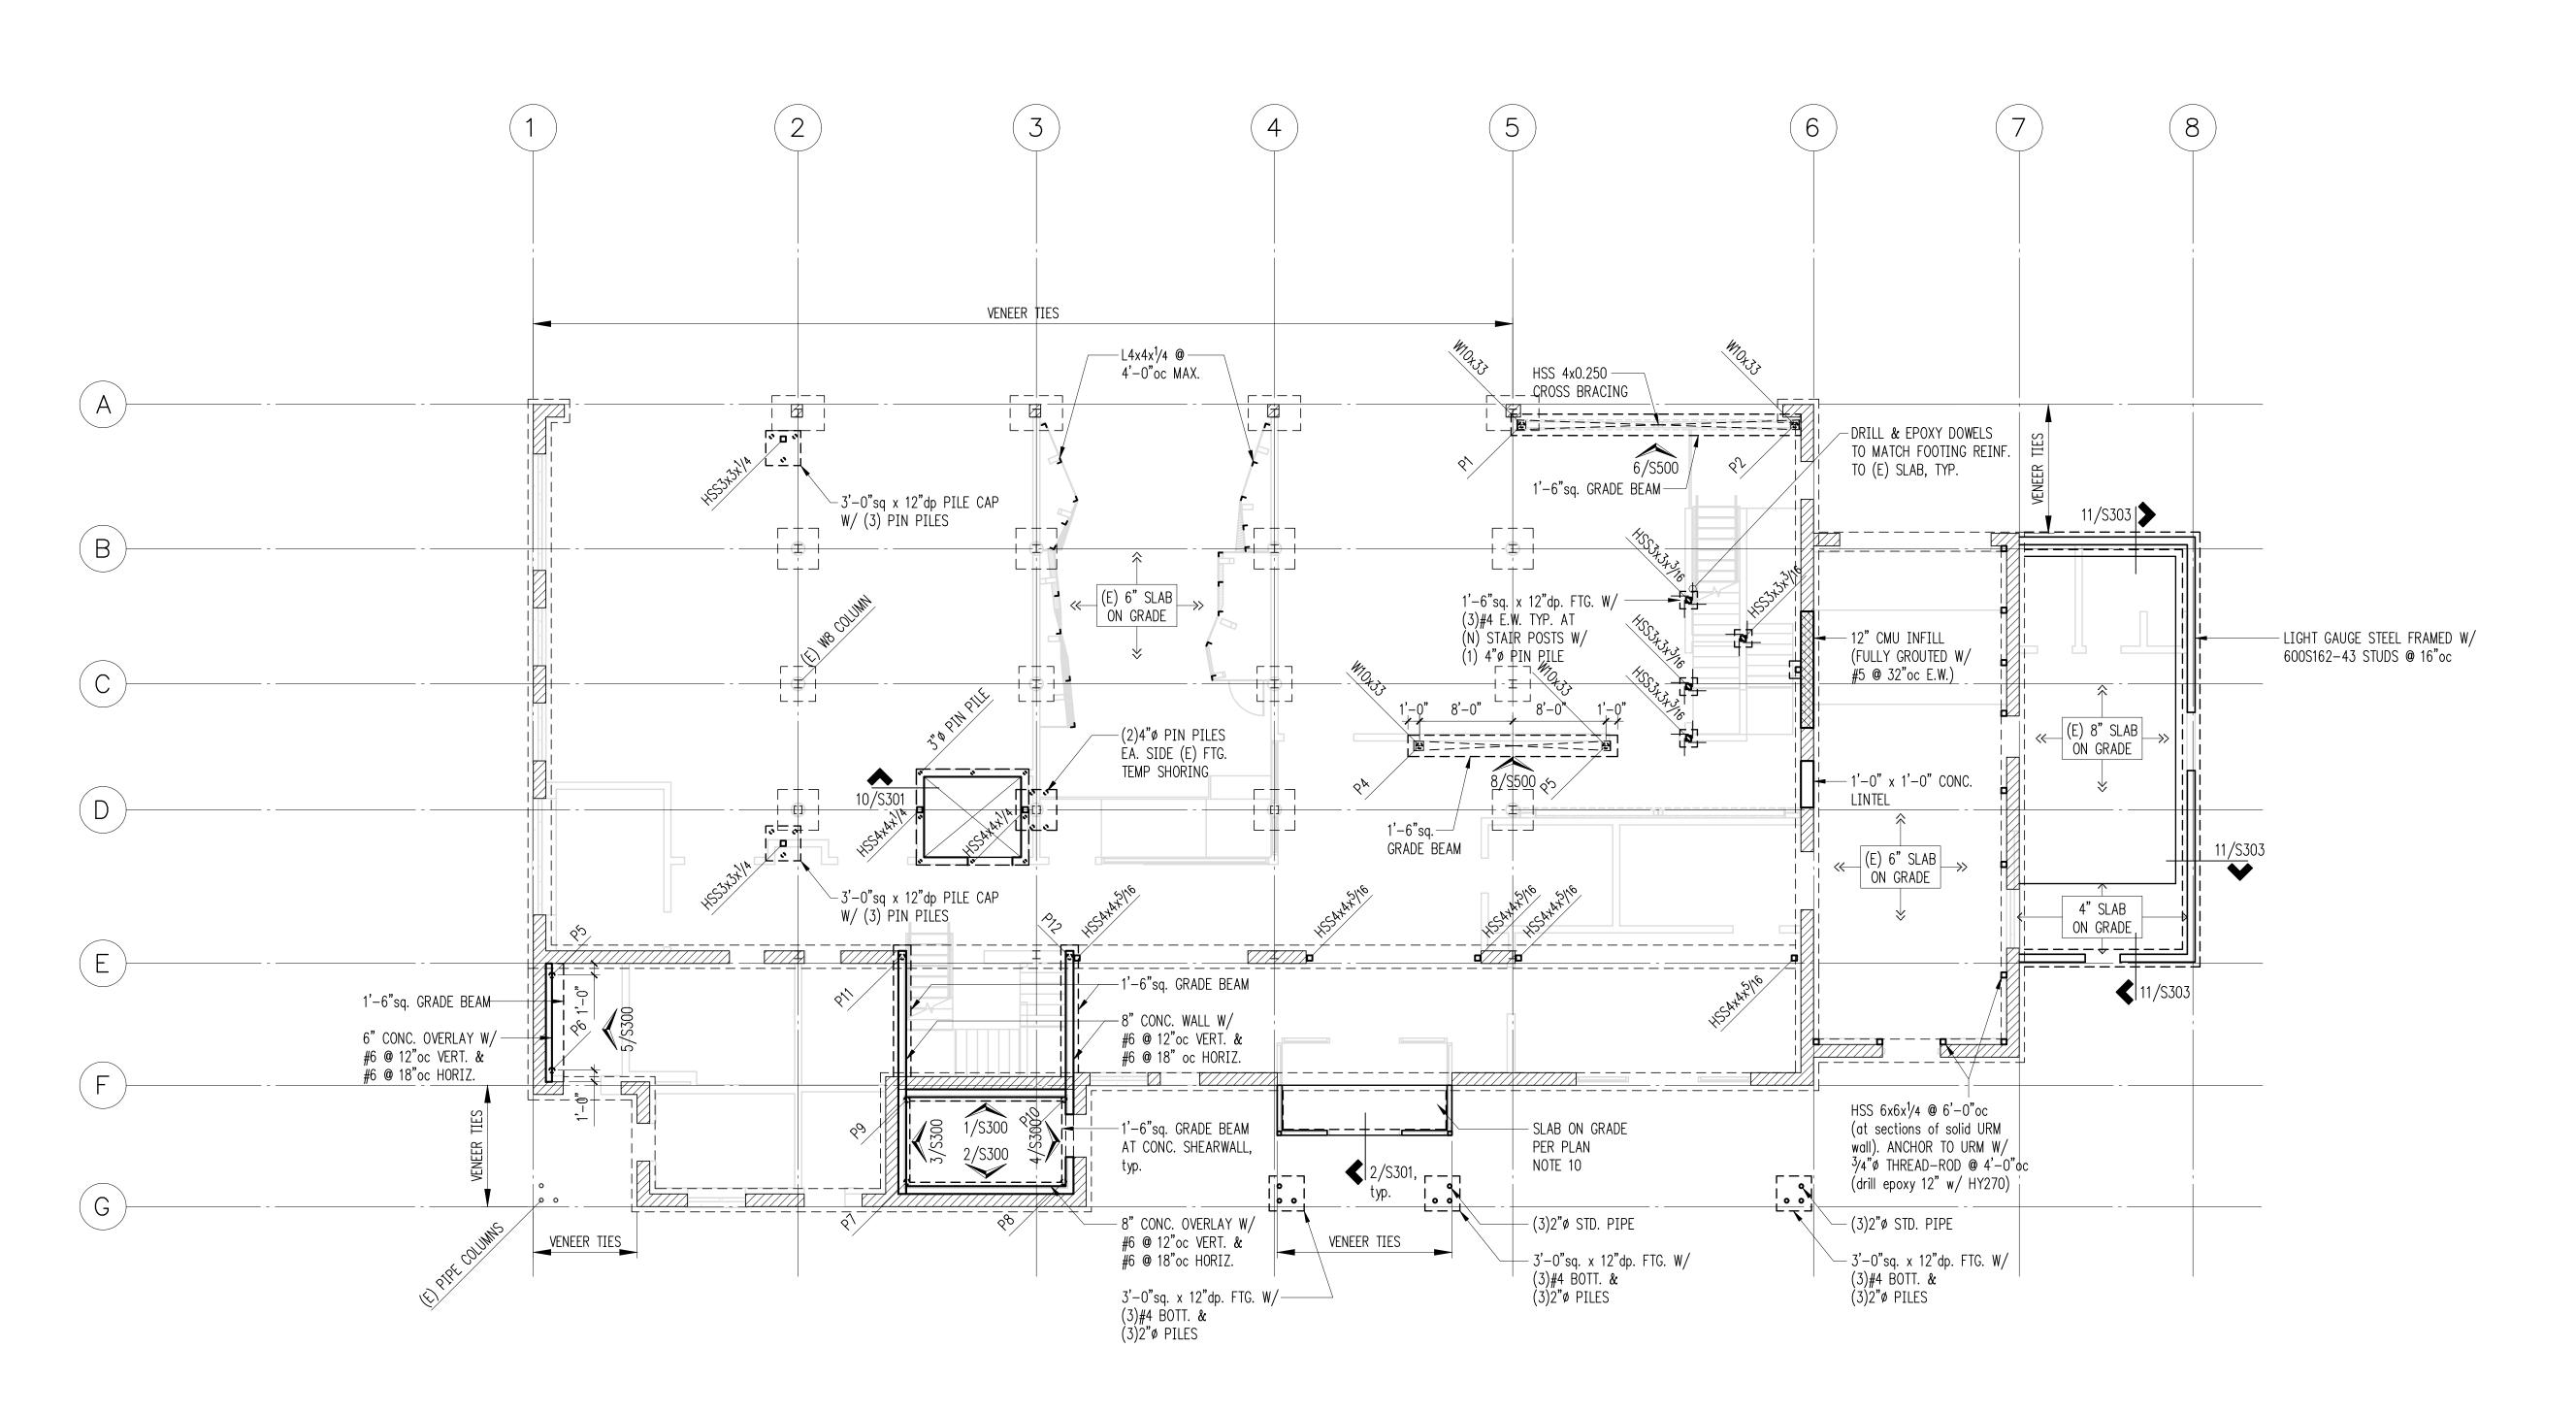

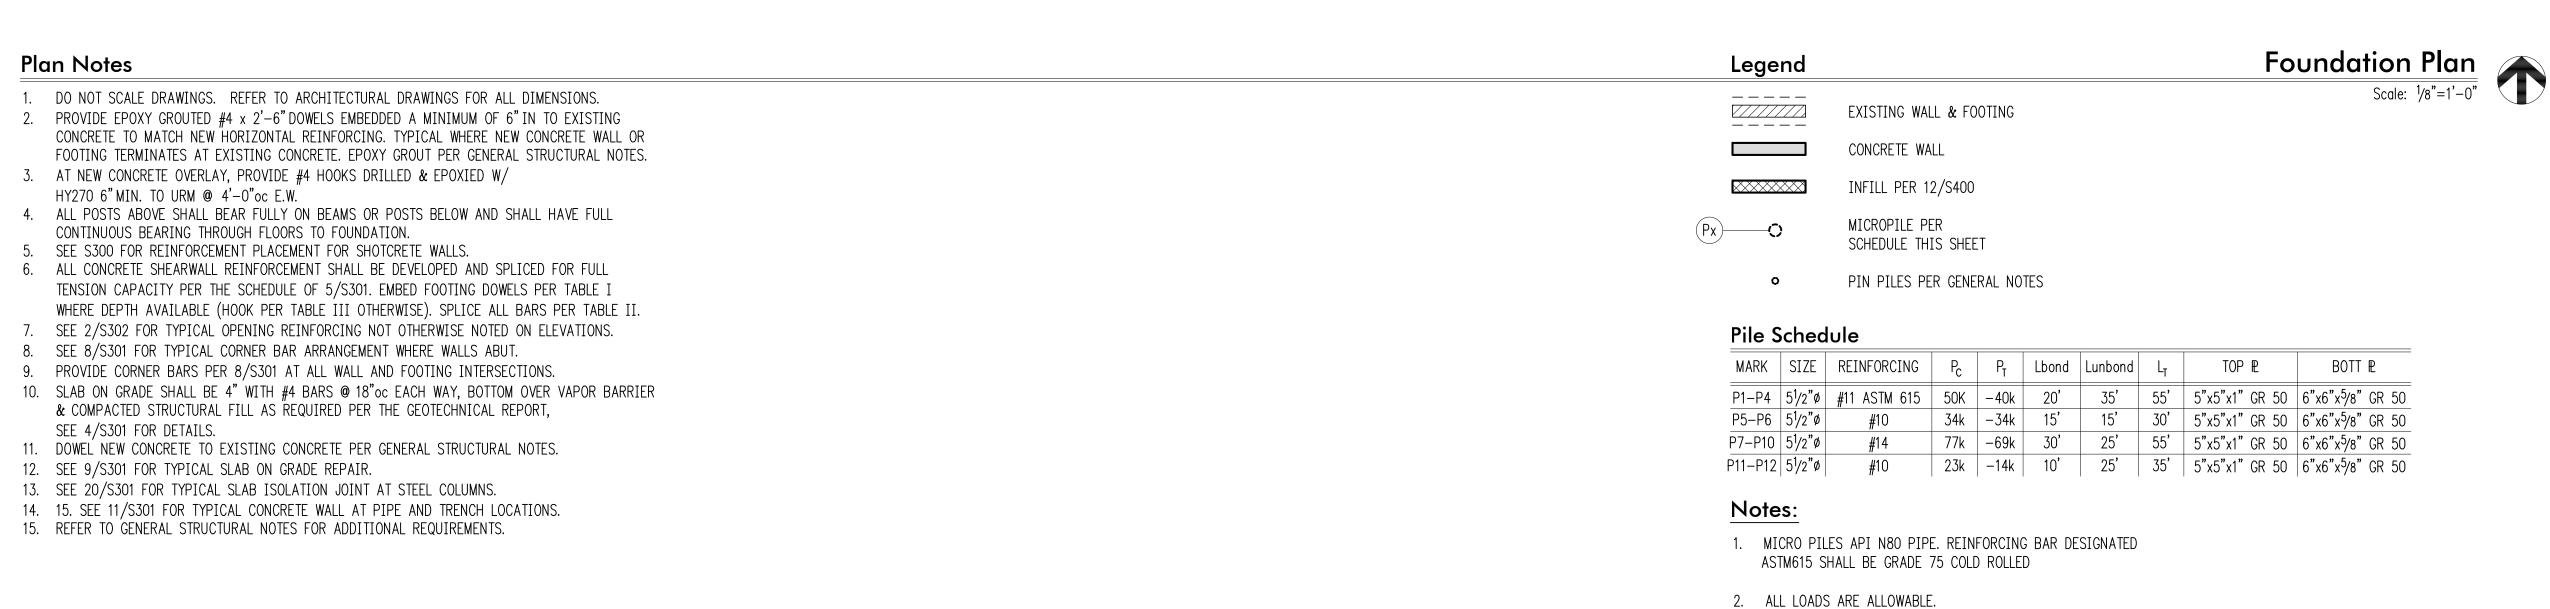

3. SEE 12/S302 FOR TYPICAL MICROPILE DETAIL.



p: 206.443.6212 ssfengineers.com

934 Broadway - Tacoma, WA 98402
p: 253.284.9470 ssfengineers.com

Copyright 2020 Swenson Say Fagét - All Rights Reserved

DRAWN:

SJB/ABH

DESIGN:

FR

CHECKED:

RGC

APPROVED:

DJC

REVISIONS:

JURISDICTIONAL APPROVAL STAMP:

PROJECT TITLE:

Outdoors for All HQ Magnuson Park Building 18 6305 NE 74th St

ARCHITECT:

ARCHITECT:

Brandt Design Group

66 Bell St, Unit 1

Seattle, WA 98121

PH 206.239.0850

Seattle, WA 98115

Progress Set

SHEET TITLE:

Foundation Plan


SCALE: 1/8" = 1'-0"

DATE: March 29, 2021

PROJECT NO:

01519-2020-06 SHEET NO:

5200

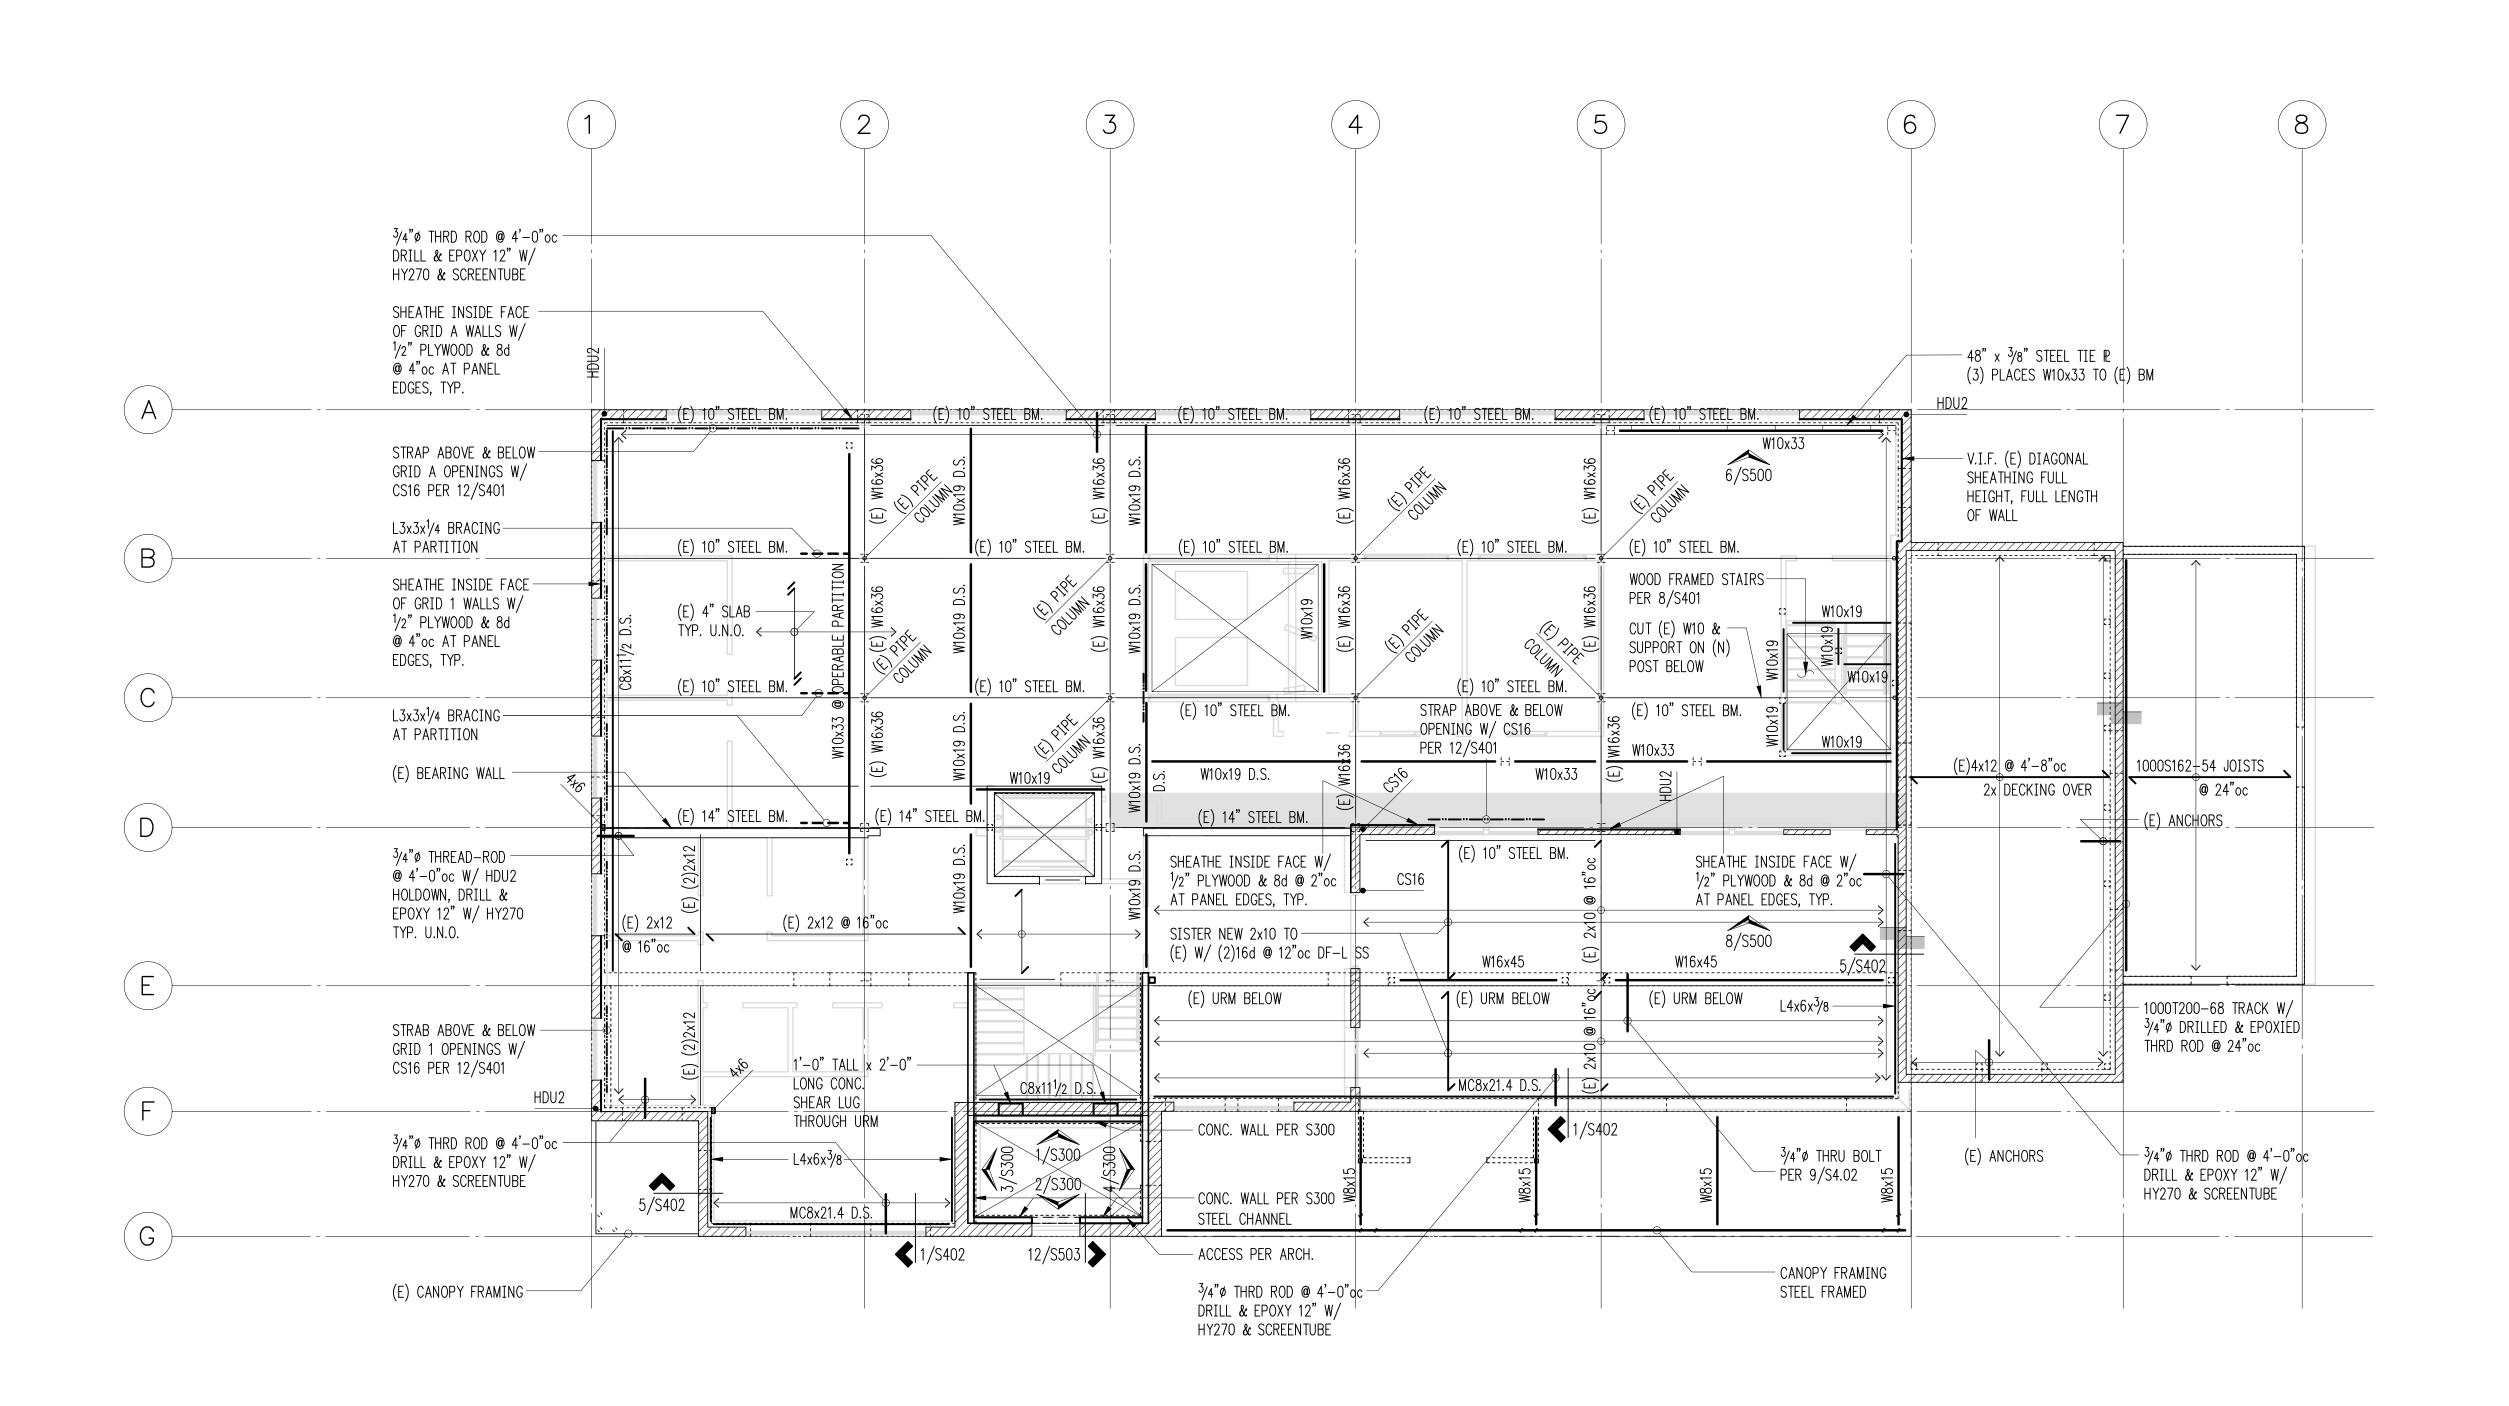

Plan Notes	Legend	Upper Floor Framing Plan Scale: 1/8"=1'-0"
1. DO NOT SCALE DRAWINGS. REFER TO ARCHITECTURAL DRAWINGS FOR ALL DIMENSIONS 2. AT NEW CONCRETE OVERLAY, PROVIDE #4 HOOKS DRILLED & EPOXIED W/	V/////// EXISTING WALL	Scale: 1/8"=1'-0"
HY270 6"MIN. TO URM @ 4'-0"oc E.W. 3. MANUFACTURED LUMBER PRODUCTS (LSL, LVL, PSL, GL) SHALL BE INSTALLED WITH A MOISTURE	[:::::::::::::::::::::::::::::::::::::	BELOW
CONTENT OF 12% OR LESS. THE CONTRACTOR SHALL MAKE PROVISIONS DURING CONSTRUCTION TO PREVENT THE MOISTURE CONTENT OF INSTALLED BEAMS FROM EXCEEDING 12%.	[[[]]][[]] (E) STRUCTURAL V	WALL OR POST BELOW
4. ALL POSTS ABOVE SHALL BEAR FULLY ON BEAMS OR POSTS BELOW AND SHALL HAVE FULL CONTINUOUS BEARING THROUGH FLOORS TO FOUNDATION.	SPAN DIRECTION	
5. SEE S300 FOR REINFORCEMENT PLACEMENT FOR SHOTCRETE WALLS. 6. ALL CONCRETE SHEARWALL REINFORCEMENT SHALL BE DEVELOPED AND SPLICED FOR FULL	← → EXTENT OF JOISTS	
TENSION CAPACITY PER THE SCHEDULE OF 5/S301. EMBED FOOTING DOWELS PER TABLE I WHERE DEPTH AVAILABLE (HOOK PER TABLE III OTHERWISE). SPLICE ALL BARS PER TABLE II.	HEADER/BEAM PER	R PLAN
7. SEE 2S/302 FOR TYPICAL OPENING REINFORCING NOT OTHERWISE NOTED ON ELEVATIONS. 8. SEE 8/S301 FOR TYPICAL CORNER BAR ARRANGEMENT WHERE WALLS ABUT.	———— EXISTING HEADER	/BEAM
9. REFER TO GENERAL STRUCTURAL NOTES FOR ADDITIONAL REQUIREMENTS.		



p: 206.443.6212 ssfengineers.com

934 Broadway - Tacoma, WA 98402
p: 253.284.9470 ssfengineers.com

Copyright 2020 Swenson Say Fagét - All Rights Reserved

DRAWN:

SJB/ABH

DESIGN:
FR

CHECKED:
RGC

APPROVED:
DIS

REVISIONS:

JURISDICTIONAL APPROVAL STAMP:

PROJECT TITLE:

Outdoors for All HQ Magnuson Park Building 18 6305 NE 74th St Seattle, WA 98115

ARCHITECT:

Brandt Design Group 66 Bell St, Unit 1 Seattle, WA 98121 PH 206.239.0850

Progress Set

IEET TITLE:

SHEET NO:


Upper Floor Framing Plan

March 29, 2021

PROJECT NO:

01519-2020-06

S201

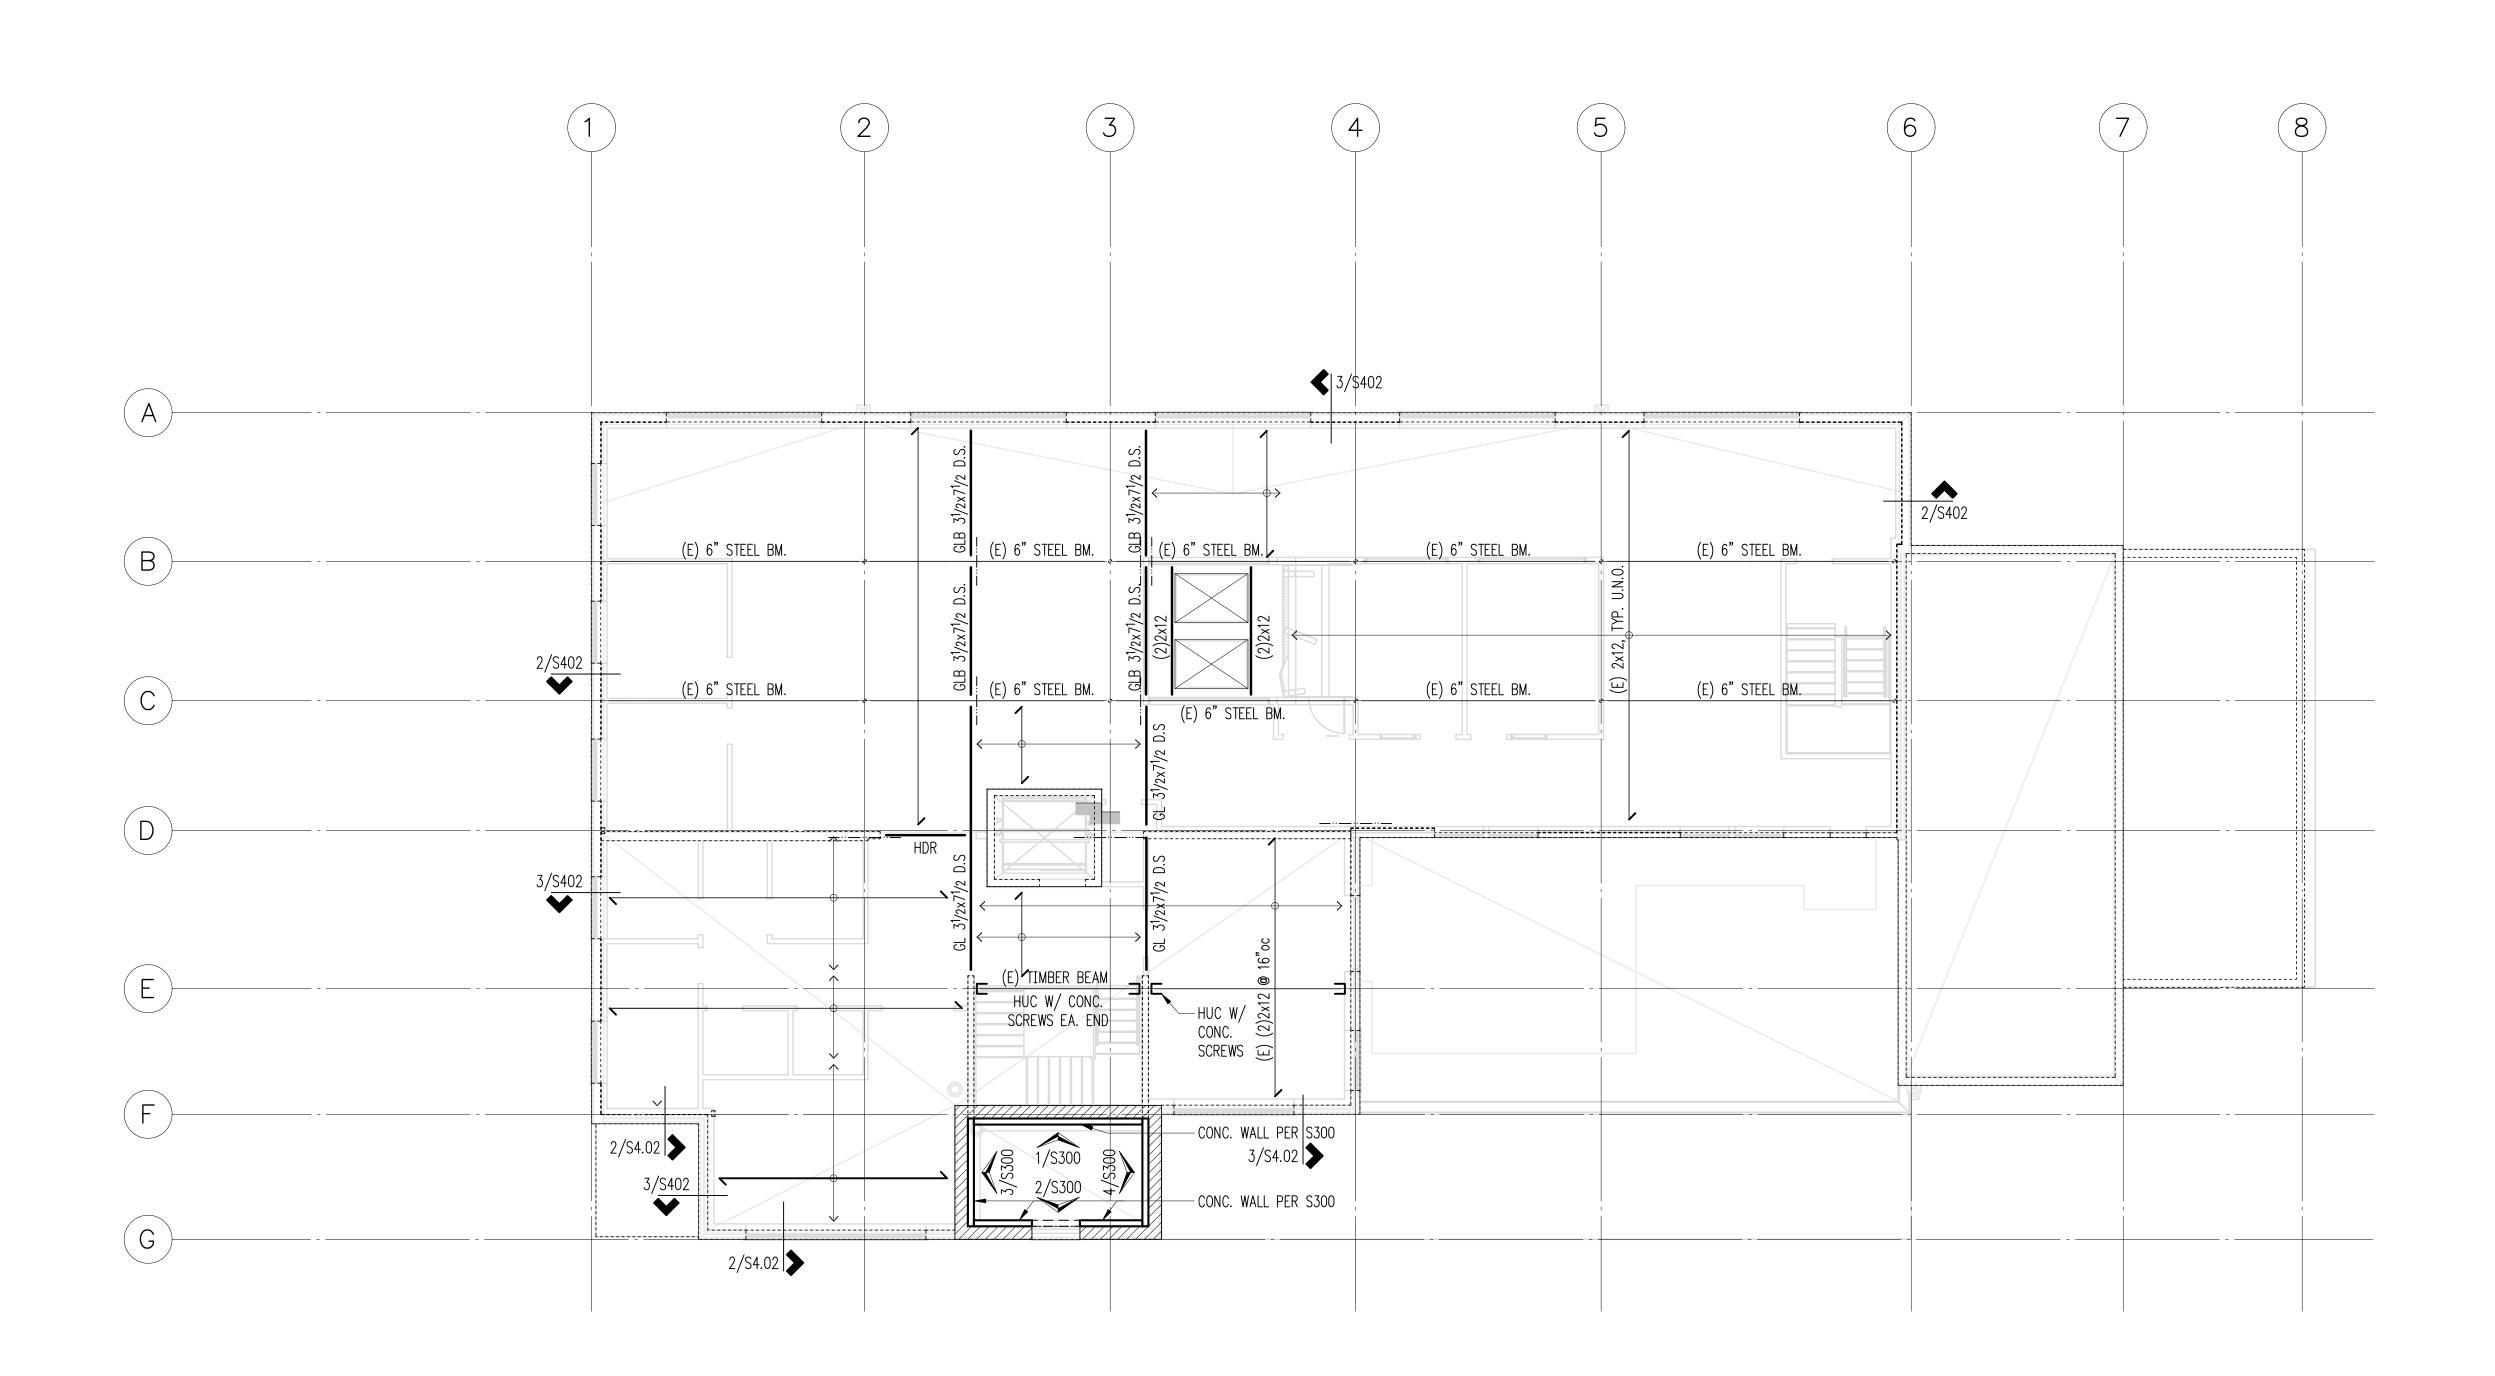

Plan Notes	Legend	Roof Framing Plan
1. DO NOT SCALE DRAWINGS. REFER TO ARCHITECTURAL DRAWINGS FOR ALL DIMENSIONS 2. AT NEW CONCRETE OVERLAY, PROVIDE #4 HOOKS DRILLED & EPOXIED w/	STRUCTURAL WALL BELOW	Scale: 1/8"=1'-0"
HY270 6" MIN. TO URM @ 4'-0"oc E.W. 3. MANUFACTURED LUMBER PRODUCTS (LSL, LVL, PSL, GL) SHALL BE INSTALLED WITH A MOISTURE	[[]][]] (E) STRUCTURAL WALL OR POST BELOW	
CONTENT OF 12% OR LESS. THE CONTRACTOR SHALL MAKE PROVISIONS DURING CONSTRUCTION TO PREVENT THE MOISTURE CONTENT OF INSTALLED BEAMS FROM EXCEEDING 12%.	SPAN DIRECTION	
4. ALL POSTS ABOVE SHALL BEAR FULLY ON BEAMS OR POSTS BELOW AND SHALL HAVE FULL CONTINUOUS BEARING THROUGH FLOORS TO FOUNDATION.	\longleftrightarrow EXTENT OF JOISTS	
5. SEE S300 FOR REINFORCEMENT PLACEMENT FOR SHOTCRETE WALLS. 6. ALL CONCRETE SHEARWALL REINFORCEMENT SHALL BE DEVELOPED AND SPLICED FOR FULL	HEADER/BEAM PER PLAN	
TENSION CAPACITY PER THE SCHEDULE OF 5/S301. EMBED FOOTING DOWELS PER TABLE I WHERE DEPTH AVAILABLE (HOOK PER TABLE III OTHERWISE). SPLICE ALL BARS PER TABLE II.	———— EXISTING HEADER/BEAM	
7 SEE 28/302 FOR TYPICAL OPENING REINFORCING NOT OTHERWISE NOTED ON FLEVATIONS		

8. SEE 8/S301 FOR TYPICAL CORNER BAR ARRANGEMENT WHERE WALLS ABUT.

9. PROVIDE CORNER BARS PER 8/S301 AT ALL WALL AND FOOTING INTERSECTIONS.
10. REFER TO GENERAL STRUCTURAL NOTES FOR ADDITIONAL REQUIREMENTS.



p: 206.443.6212 ssfengineers.com

934 Broadway - Tacoma, WA 98402
p: 253.284.9470 ssfengineers.com

Copyright 2020 Swenson Say Fagét - All Rights Reserved

DRAWN:

SJB/ABH

DESIGN:

FR

CHECKED:

RGC

APPROVED:

D16

REVISIONS:

JURISDICTIONAL APPROVAL STAMP:

PROJECT TITLE:

Outdoors for All HQ Magnuson Park Building 18 6305 NE 74th St Seattle, WA 98115

ARCHITE

Brandt Design Group 66 Bell St, Unit 1 Seattle, WA 98121 PH 206.239.0850

Progress Set

IEET TITI E:

Roof Framing Plan


March 29, 2021


PROJECT NO:

01519-2020-06

_ _ _

S202

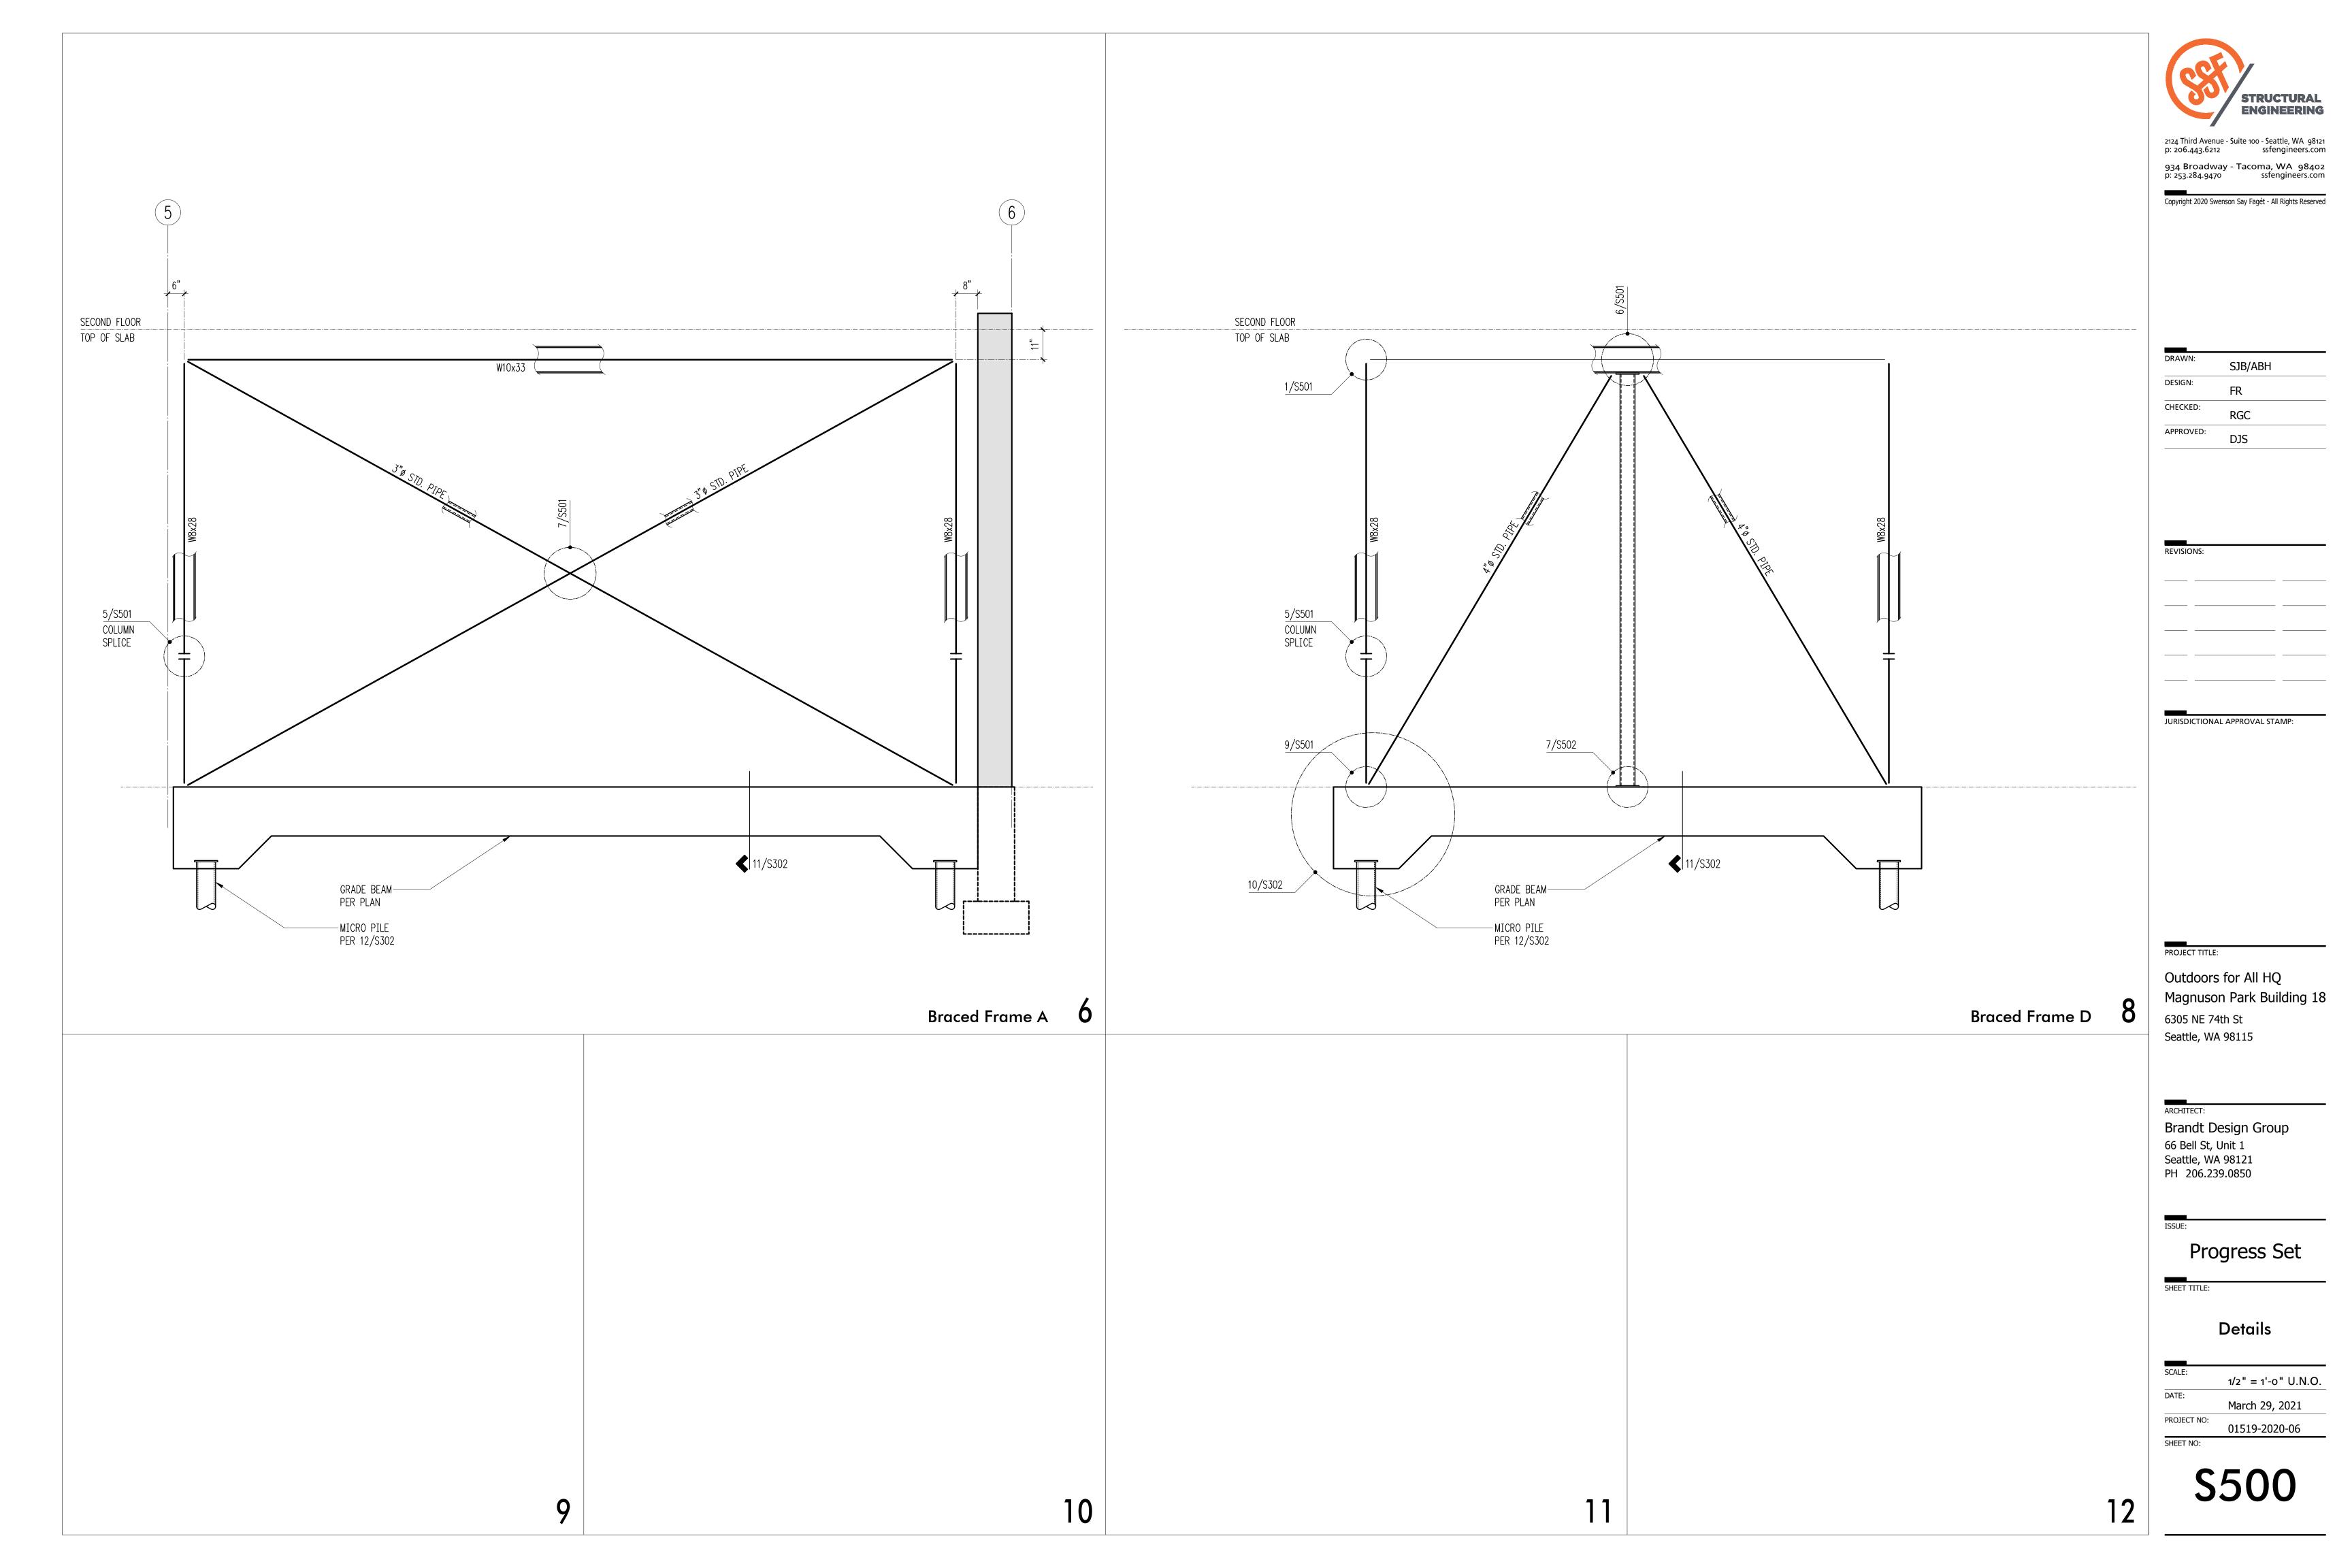

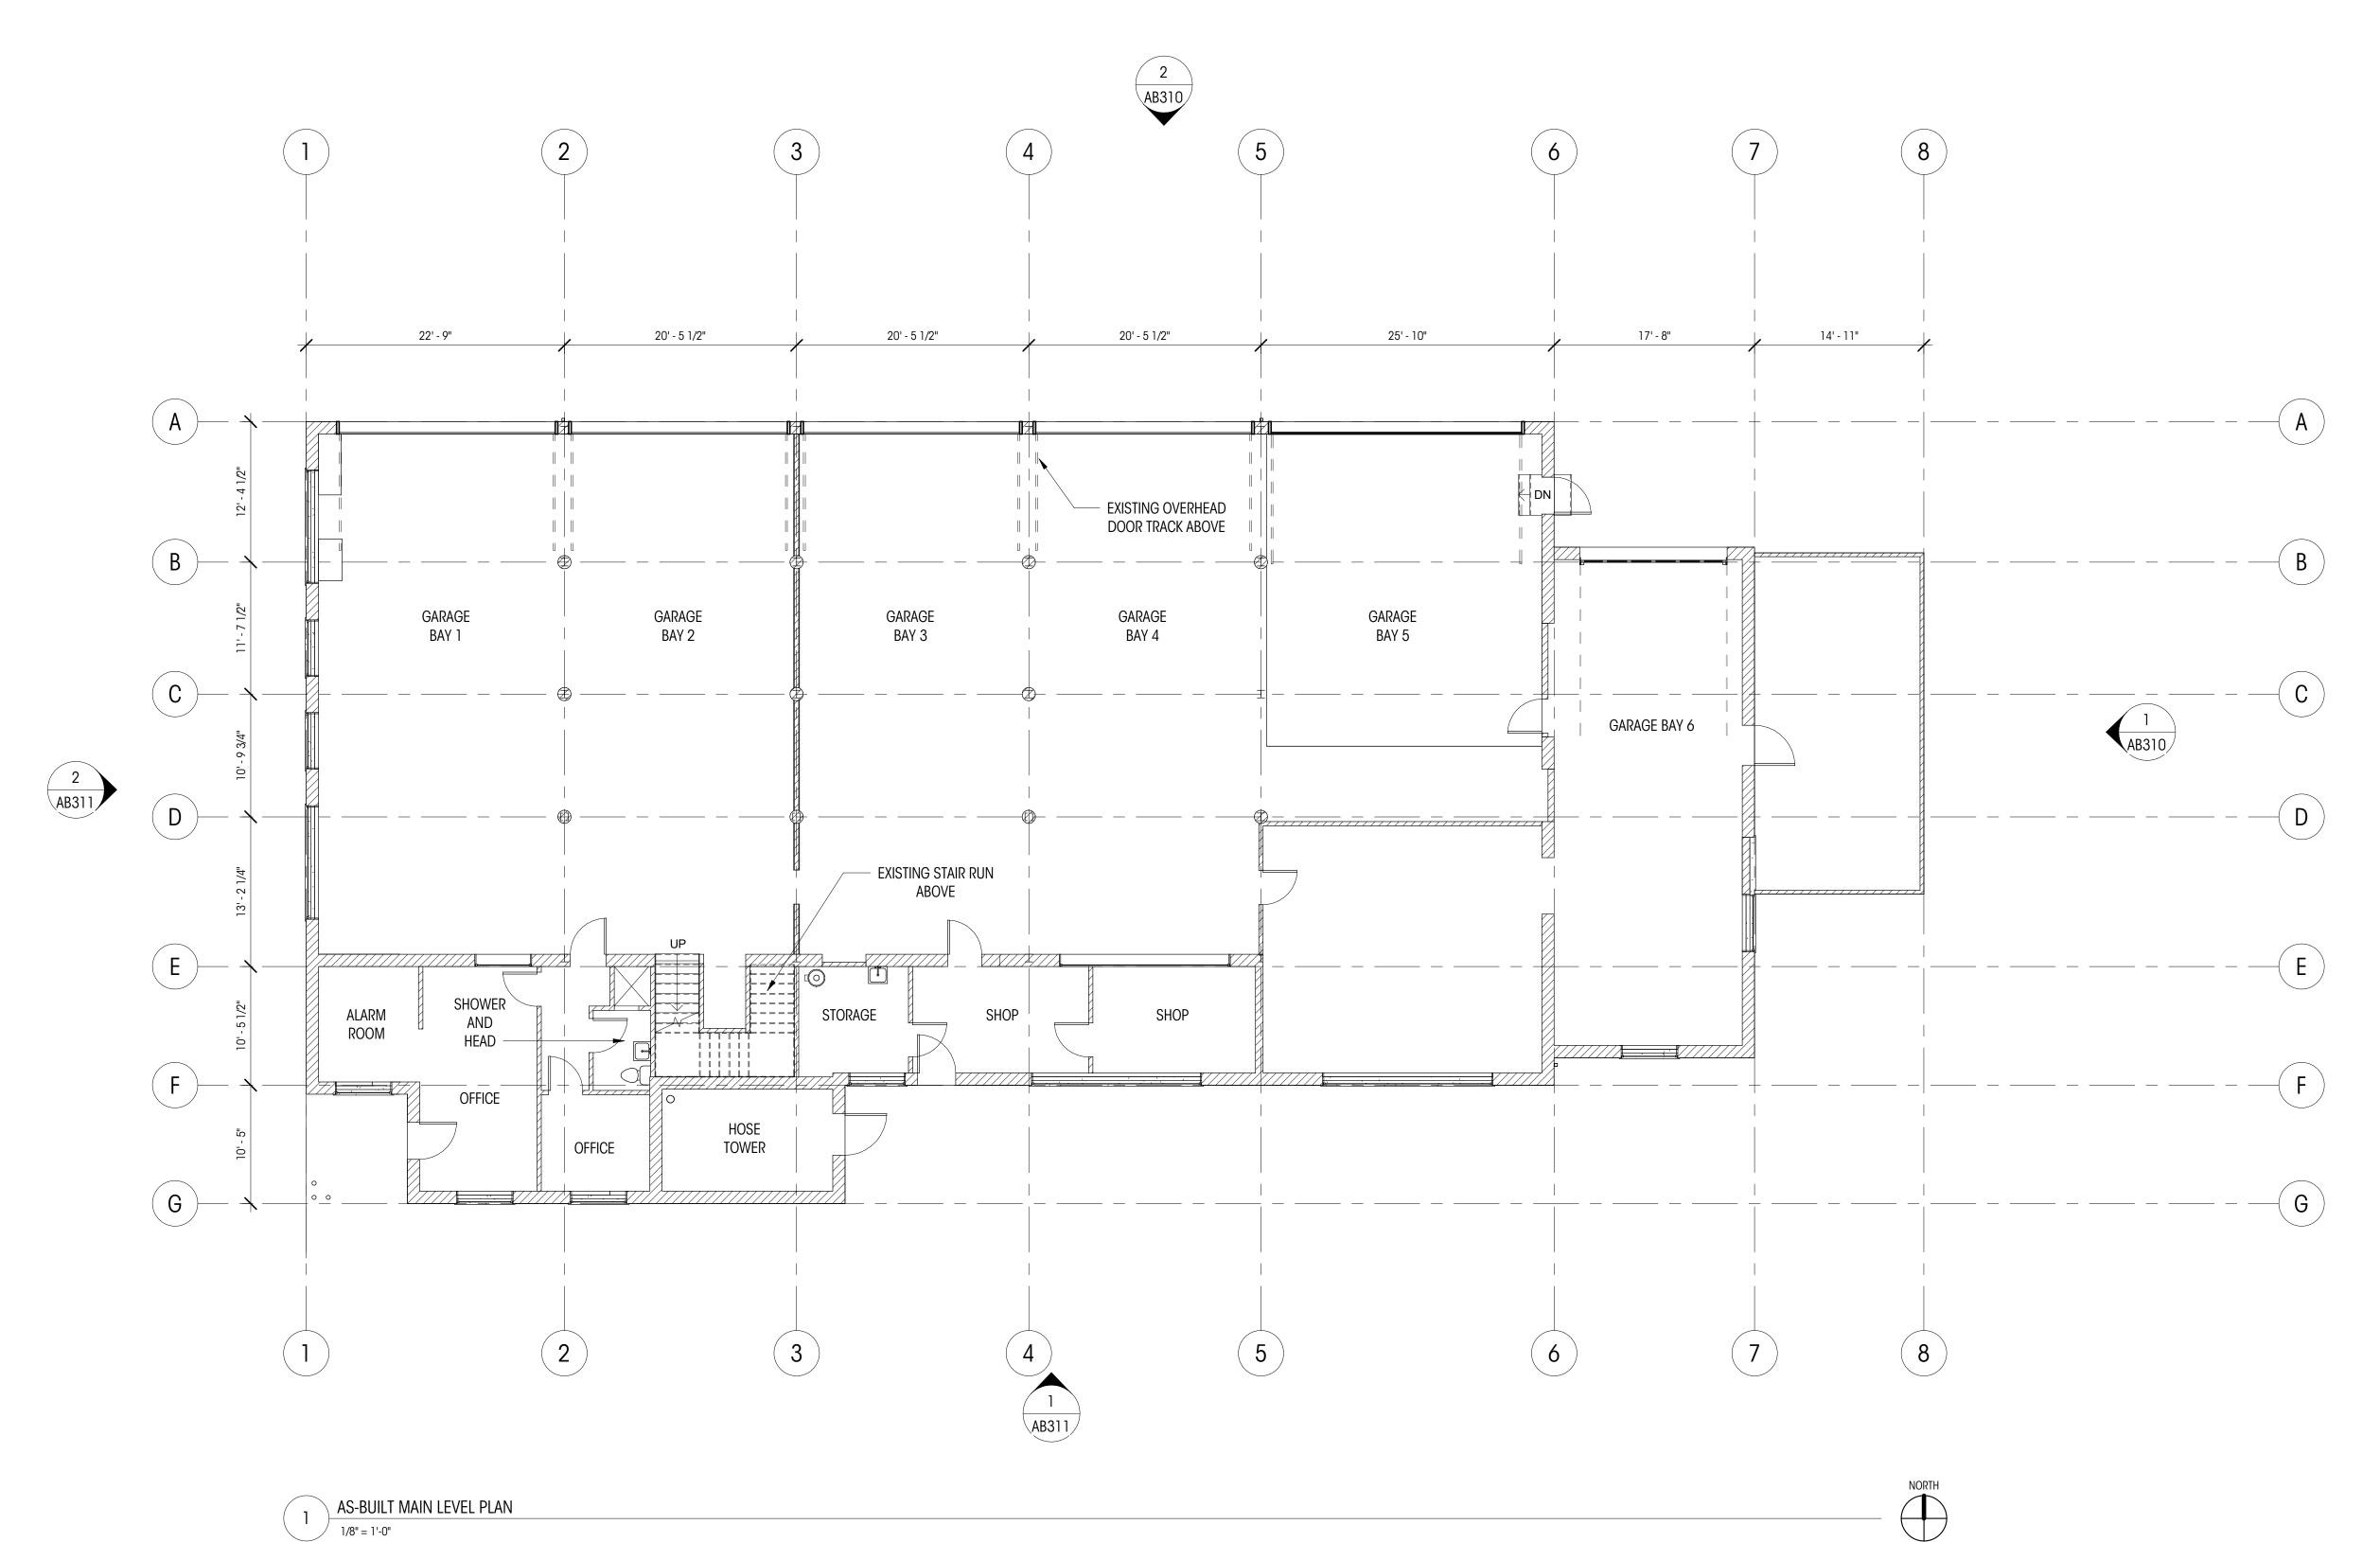

LEGEND ALL DIMENSIONS AT INTERIOR WALLS TO FACE OF FINISH (5/8" GWB ASSUMED AT EA. SIDE OF WALL), EL= 148.5' (+0'-0")

MAIN LEVEL FIN. FLR. **ELEVATION DATUM** ALL DIMENSIONS AT KITCHEN TO EDGE OF GRIDLINE COUNTERTOPS, U.N.O. LOCATION OF ALL TREES ARE ASSUMED, FOR EXACT LOCATION REFER TO SURVEY. EXISTING WALL ALL INFORMATION REGARDING TOPOGRAPHY IS ASSUMED FOR EXACT DIMENSION REFER TO BUILDING'S LOCATION ON SITE IS ASSUMED. FOR EXACT LOCATION REFER TO SURVEY.

DOORS

Brandt

Design Group

66 Bell Street Unit 1 Seattle, WA 98121

206.239.0850

brandtdesigninc.com

100% DD SET


DATE:

03/29/21 SHEET SIZE: D (24X36)

REVISIONS NO: DATE:

DRAWN BY: DD CHECKED BY: KM AS-BUILT MAIN LEVEL PLAN

As indicated

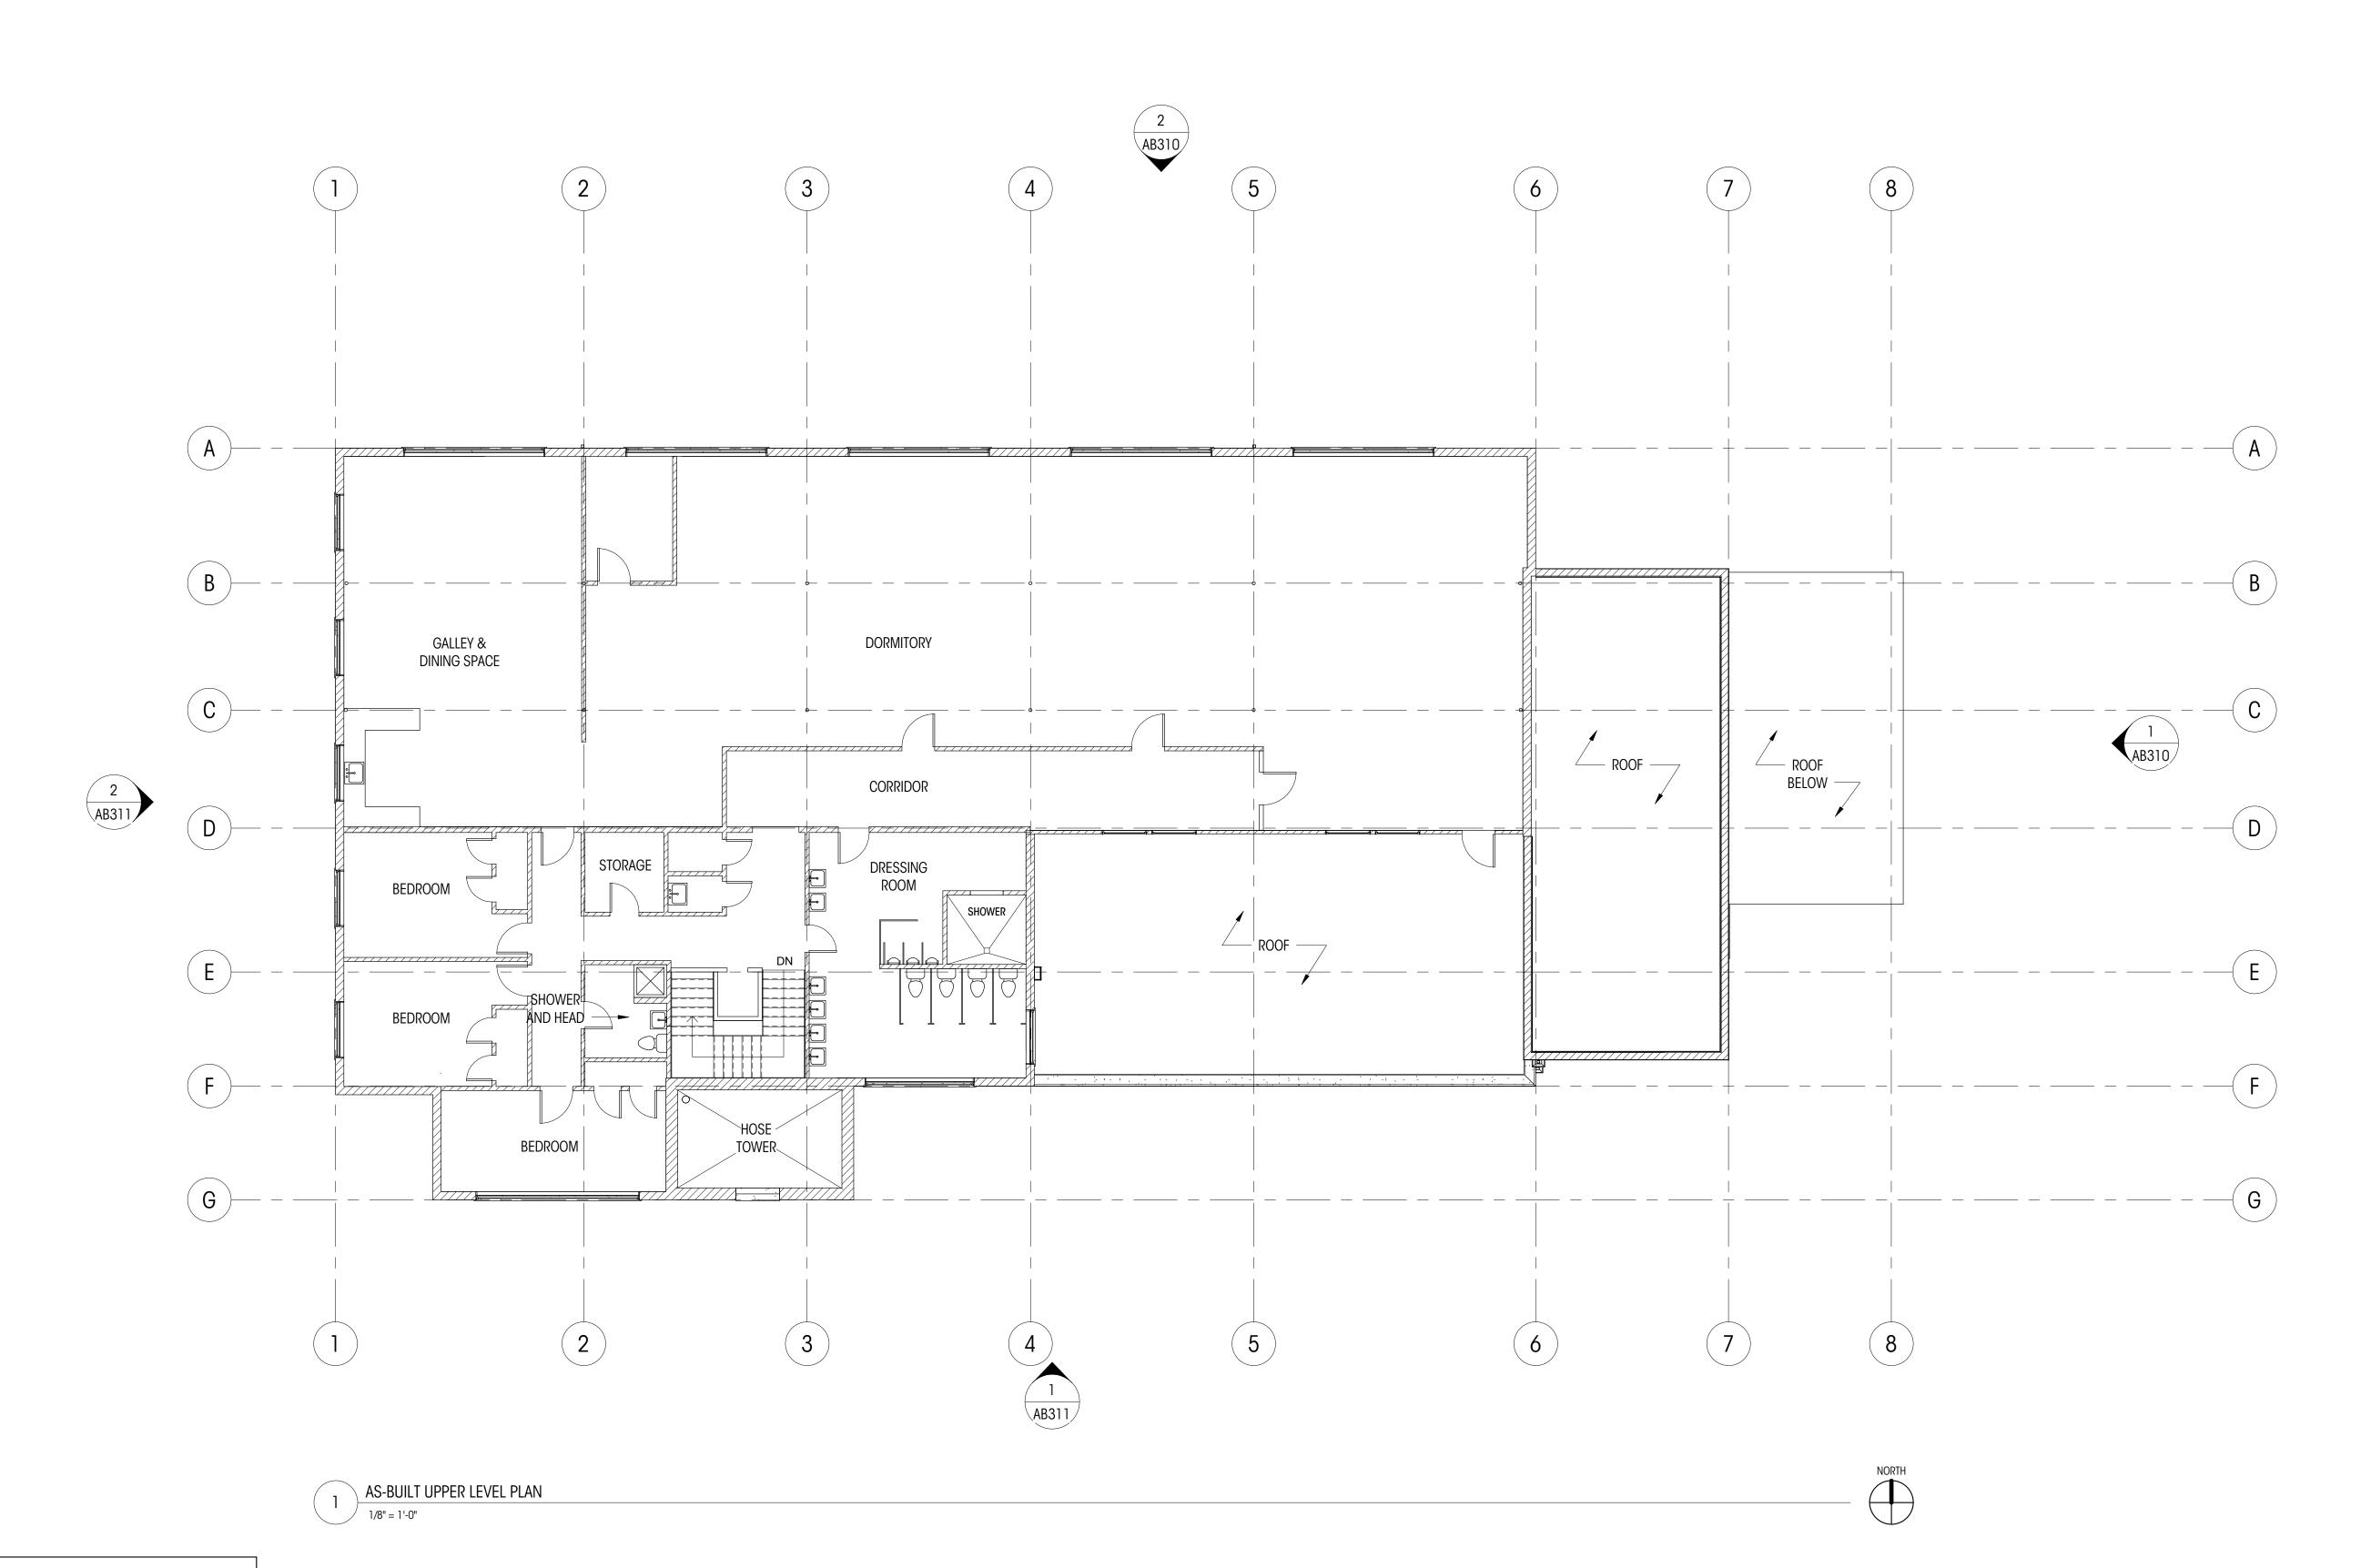

LEGEND

EL= 148.5' (+0'-0")

MAIN LEVEL FIN. FLR.

EXISTING WALL

ELEVATION DATUM

GRIDLINE

NOTES

ALL DIMENSIONS AT INTERIOR WALLS TO FACE OF FINISH (5/8" GWB ASSUMED AT EA. SIDE OF WALL),

LOCATION OF ALL TREES ARE ASSUMED, FOR EXACT LOCATION REFER TO SURVEY.

ALL INFORMATION REGARDING TOPOGRAPHY IS ASSUMED FOR EXACT DIMENSION REFER TO

BUILDING'S LOCATION ON SITE IS ASSUMED. FOR EXACT LOCATION REFER TO SURVEY.

ALL DIMENSIONS AT KITCHEN TO EDGE OF

COUNTERTOPS, U.N.O.

OUTDOORS FOR ALL HQ

SHEET SIZE: D (24X36)

SHEET SIZE: D (24X36)

SEATH: WA

© COPYRIGHT 2020 BRANDT DESIGN, INC. SEATHE, WA

Brandt

Design Group

66 Bell Street Unit 1 Seattle, WA 98121

206.239.0850

brandtdesigninc.com

DRAWN BY: DD


CHECKED BY: KM

AS-BUILT UPPER LEVEL
PLAN

SCALE: As indicated


AB202

DEDICATED
APPROVAL
STAMP SPACE

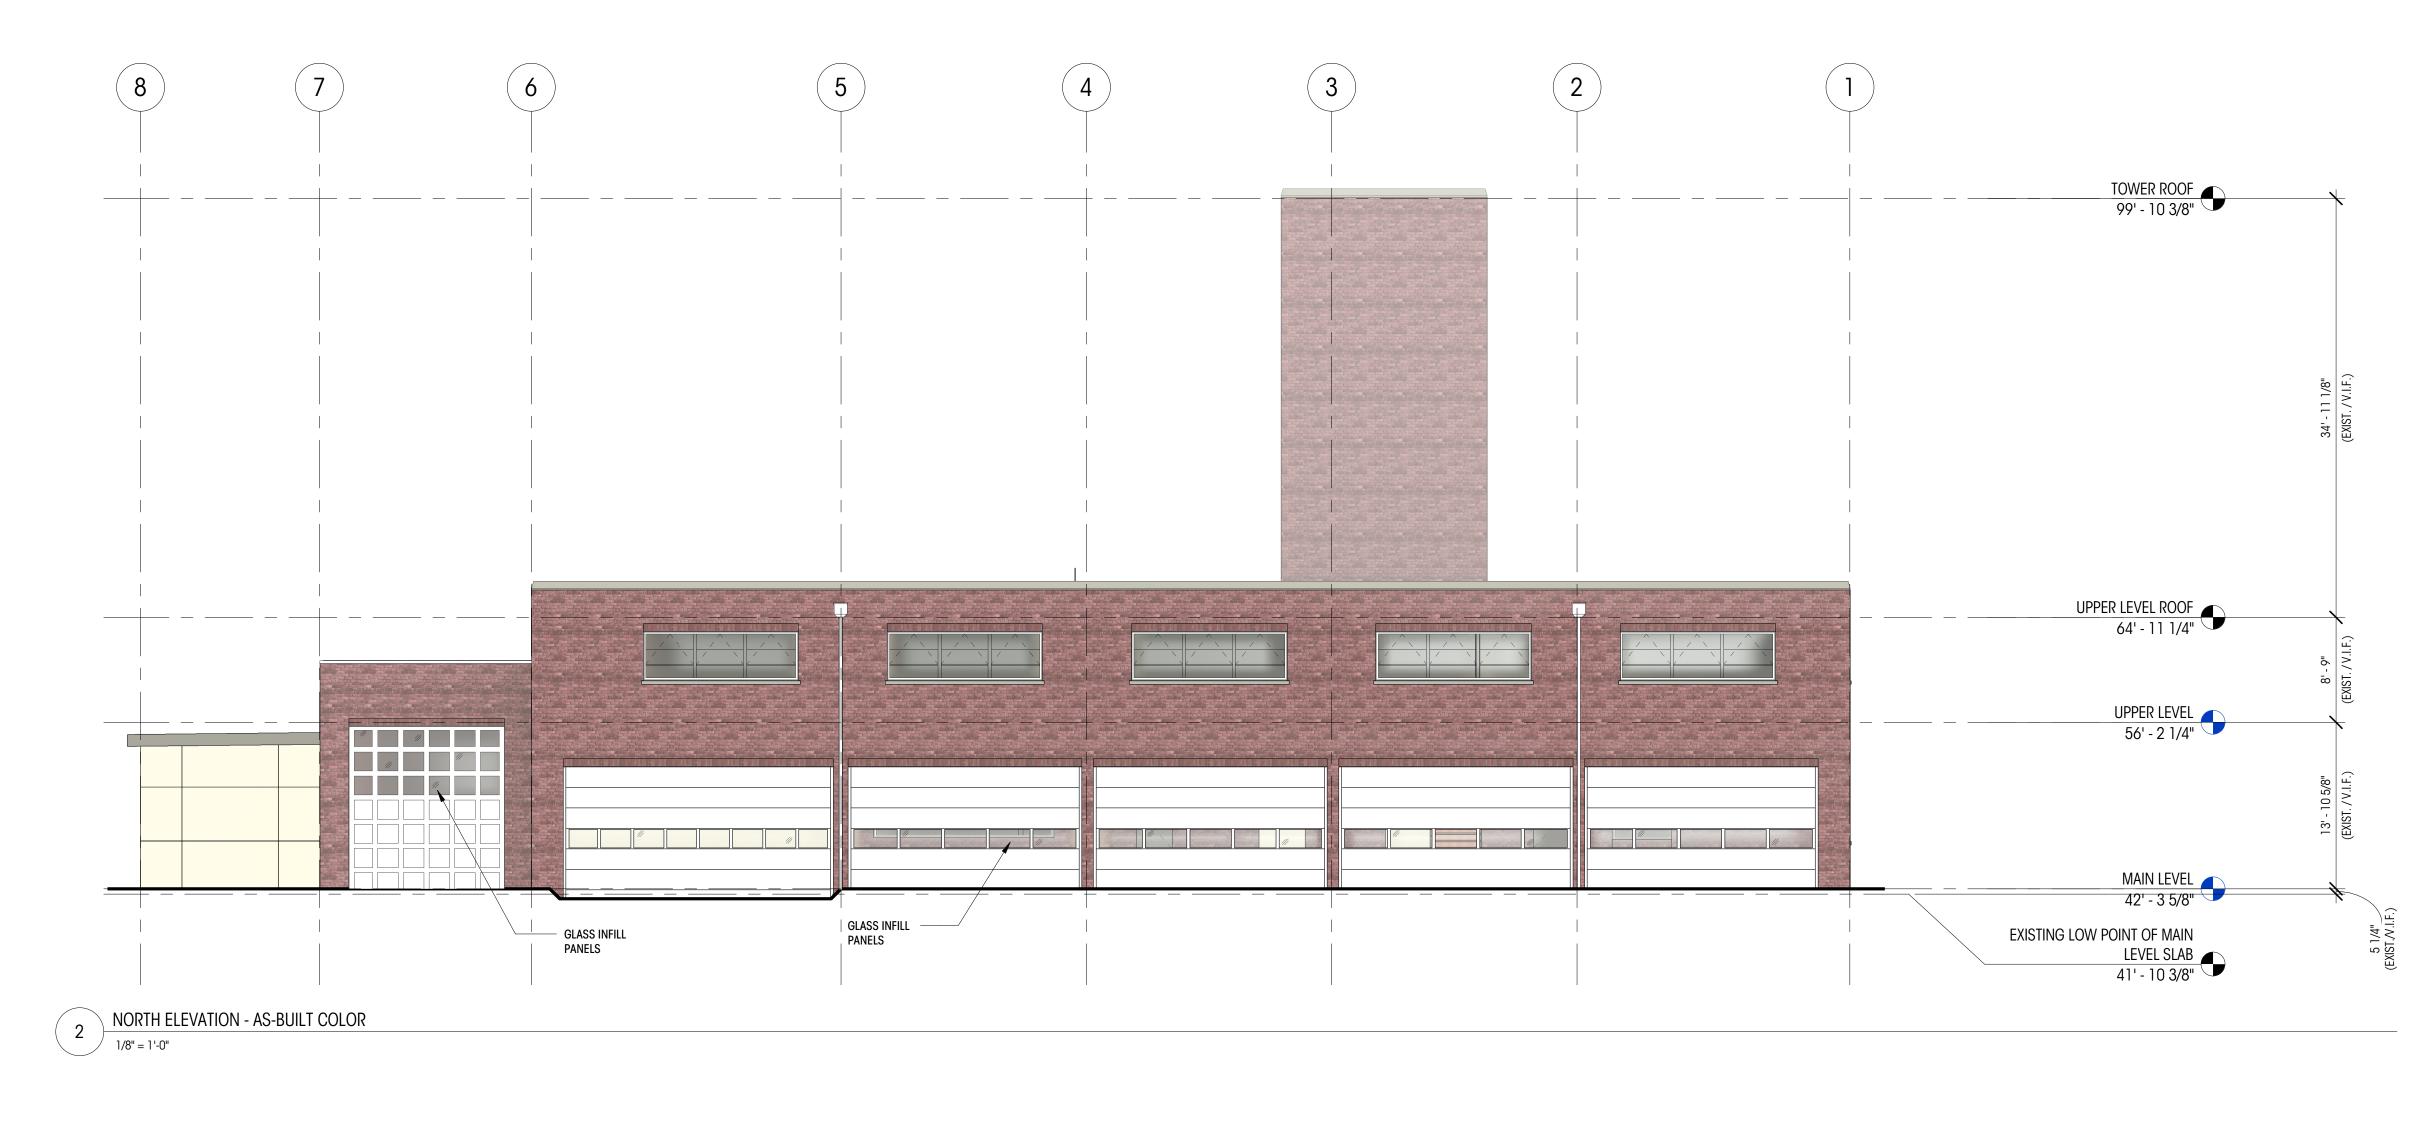

EAST ELEVATION - AS-BUILT COLOR

1/8" = 1'-0"

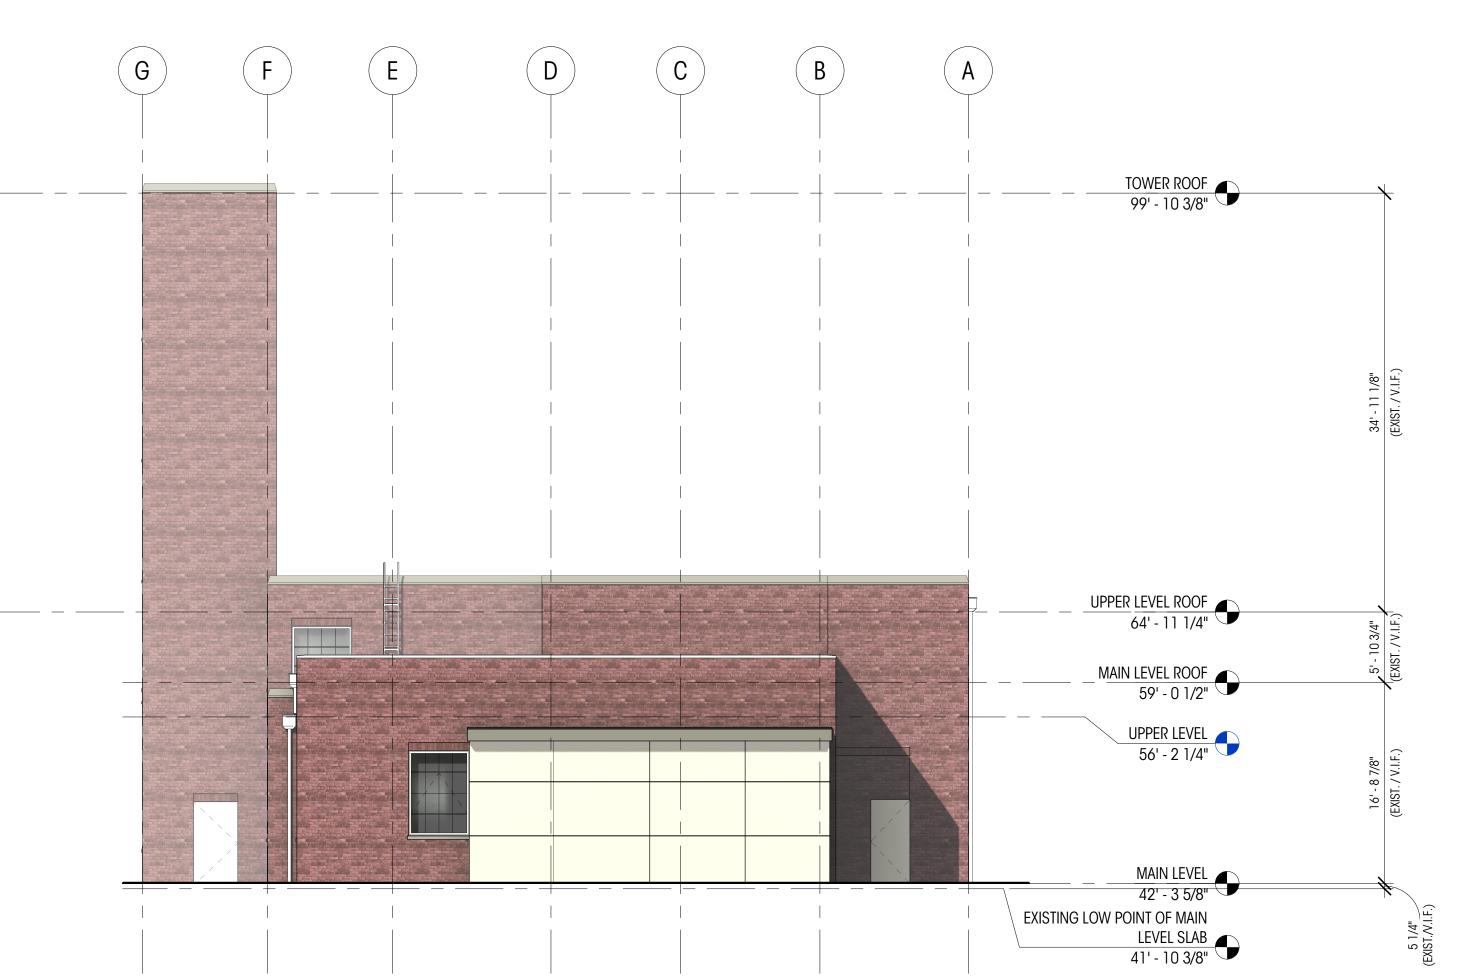



Brandt

Design Group

66 Bell Street Unit 1 Seattle, WA 98121

206.239.0850

brandtdesigninc.com


100% DD SET


DATE: 03/29/21 SHEET SIZE: D (24X36) REVISIONS NO: DATE:

DRAWN BY: DD

CHECKED BY: KM AS-BUILT COLOR EXTERIOR ELEVATIONS

1/8" = 1'-0"

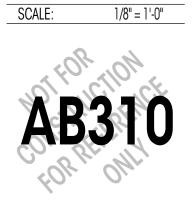

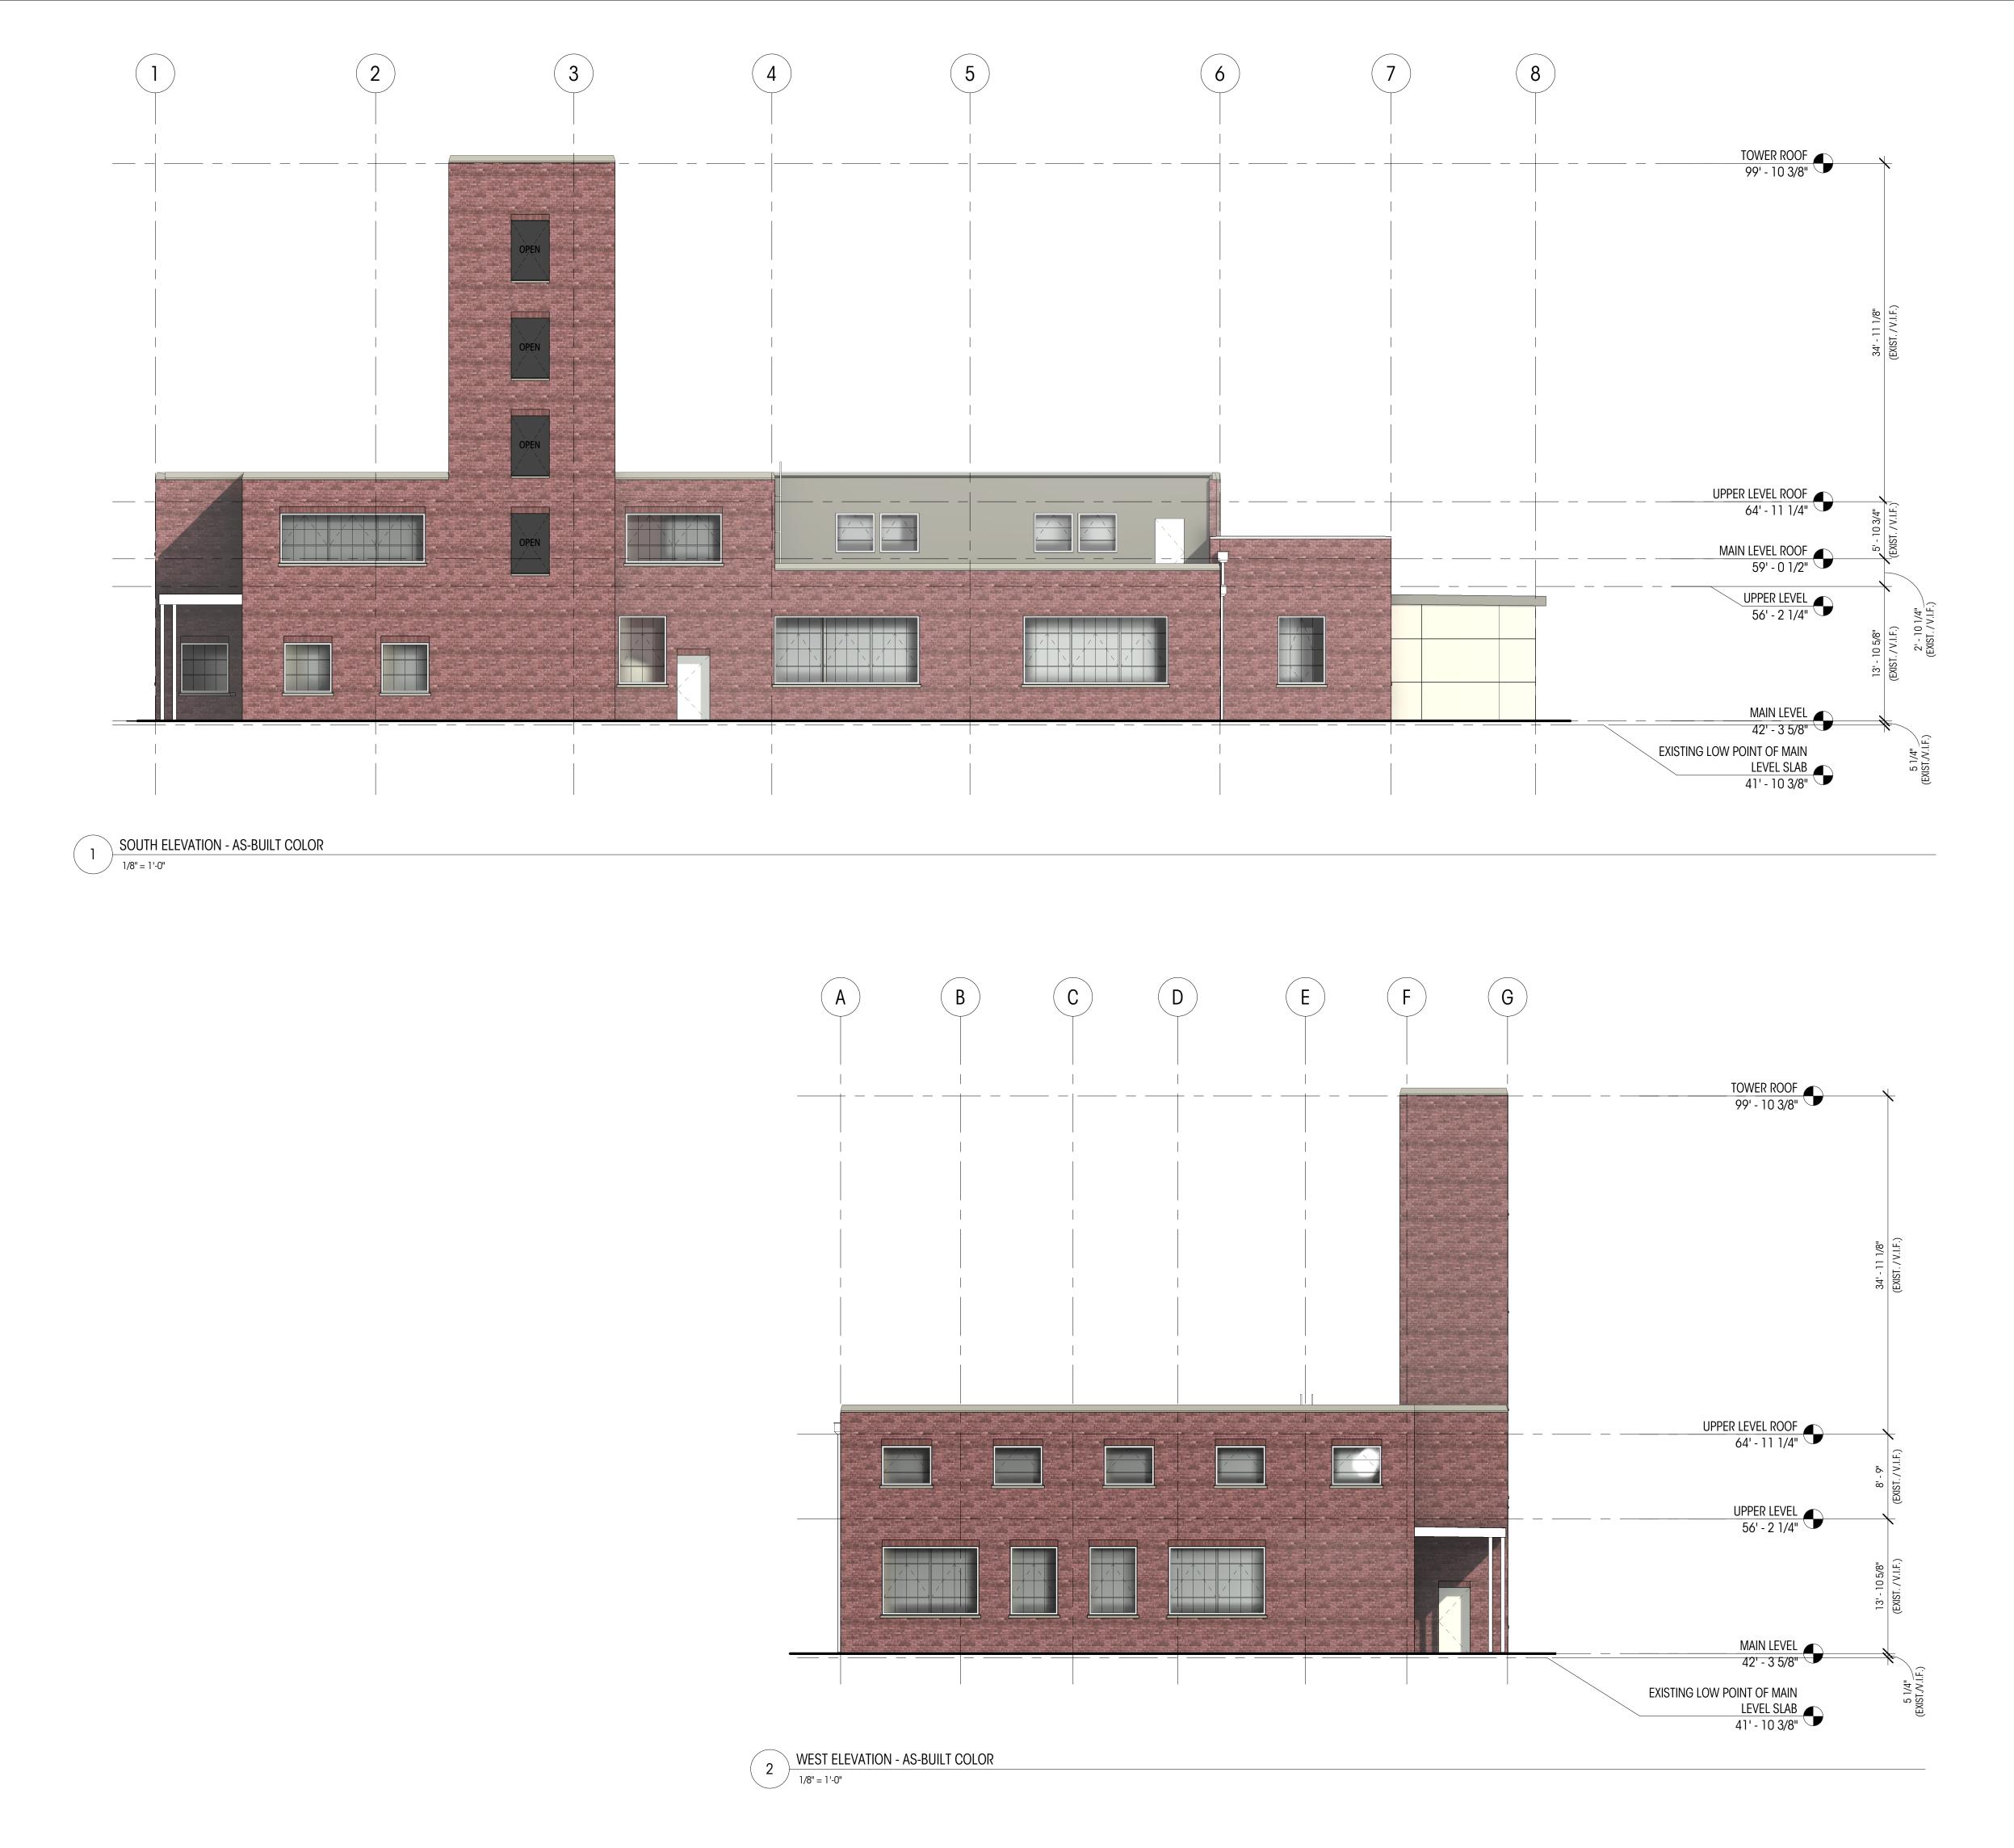

Brandt

Design Group

66 Bell Street Unit 1 Seattle, WA 98121

206.239.0850 brandtdesigninc.com

DOORS The St Seattle 98115

100% DD SET

SHEET SIZE: D (24X36)

REVISIONS NO: DATE:

DRAWN BY: DD CHECKED BY: KM

AS-BUILT COLOR EXTERIOR ELEVATIONS

03/29/21

DATE:

1/8" = 1'-0"