


NORTON BUILDING-MODERNIZATION—

DESIGN DEVELOPMENT



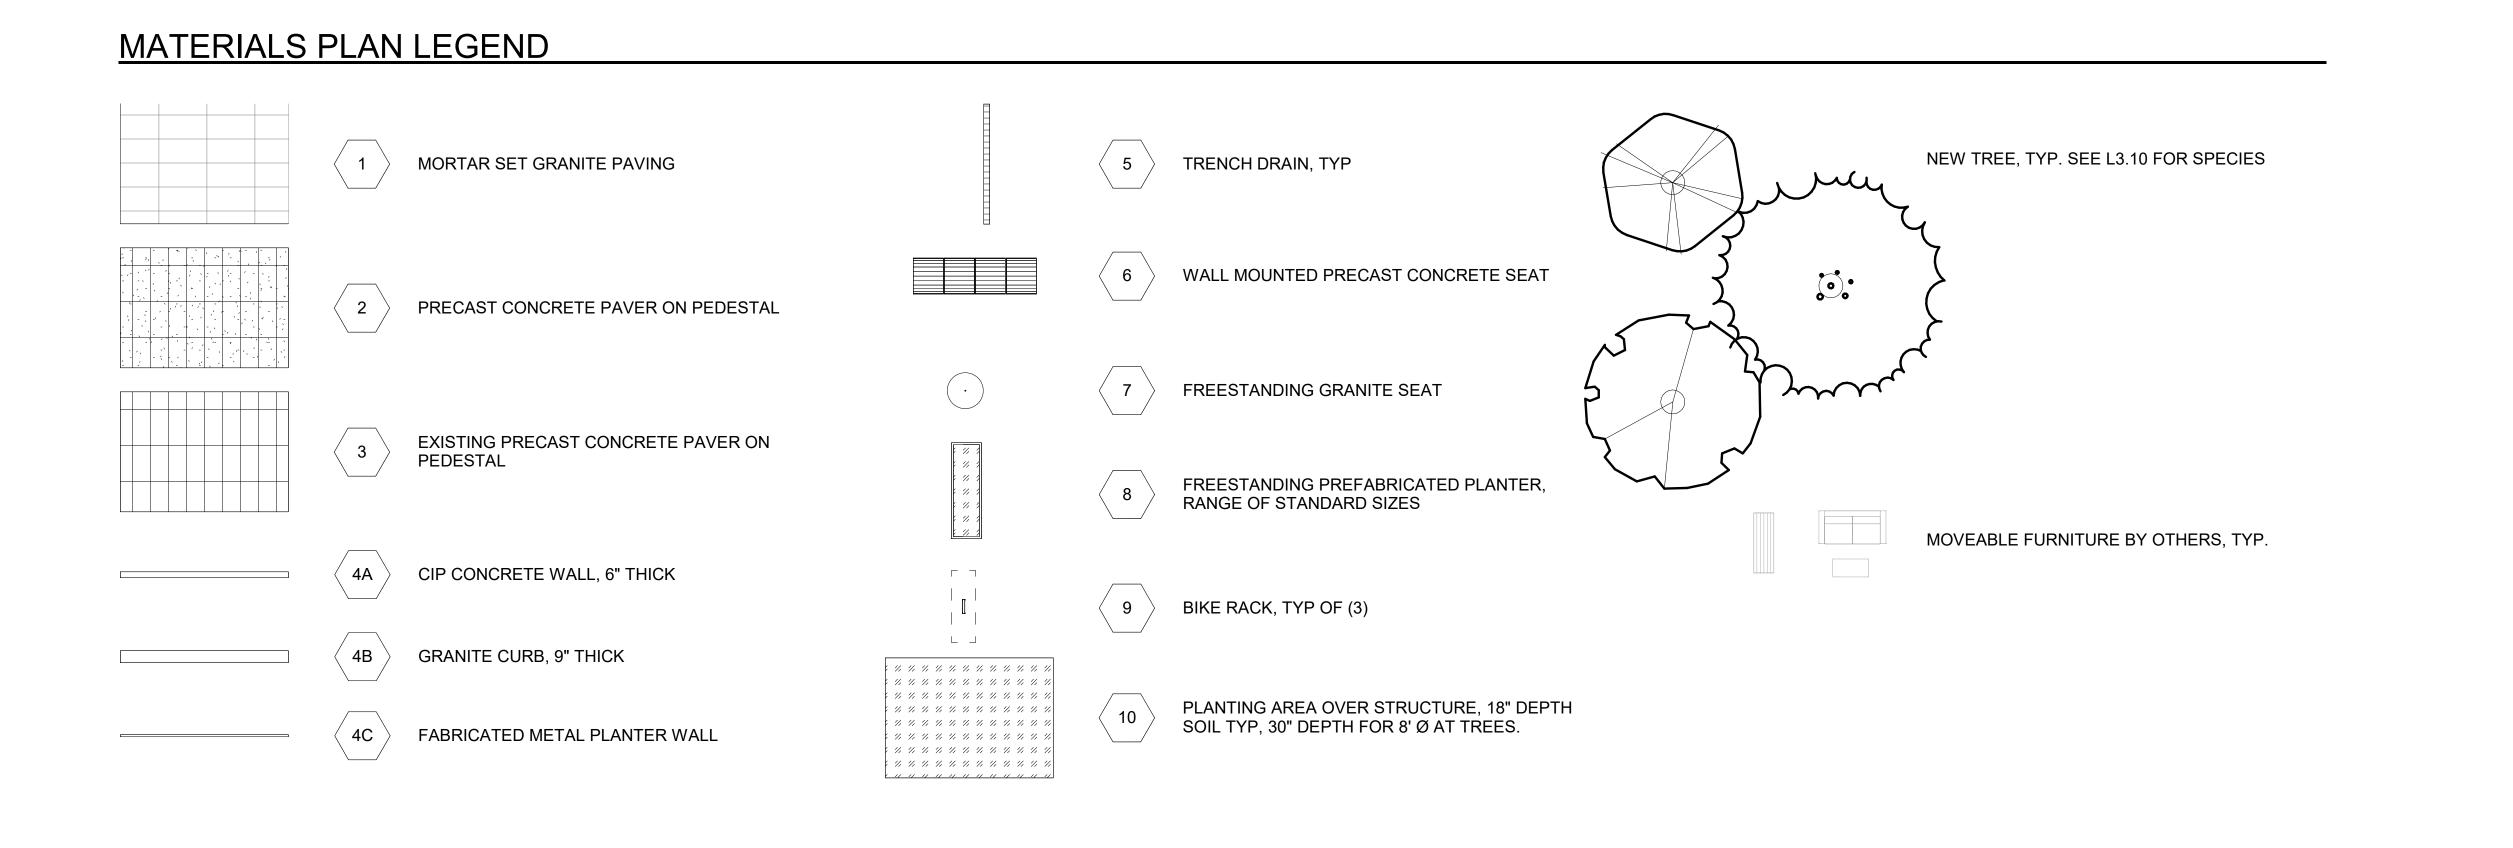

MATERIALS NOTES

- REFER TO LAYOUT PLANS FOR ALL PLANTER DIMENSIONS (FORTHCOMING).
- 2. REFER TO LAYOUT PLANS FOR ALL SCORING AND JOINTING OF PAVEMENT AREAS ON SITE (FORTHCOMING).
- REFER TO L5.01 FOR SITE DETAILS.
 ALL SITE FURNISHINGS INCLUDING BUT NOT LIMITED TO TABLES, CHAIRS, AND TRASH RECEPTACLES ARE TO BE OWNER FURNISHED AND CONTRACTOR INSTALLED (OFCI), TYP. FINAL LOCATIONS AND QUANTITIES TO BE
- DETERMINED.


 5. REPORT ANY DISCREPANCIES BETWEEN THESE DRAWINGS AND ACTUAL FIELD CONDITIONS TO LANDSCAPE ARCHITECT PRIOR TO CONSTRUCTION/INSTALLATION.

COORDINATION NOTES

LMN OR OTHERS TO CONFIRM THE FOLLOWING:

- STRUCTURAL SLAB ELEVATIONSEGRESS / OCCUPANCY REQUIREMENTS
- EXISTING PLAZA DRAIN REUSE
- WATERPROOFING, DRAIN MAT, AND MORTAR
 SETTING BED.
- SETTING BED

 SCREEN WALL MATERIAL AND ATTACHMENT
- ROW GRADESLIGHTING PHOTOMETRICS FOR EGRESS

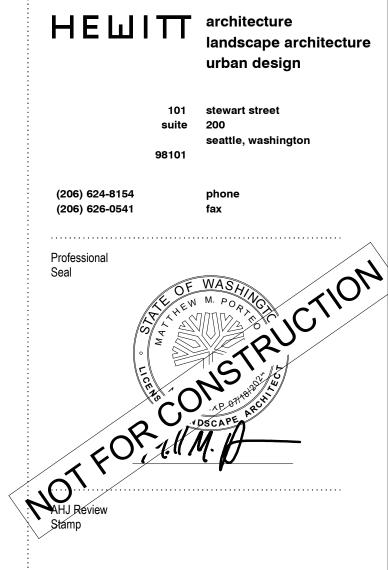

Architecture
Urban Design
Interiors

801 Second Avenue, Suite 501 Seattle, Washington 98104

T 206 682 3460

www.lmnarchitects.com

HINES

NORTON BUILDING MODERNIZATION

801 Second Ave Seattle, WA 98104

Submittal

DESIGN DEVELOPMENT

Revisions
Date Description
08/31/2023 PERMIT SUBMITTAL

DESIGN DEVELOPMENT


Owner RM Proj No 22004

Sheet Title

MATERIALS PLAN

Sheet Number

L1.01

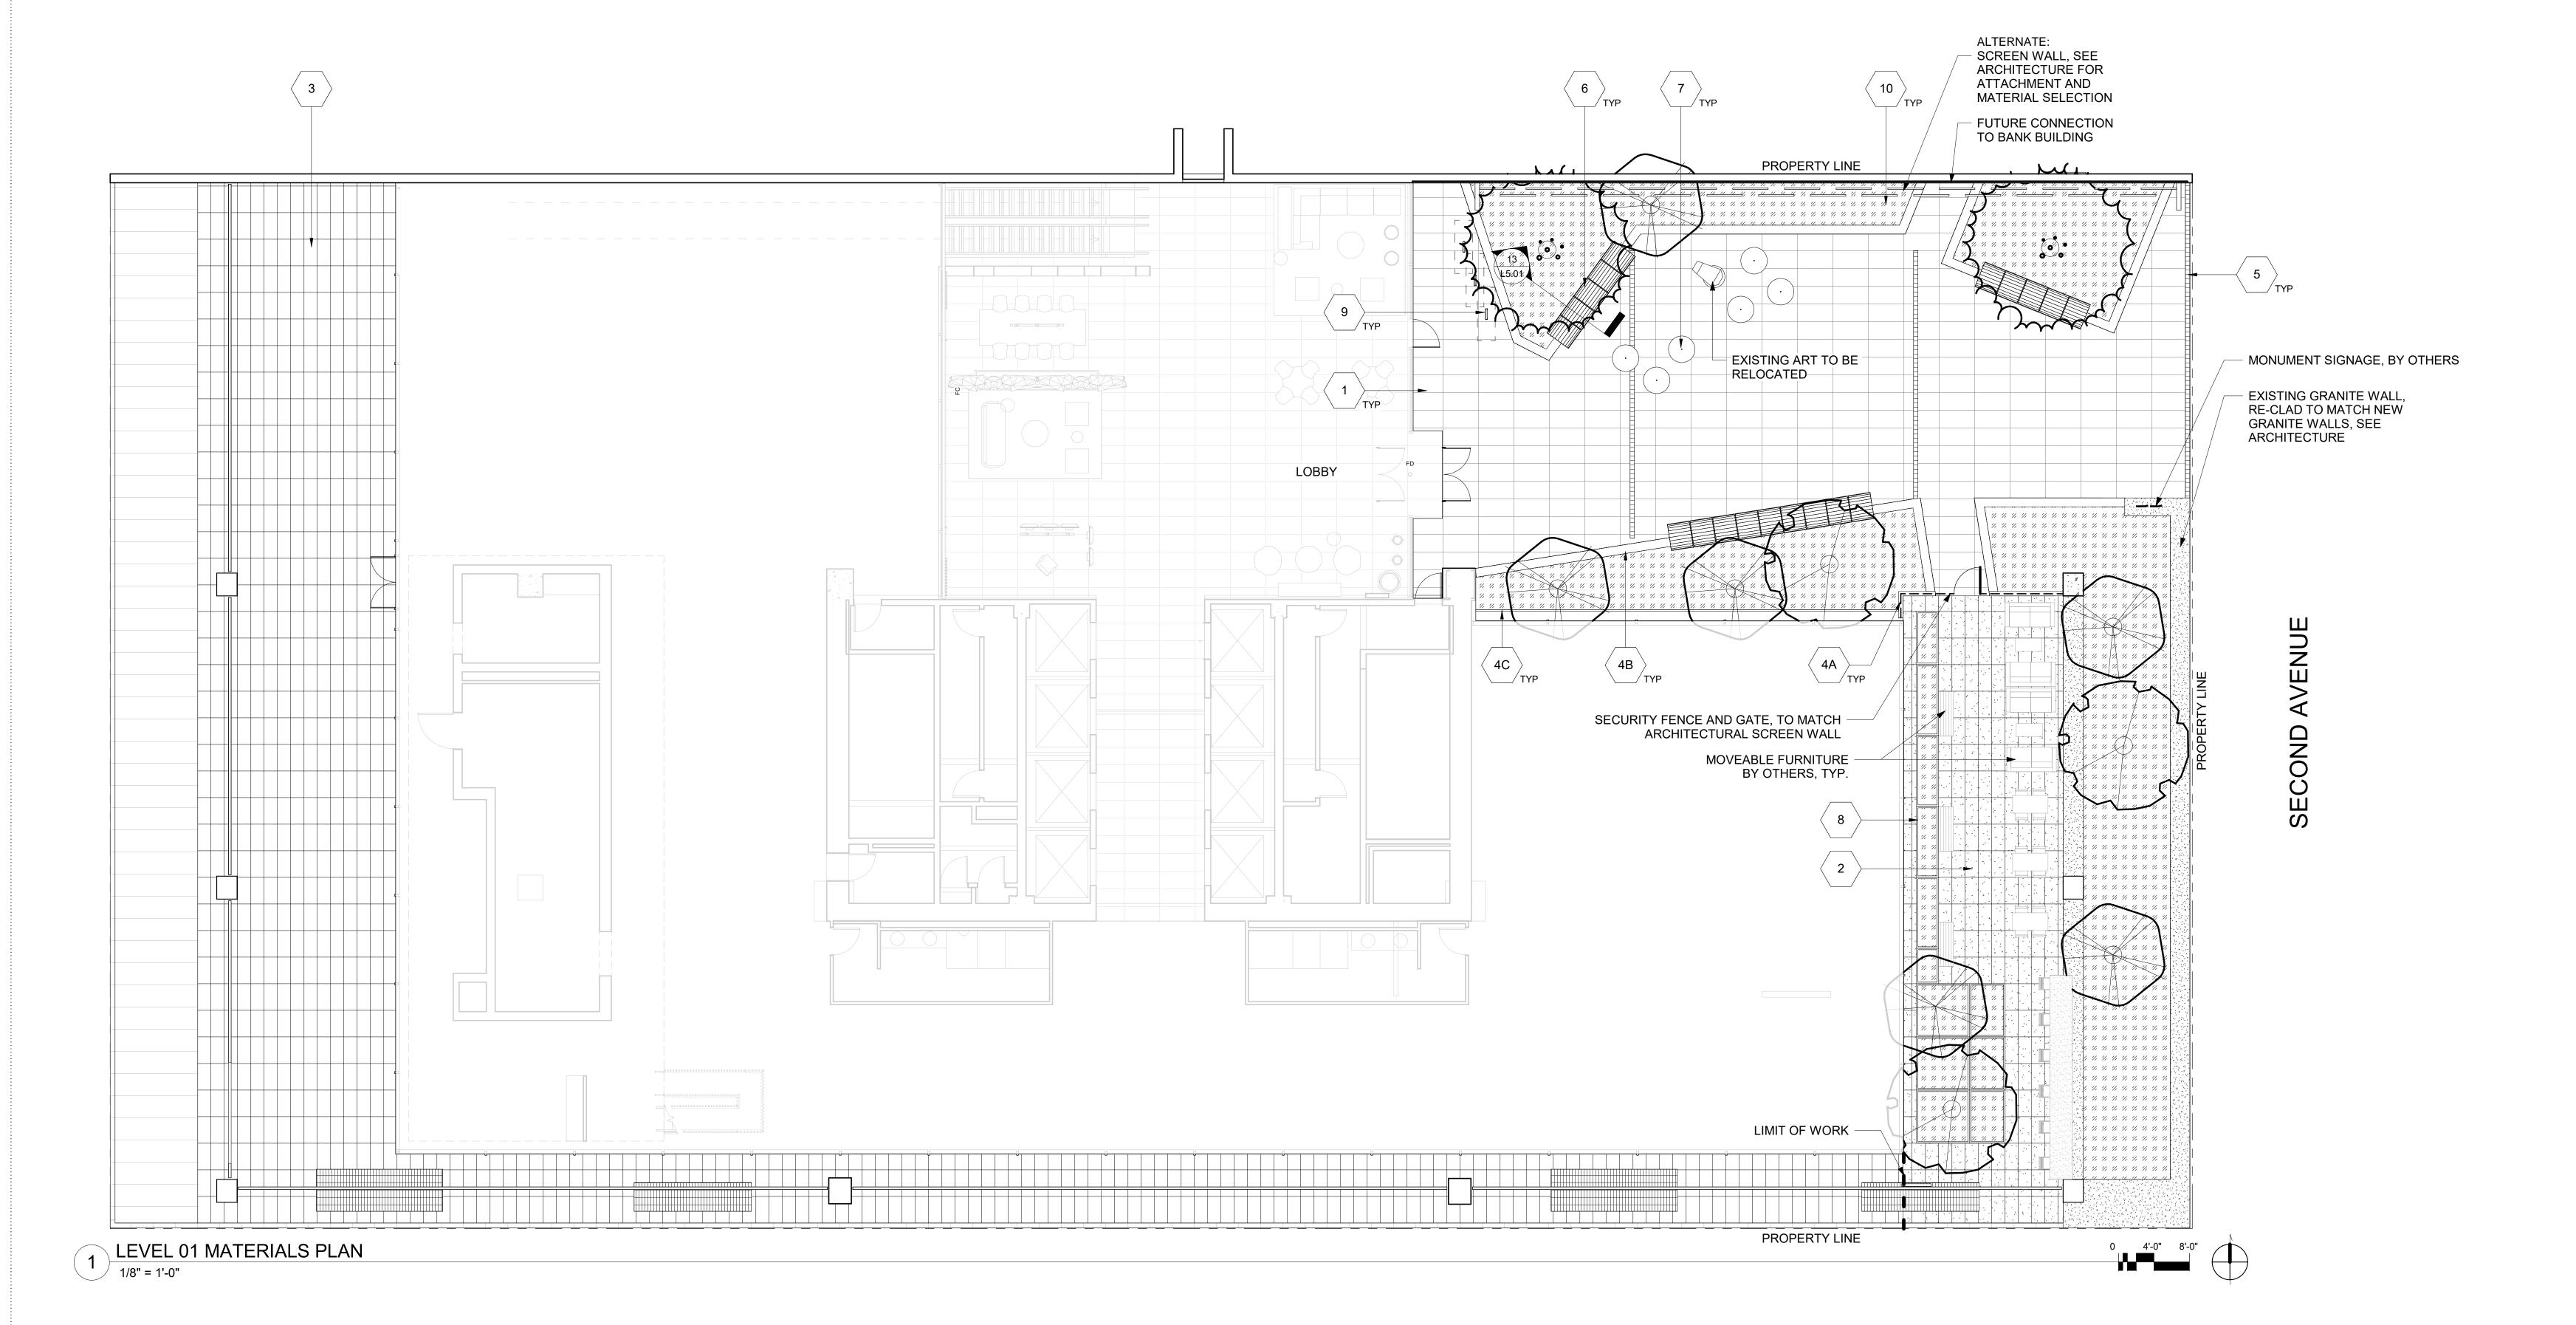

LEGEND - GRADING


<u> </u>	FE XXX.XX	FINISH FLOOR ELEVATION
<]	(XX.XX]	ELEVATION AT R.O.W. SEE CIVIL DRAWINGS
• X	XX.XX	PROPOSED ELEVATION
• <u>X</u>	XX.XX	CIVIL REFERENCE ELEVATION, SEE CIVIL
• <u>I</u>	W XXX.XX	TOP OF WALL ELEVATION
<u> </u>	B XXX.XX	TOP OF BENCH ELEVATION
• <u>I</u>	S XXX.XX	TOP OF STAIR
● <u>B</u>	S XXX.XX	BOTTOM OF STAIR
• <u>H</u>	P XXX.XX	HIGH POINT OF SOIL ELEVATION
<u> </u>	P XXX.XX	LOW POINT ELEVATION

PROPOSED SLOPE

◄── XX %

GRADING NOTES

- 1. GRADING IN ROW IS DIAGRAMATIC AND PRIOVIDED FOR REFERENCE ONLY. CONTRACTOR TO FIELD VERIFY EXISTING
- 2. CALL THE UTILITIES UNDERGROUND LOCATION CENTER FOR FIELD LOCATION OF ALL UTILITIES. DO NOT PERFORM ANY EXCAVATION OR OTHER GRADING OPERATIONS PRIOR TO THEIR
- 3. SLOPE FINISHED SURFACE A MINIMUM OF 2% AWAY FROM THE BUILDING ON ALL SIDES UNLESS NOTED OTHERWISE.
- 4. BOTTOM OF WALL REFERS TO FINISH SURFACE GRADE AT THE BASE OF THE WALL. PROVIDE ADEQUATE COVER FOR FOOTING AND SUBBASE DEPTH BELOW BOTTOM OF WALL GRADE.
- 5. COORDINATE FINE GRADING AND SURFACE DRAINAGE WITH LANDSCAPE INSTALLATION. SEE MATERIALS PLANS AND ARCHITECTURAL PLANS FOR HARDSCAPE, WALLS, STEPS, LANDSCAPE FEATURES, AND PLANTING AREAS.
- 6. REFER TO SHEETS L5.01 FOR SITE DETAILS. 7. REPORT ANY DISCREPANCIES BETWEEN THESE DRAWINGS AND
- ACTUAL FIELD CONDITIONS TO THE LANDSCAPE ARCHITECT PRIOR TO CONSTRUCTION / INSTALLATION.

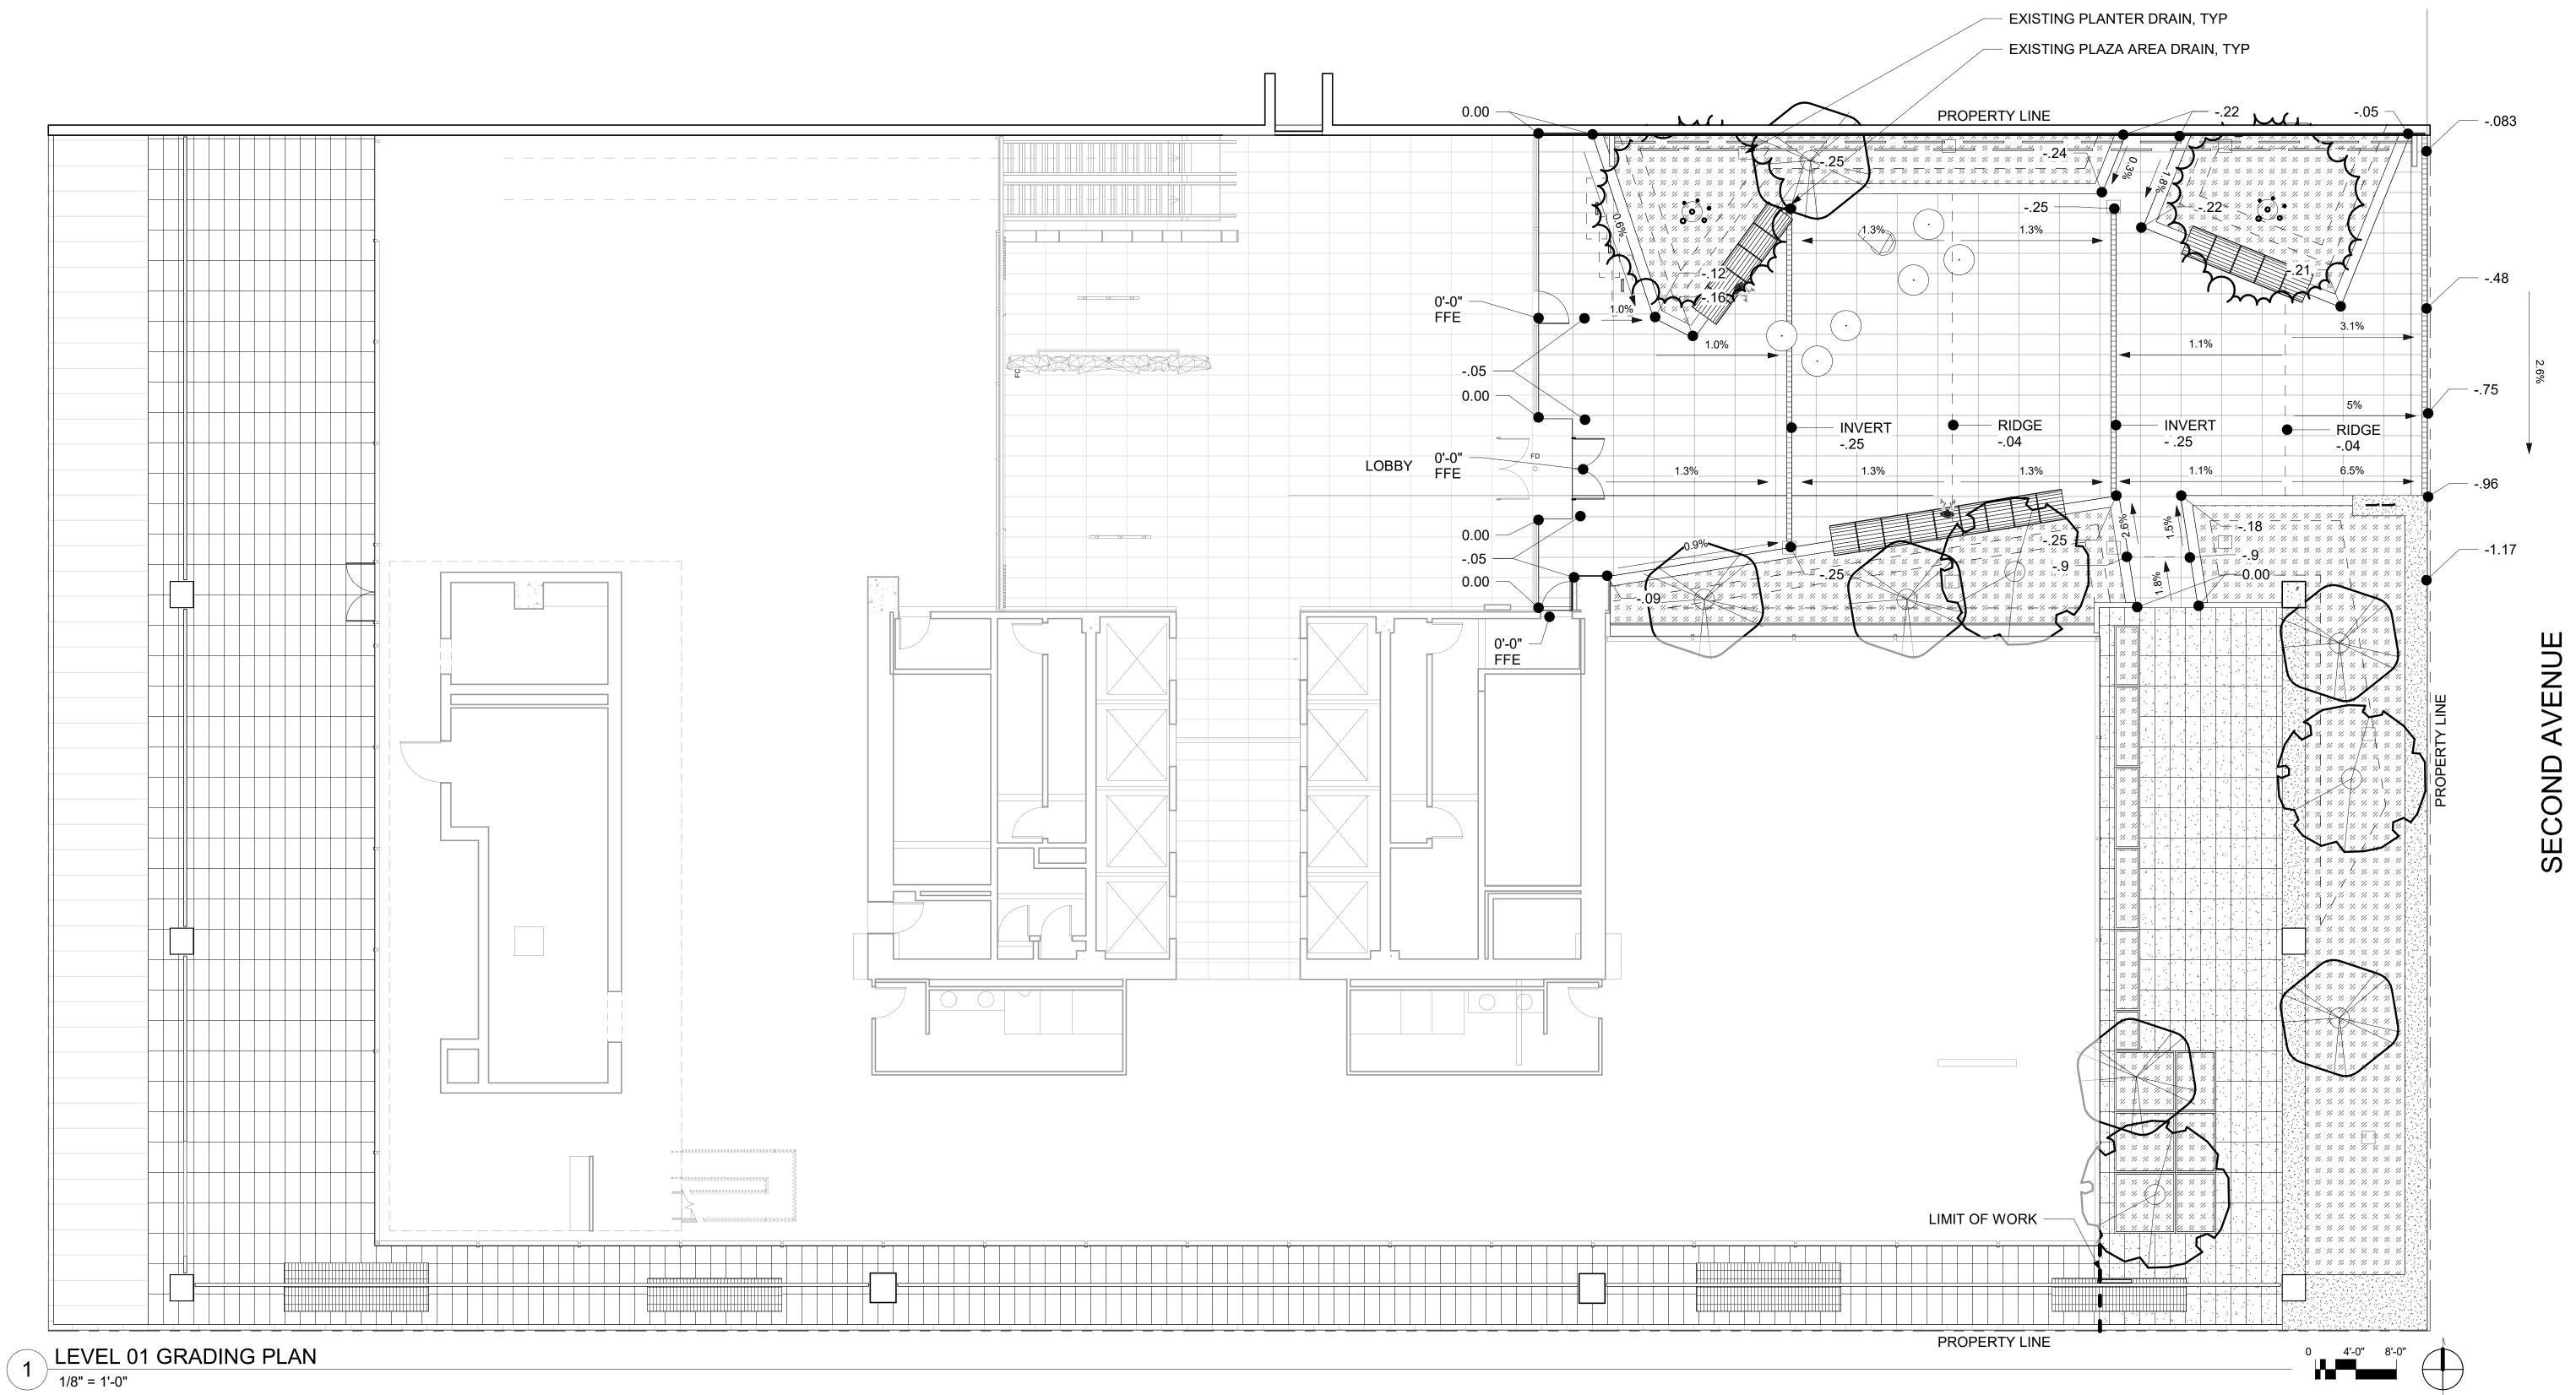



801 Second Avenue, Suite 501 Seattle, Washington 98104 T 206 682 3460 www.lmnarchitects.com

HEWITT architecture

(206) 626-0541

NORTON BUILDING MODERNIZATION

801 Second Ave Seattle, WA 98104

DESIGN DEVELOPMENT

PERMIT SUBMITTAL
DESIGN DEVELOPMENT

GRADING PLAN

Sheet Number

PLANTING NOTES

- REFER TO SHEET L3.10 FOR PLANT SCHEDULE AND PLANTING DETAILS.
- 2. PROVIDE 2" DEPTH OF COMPOST MULCH AT ALL PLANTED
- 3. ALL PLANTED AREAS TO RECEIVE PERMANENT IRRIGATION. REFER TO SHEET L4.01 FOR IRRIGATION PLAN.
- 4. REFER TO SHEET L3.10 FOR TYPICAL SOIL SECTION. 5. REPORT ANY DISCREPANCIES BETWEEN THESE DRAWINGS AND
- ACTUAL FIELD CONDITIONS TO LANDSCAPE ARCHITECT PRIOR TO CONSTRUCTION/INSTALLATION.



HELITT architecture landscape architecture


(206) 626-0541


NORTON BUILDING MODERNIZATION


801 Second Ave Seattle, WA 98104

DESIGN DEVELOPMENT

PLANTING PLAN Sheet Number

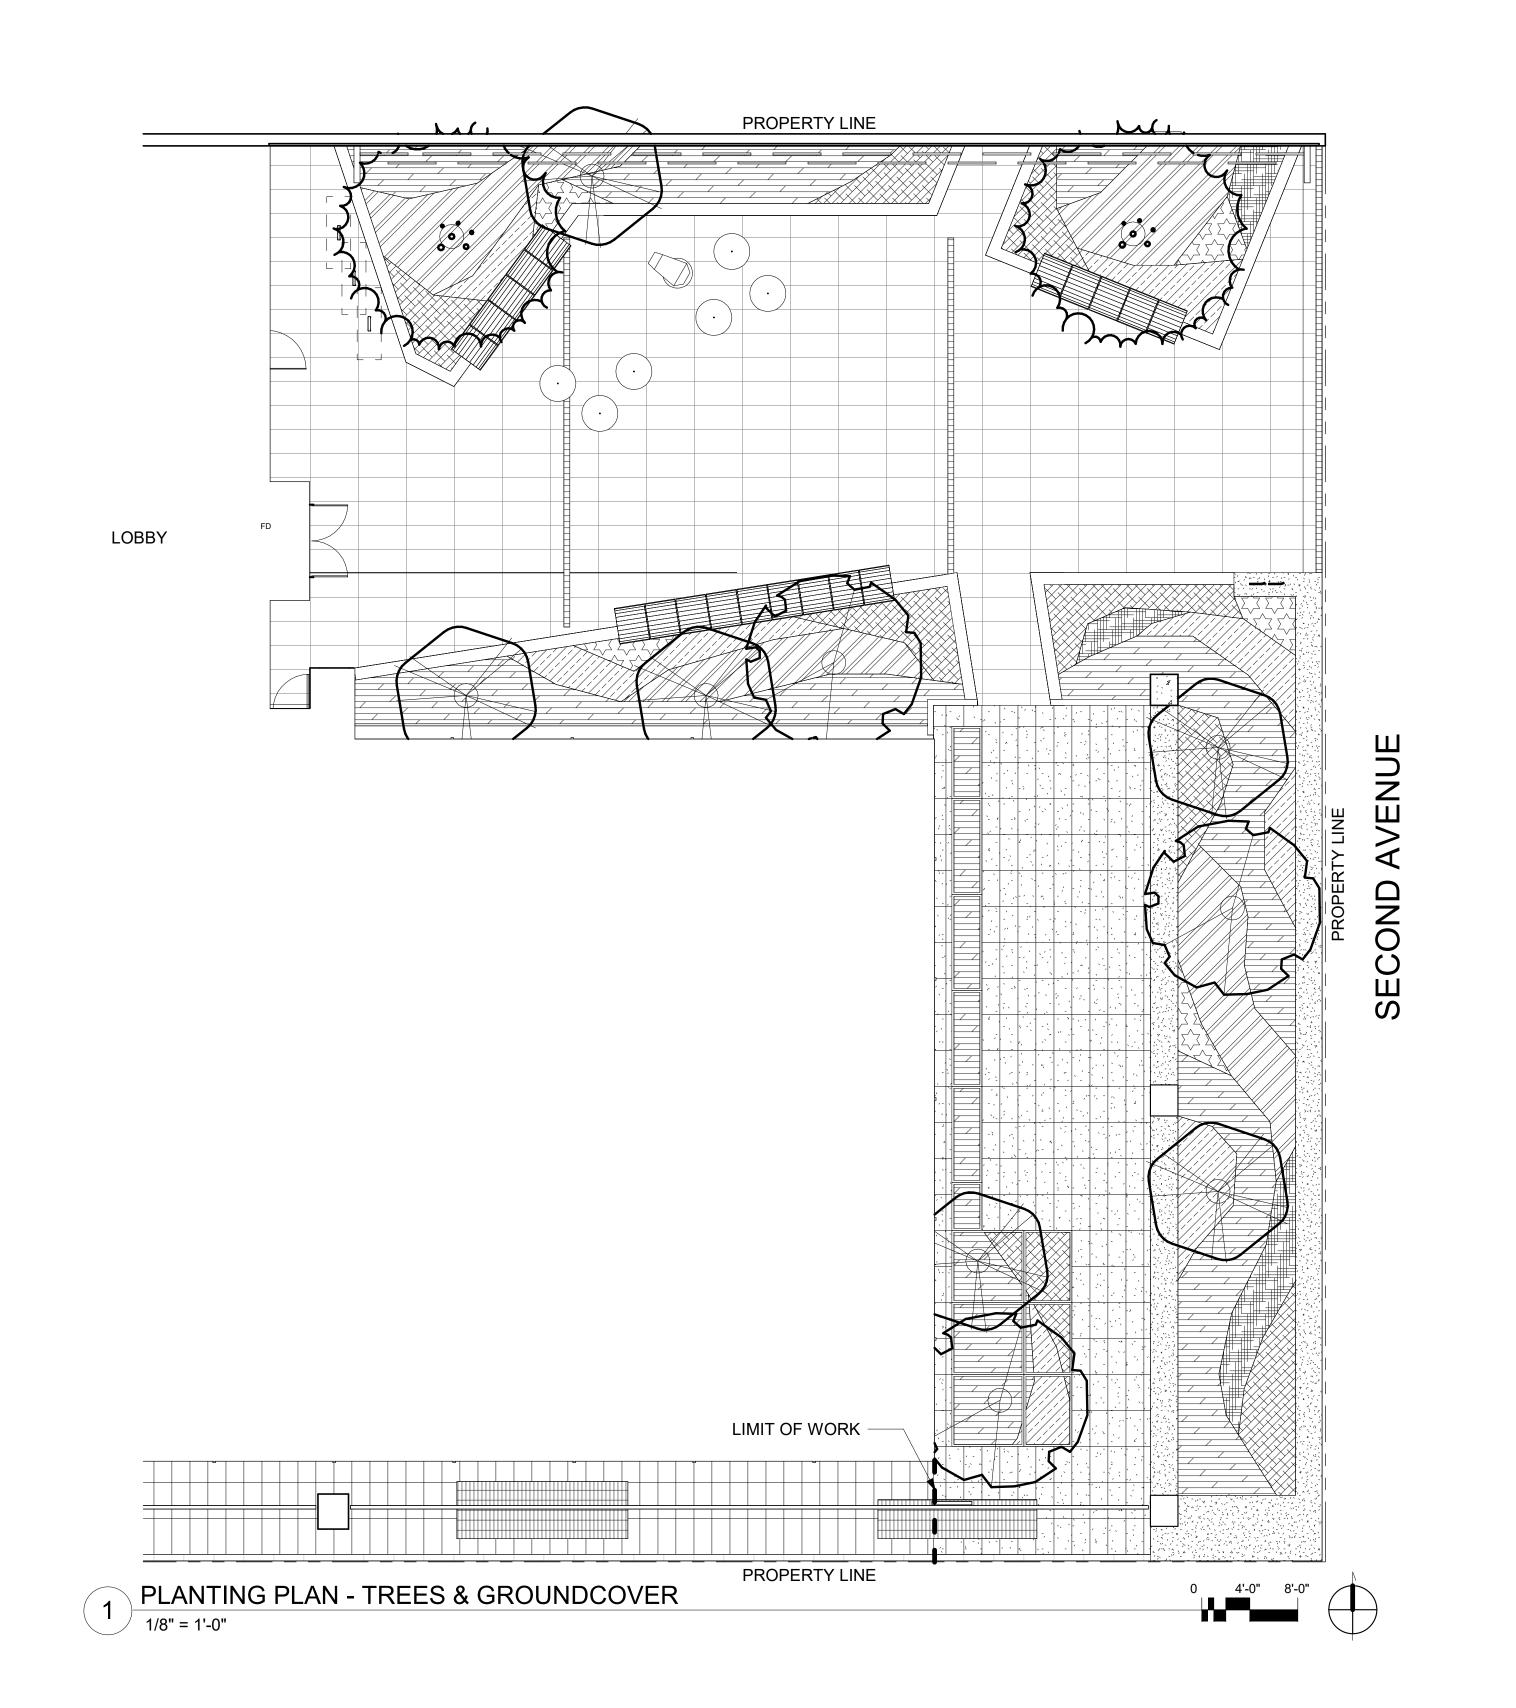

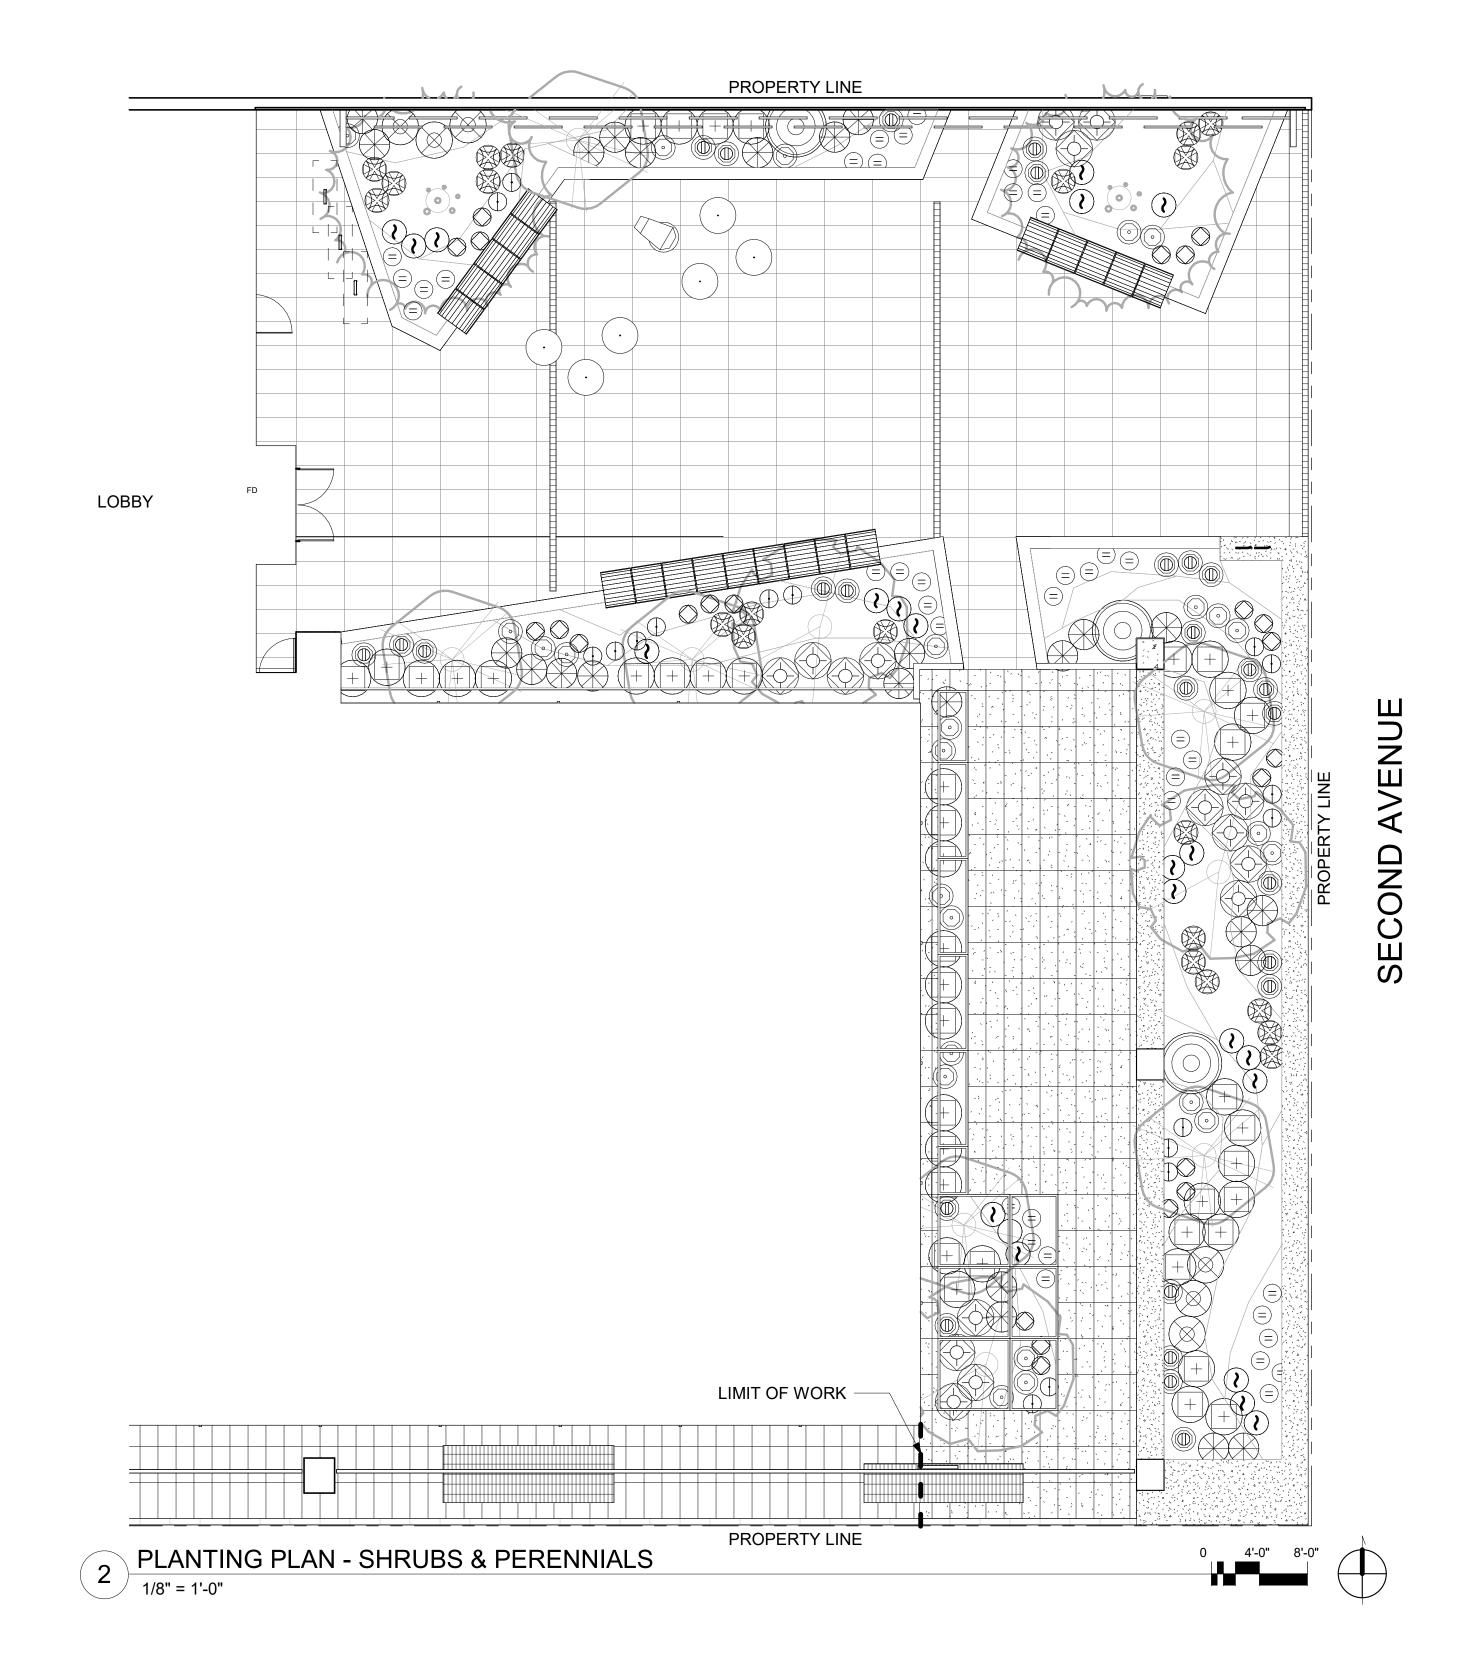


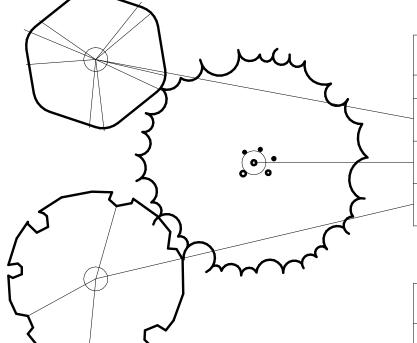


PLANTING SCHEDULE - TREES					
QTY	BOTANICAL NAME	COMMON NAME	SIZE	SPACING	COMMENTS
6	Acer circinatum	Vine maple	8-10' ht MS	PER PLAN	multistem - 3 stems min, min 1" cal each stem
2	Acer palmatum 'Osakazuki'	Osakazuki Japanese maple	12'-14' ht MS	PER PLAN	multistem - 3 stems min, min 2" cal each stem
3	Acer palmatum 'Seiryu'	Seiryu Japanese maple	10'-12' ht MS	PER PLAN	multistem - 3 stems min, min 1 1/2" cal each stem

		ING SCHEDULE - SHRUBS, PERENI		,	
QTY	BOTANICAL NAME	COMMON NAME	SIZE	SPACING	COMMENTS
DECIDU	OUS SHRUB				
6	Ribes sanguineum	Flowering currant	#5 POT	PER PLAN	
EVERGF	REEN SHRUB				
17	Cephalotaxus harringtonia 'Duke Gardens'	Duke Gardens plum yew	#5 POT	PER PLAN	
25	Mahonia nervosa	Cascade barberry	#2 POT	PER PLAN	
3	Pinus contorta 'Spaan's Dwarf'	Dwarf shore pine	#7 POT min.	PER PLAN	4-6' HT MIN.
41	Viburnum davidii	David viburnum	#5 POT	PER PLAN	
PERENN	IIAL			•	
39	Achillea millefolium 'Rosa Maria'	Rosa Maria yarrow	#1 POT	PER PLAN	
17	Anemone sylvestris	Snowdrop windflower	#1 POT	PER PLAN	
23	Aquilegia vulgaris 'Clementine Rose'	Clementine Rose columbine	#1 POT	PER PLAN	
_21	Dicentra formosa	Bleeding heart	#2 POT	PER PLAN	
25	Helleborus niger 'Double Fantasy'	Winter Dreams Double Fantasy Hellebore	#2 POT	PER PLAN	
22	Hosta x 'Guacamole'	Guacamole Hosta	#1 POT	PER PLAN	
27	Schizostylis coccinea 'Alba'	White Kaffir lily	#1 POT	PER PLAN	

	PLANTING SCHEDULE - GROUNDCOVER					
	QTY	BOTANICAL NAME	COMMON NAME	SIZE	SPACING	COMMENTS
\(\frac{1}{2}\) \(\frac{1}\) \(\frac{1}{2}\) \(\frac{1}2\) \(\frac{1}2\) \(\frac{1}2\) \(\frac{1}2\) \(1	39	Bergenia 'Bressingham White' *	Bressingham White heartleaf bergenia	#2 pot	18" o.c.	
	143	Blechnum spicant *	Deer fern	#2 pot	18" o.c.	
	176	Carex oshimensis 'Everlime' *	Everlime sedge	#1 pot	18" o.c.	
	28	Geranium x cantabrigiense 'Biokovo'	Cranesbill geranium	#2 pot	24" o.c.	
	458	Liriope muscari 'Royal Purple' *	Royal Purple lilyturf	#1 pot	18" o.c.	
	207	Polystichum munitum	Sword fern	#1 pot	18" o.c.	

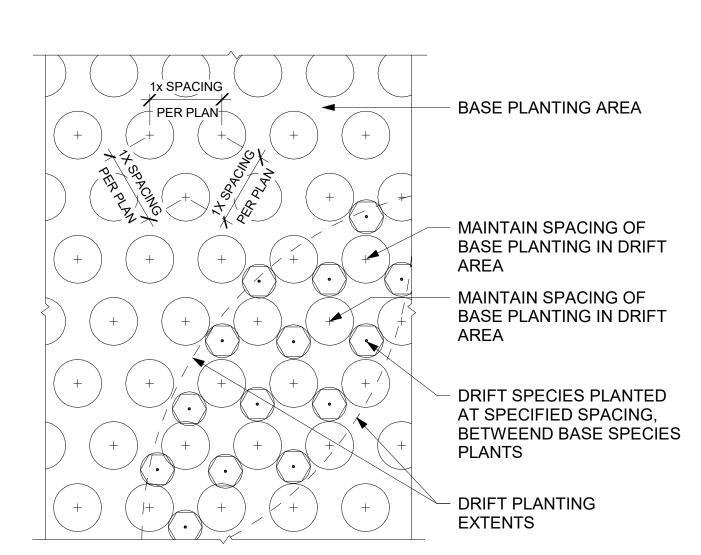




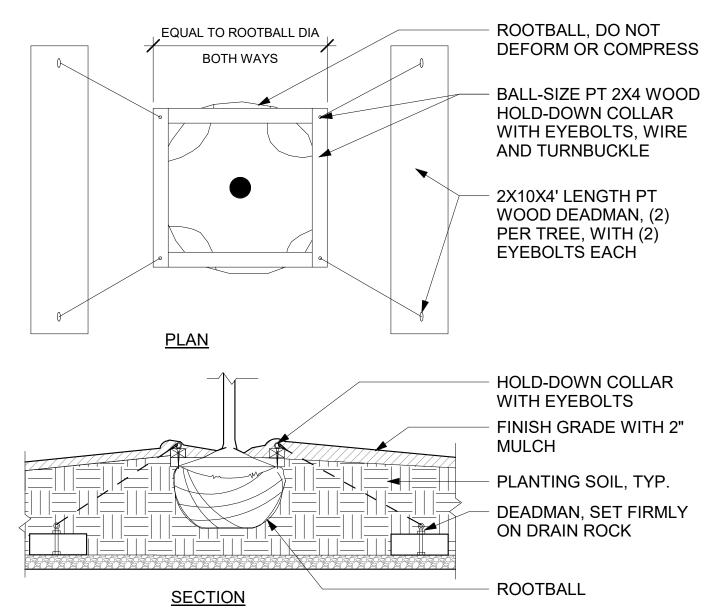


TREE STAKING ON STRUCTURE 3/4" = 1'-0"



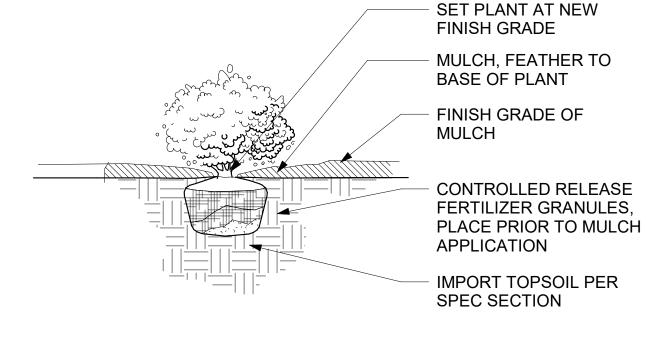



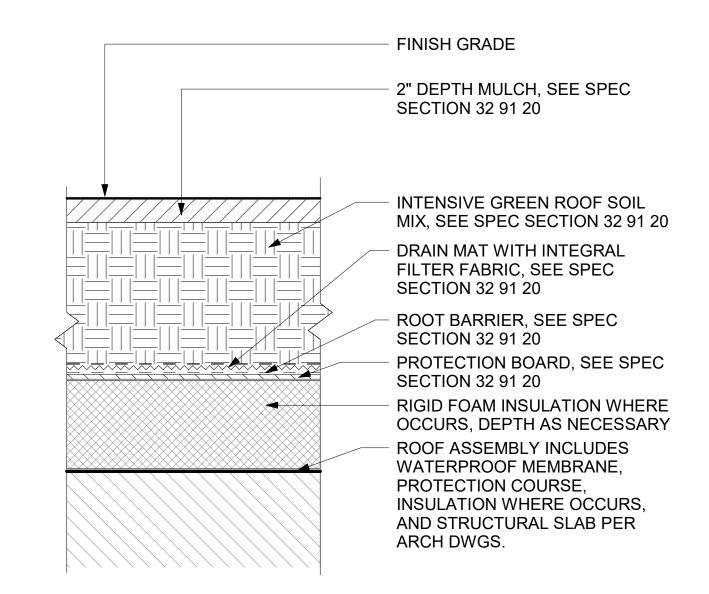

INTENSIVE PLANTING AREA SECTION - WITH FOAM 1 1/2" = 1'-0"



HINES

NORTON BUILDING **MODERNIZATION**

801 Second Ave Seattle, WA 98104

Submittal

DESIGN

DEVELOPMENT

Revisions Date Description 08/31/2023 PERMIT SUBMITTAL 09/07/2023 DESIGN DEVELOPMENT

Sheet Owner


LMN Proj No

0 8" 1'-4"

PLANTING SCHEDULE & **DETAILS**

Sheet Number

LIGHTING FOR CONSECUTIVE TREES IN A ROW TO ALIGN WITH ONE ANOTHER TREE UPLIGHT, SEE LIGHTING PLANS AND SPECS ROOTBALL TRUNK 7 TREE UPLIGHT
1/4" = 1'-0"

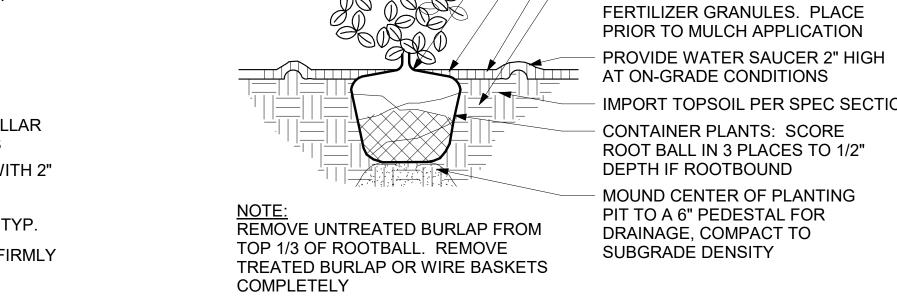

NOTES:

PLANTING

±18", TYP.

1. DIG PLANTING PITS DOWN AND OUTWARD SO THAT WATER WILL NOT

3. UNCOIL TWISTED OR CIRCULATING ROOTS PRIOR TO PLANTING. CUT

STAKING PER SPECS, TYP SET CROWN OF TREE 2" - 3"

ABOVE LEVEL OF EXISTING

— 3-4" HIGH MULCH SAUCER - FINISH GRADE OF MULCH

OF ROOT BALL

SOILS AS PER

MULCH TYPE AND DEPTH AS PER ARBORIST SPECIFICATIONS. HOLD

MULCH 3" CLEAR FROM TRUNK

REMOVE ALL WRAPPINGS FROM

TOP 1/3 OF ROOTBALL. LEAVE

WIRE BASKET ON BOTTOM 2/3

SPECIFICATIONS
SCARIFY SIDES OF TREE PIT

MOUNT CENTER OF PLANTING

PRUNE TO REMOVE ONLY DEAD

INSTALL 1" ABOVE CONTAINER

- MULCH PER SPECS, HOLD BACK 2"

OR DAMAGED BRANCHES

- FINISH GRADE OF MULCH

CONTROLLED RELEASE

CLEAR FROM STEM

PIT TO A 10" PEDESTAL FOR

DRAINAGE; COMPACT TO

SUBGRADE DENSITY.

BACKFILL AND COMPACT

TO PREVENT GLAZING

4. REMOVE ANY AND ALL PLASTIC FROM ROOTBALL PRIOR TO

COLLECT DIRECTLY BELOW ROOTBALL 2. SOAK PLANTING PIT PRIOR TO PLANTING

OFF ANY PERMANENTLY KINKED ROOTS

1.5 X DIA

TREE PLANTING

1 1/2" = 1'-0"

ALL SIDES, TYP.

2X ROOTBALL DIA

2 TIMES DIA.

MIN, WHEN

PLANTED IN

EXISTING

ROOT BALL DIA.

6" MIN. UNDISTURBED SOIL

 □ AT ON-GRADE CONDITIONS - IMPORT TOPSOIL PER SPEC SECTION CONTAINER PLANTS: SCORE ROOT BALL IN 3 PLACES TO 1/2" DEPTH IF ROOTBOUND MOUND CENTER OF PLANTING PIT TO A 6" PEDESTAL FOR DRAINAGE, COMPACT TO SUBGRADE DENSITY

IRRIGATION LEGEND

IRRIGATION POINT OF CONNECTION -RIGHT OF WAY

PRESURE REDUCING VALVE & STRAINER (USE WHEN PSI EXCEEDS 80PSI)

BACKFLOW PREVENTER

FLOW SENSOR

MASTER VALVE

QUICK COUPLER

DRIP ZONE KIT: RAIN BIRD XCZ-075-PRF FOR 0-5 GPM ZONES RAIN BIRD XCZ-100-PRF FOR 5-15 GPM ZONES IRRIGATION CONTROLLER - LEVEL P01

HARD-WIRED RAIN /FREEZE SENSOR (ONE PER CONTROLLER)

(2 PER TREE AS SHOWN)


PIPE UPTURN / DOWNTURN, SEE PLUMBING DWGS FOR LOCATION AND SIZE

AIR VACUUM RELIEF VALVE -LOCATE AT HIGH POINT OF DRIPLINE CIRCUIT

LINE FLUSHING & SHUT-OFF VALVE -LOCATE AT LOW POINT OF DRIPLINE CIRCUIT

DRIPLINE OPERATION INDICATOR - LOCATE PER DETAILS

IRRIGATION ZONE TAG KEY

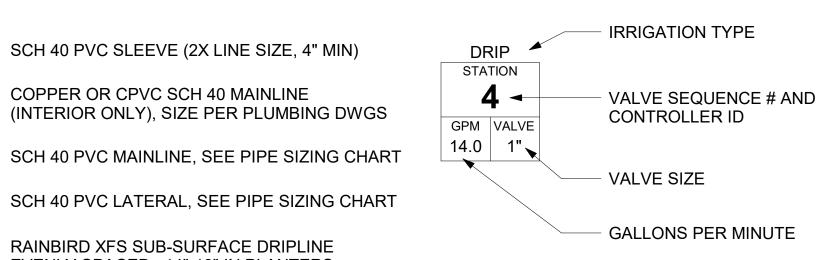

SCH 40 PVC SLEEVE (2X LINE SIZE, 4" MIN)

COPPER OR CPVC SCH 40 MAINLINE

RAINBIRD XFS SUB-SURFACE DRIPLINE

EVENLY SPACED ±14"-18" IN PLANTERS

(18" MAX) WITH 0.6GPH EMITTERS @ 12" OC

PIPE SIZING CHART SCH 40 PVC MAINLINE / LATERALS

GALLONS / MIN.	PIPE SIZE
0 - 10	3/4 INCH
10 - 16	1 INCH
16 - 26	1-1/4 INCH
26 - 35	1-1/2 INCH

IRRIGATION NOTES

- 1. PROVIDE SUB-SURFACE DRIP IRRIGATION AT ALL LANDSCAPE PLANTERS AREAS AS SHOWN.
- 2. PROVIDE TWO BUBBLERS AT NEW TREES AS SHOWN. 3. IRRIGATION SYSTEM CONNECTS TO EXISTING POINT OF CONNECTION. TEST WATER PRESSURE AT THE IRRIGATION SYSTEM POINT OF
- CONNECTION PRIOR TO BEGINNING WORK. VERIFY PRESSURE IS IN THE RANGE ANTICIPATED DURING THE DESIGN OF THE IRRIGATION SYSTEM. 4. MAINLINE TO BE 1" SIZE STUBBED TO COURTYARD AT LEVELS 01. COORDINATE LOCATION OF IRRIGATION APPURTENANCES IN WATER
- SERVICE ROOM AND MAINLINE STUBS AT COURTYARD AND ROOF WITH PLUMBER. ALL PIPING INTERIOR TO BUILDING TO BE COPPER. 5. PROVIDE IRRIGATION CONTROLLER IN WATER SERVICE ROOM #TBD, FINAL LOCATION TO BE COORDINATED WITH ARCHITECT PRIOR TO
- INSTALLATION. 6. PROVIDE BUILDING MOUNTED HARD-WIRED RAIN SENSOR CONNECTED TO CONTROLLER IN WATER SERVICE ROOM. FINAL LOCATION OF RAIN SENSOR TO BE COORDINATED WITH ARCHITECT PRIOR TO INSTALLATION.



Architecture
Urban Design
Interiors

NORTON BUILDING **MODERNIZATION**

801 Second Ave Seattle, WA 98104

Submittal

DESIGN DEVELOPMENT


Revisions PERMIT SUBMITTAL 08/31/2023


DESIGN DEVELOPMENT

Sheet Owner


09/07/2023

IRRIGATION PLAN

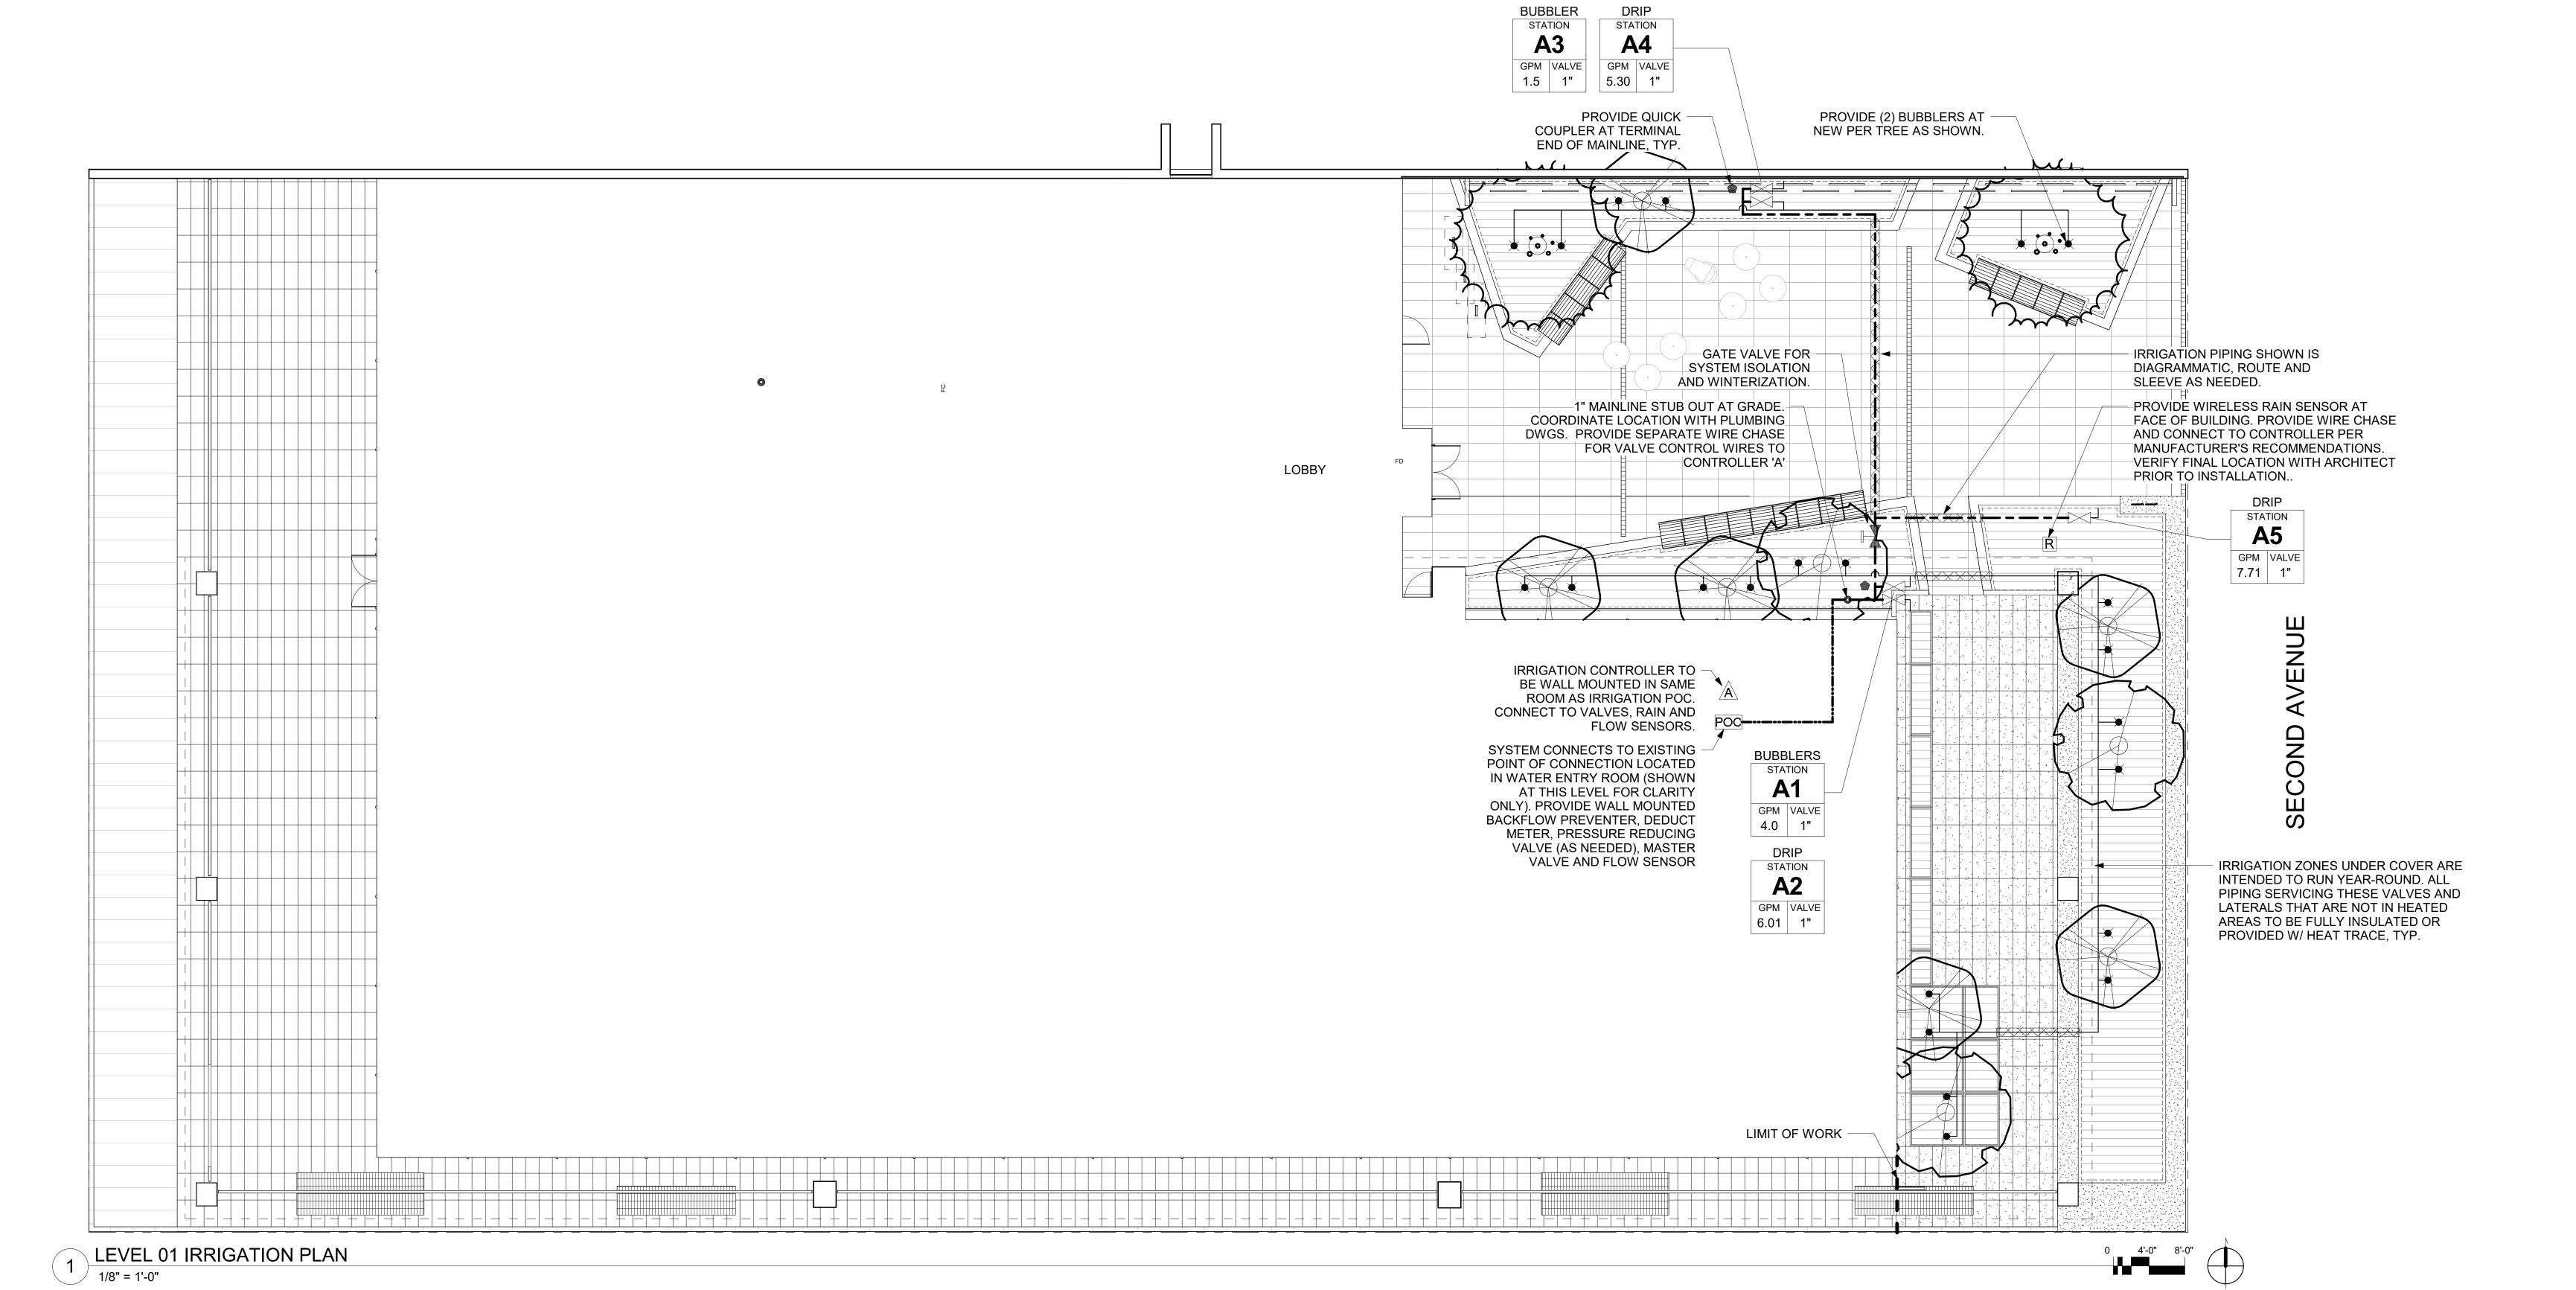

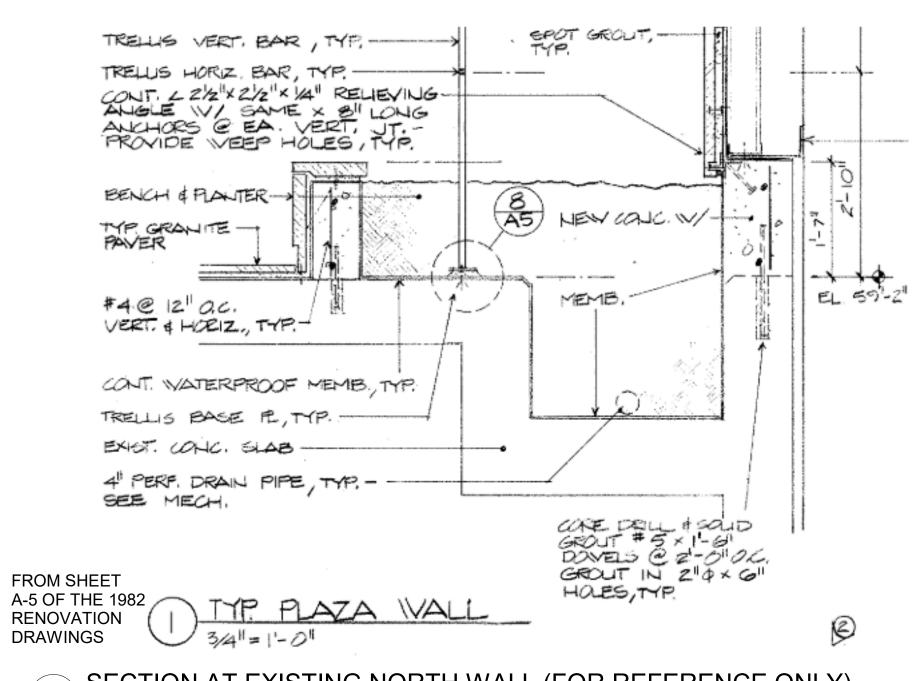


SECTION AT EXISTING NORTH WALL (FOR REFERENCE ONLY)

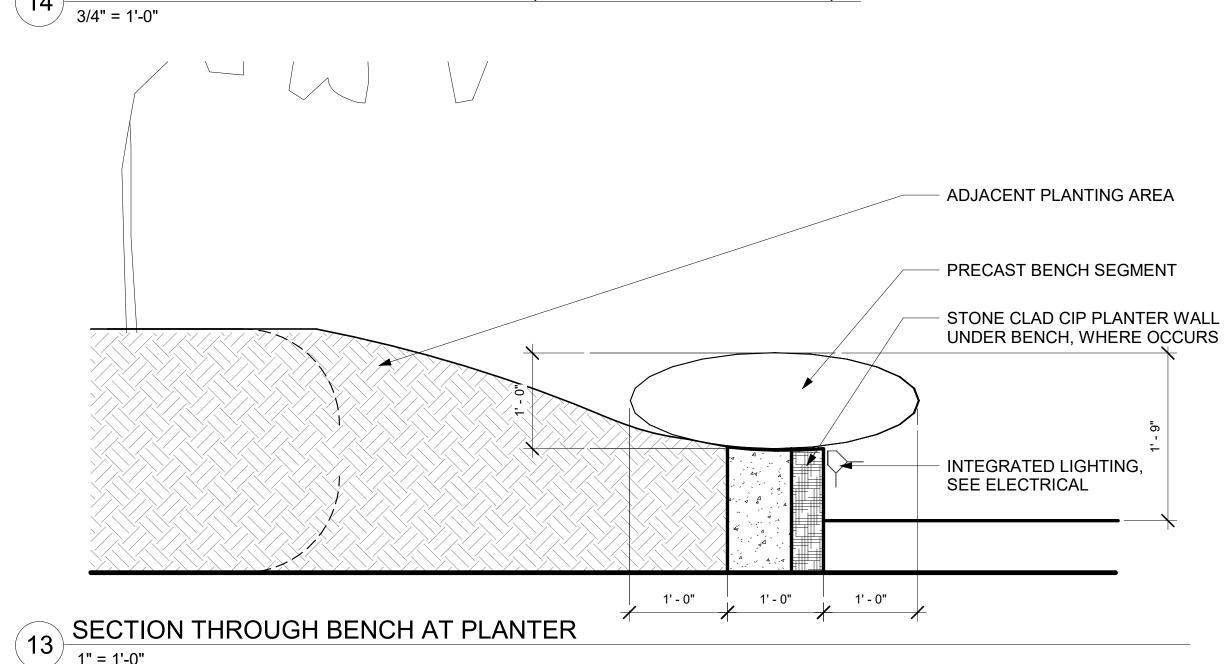


<u>PLAN</u> AJDACENT PAVEMENT **CONDITION VARIES** REBAR EMBEDMENT ANCHOR, LOCATE AT CORNERS OF FRAME PER MANUFACTURER, TYP ANGLE STOCK PERIMETER FRAME, SIZED AND FINISH TO MATCH GRATE **THICKNESS** LOCKABLE TRENCH DRAIN GRATE, 2" THK PERFORATED - FLUSH STONE PAVER ANGLE STOCK PERIMETER FRAME, SIZED AND FINISH TO MATCH GRATE THICKNESS CONTINUOUS FLAT BAR, TYP REBAR EMBEDMENT ANCHOR, LOCATE AT CORNERS OF FRAME PER MANUFACTURER, TYP 4-4-44 4 4 4 4

12 TRENCH GRATE AND FRAME - SECTION
6" = 1'-0"

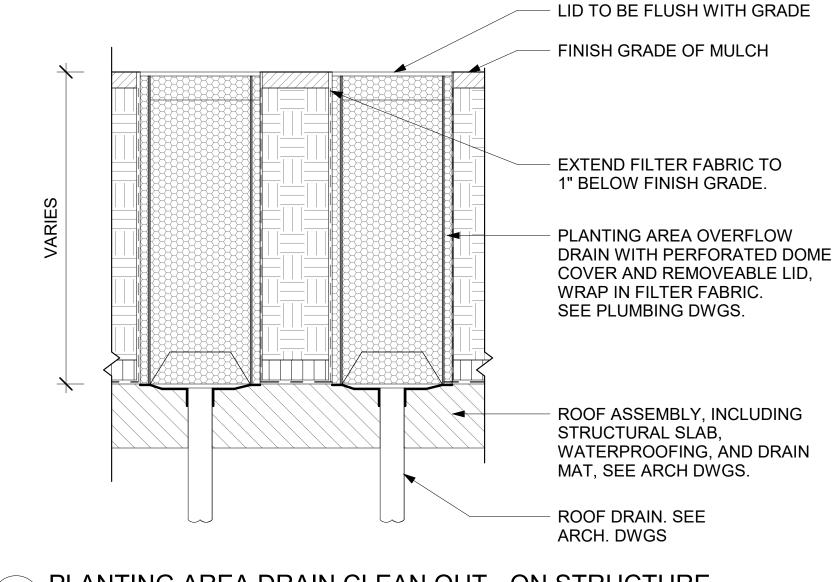

PLANTING AREA DRAIN CLEAN OUT - ON STRUCTURE 11 1" = 1'-0"

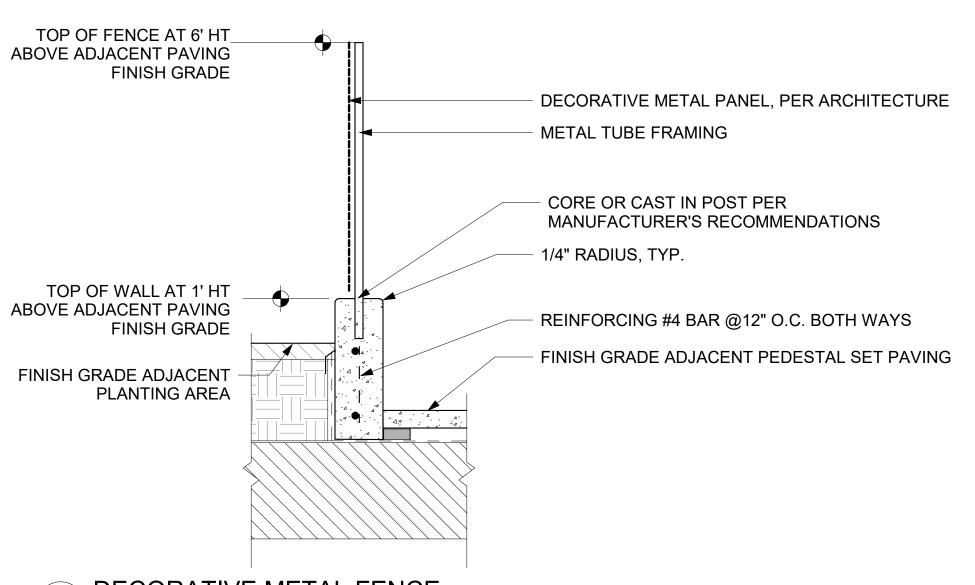


10 DECORATIVE METAL FENCE 1" = 1'-0" PREFABRICATED METAL PLANTER WALL PLANTING SOIL LINE SIDES OF PLANTER WITH DRAIN MAT, TYP. LINE BASE DRAIN ROCK WITH FILTER FABRIC, OVERLAPPING DRAIN MAT BY 3" MIN., TYP. ADJACENT FINISH 2" DEPTH OF WASHED, CLEAN DRAIN ROCK AT BASE **GRADE CONDITION** OF PLANTER VARIES, SEE MATERIALS PLAN COORDINATE PENETRATIONS FOR DRAINAGE AND IRRIGATION INSTALLATION, PROVIDE PENETRATIONS AT 4'-0" O.C., 1/EACH PER PLANTER MIN. PLANTER TO BE PLACED ON RIGID, NON-BIODEGRADABLE BLOCKING FOR SUPPORT (I.E. PVC BLOCKS, FIBERGLASS BLOCKS, OR RIGID HYDROPHOBIC FOAM) @ 24" O.C. BOTH WAYS. ENSURE POSITIVE DRAINAGE BELOW PLANTER ASSEMBLY.


ROOF ASSEMBLY INCLUDING RIGID INSULATION AND

WATERPROOFING, SLOPED TO DRAIN PER ARCH DWGS.


FREESTANDING METAL PLANTER 1 1/2" = 1'-0"

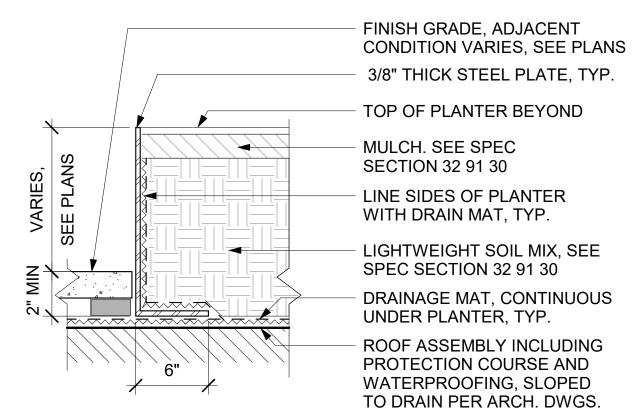

8 FABRICATED METAL PLANTER WALL ON STRUCTURE

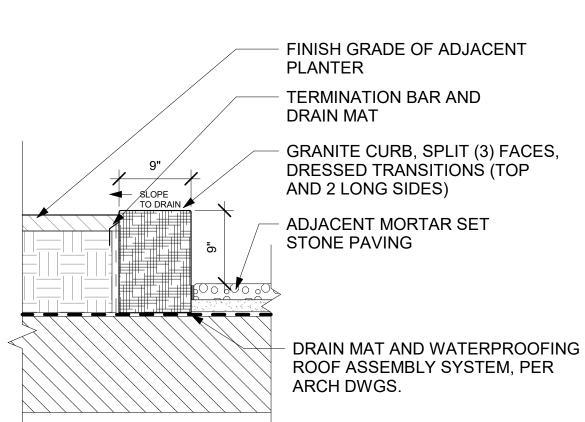


GRANITE CURB ON STRUCTURE 1" = 1'-0"

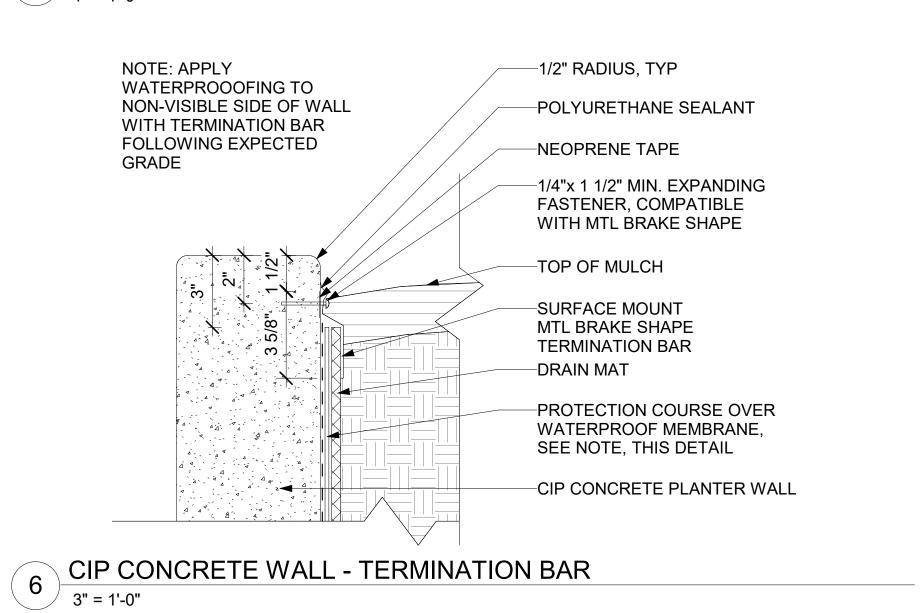


TERMINATION BAR 1/2"R, TYP. **VARIES** PLANTING SOIL SEE PLANS MULCH REINFORCEMENT, SEE STRUCTURAL DWGS DRAIN MAT AND WATERPROOFING, WRAP UP WALL FILTER FABRIC, WRAP UP INSIDE AND BOTTOM OF **EXPANSION JOINT** ADJACENT PAVING CONDITION VARIES, SEE **PLANS** ROOF ASSEMBLY SEE ARCH DWGS.


NOTES:
1. REFER TO MATERIALS LEGEND FOR FINISHES ON ALL EXPOSED VERTICAL FACES.

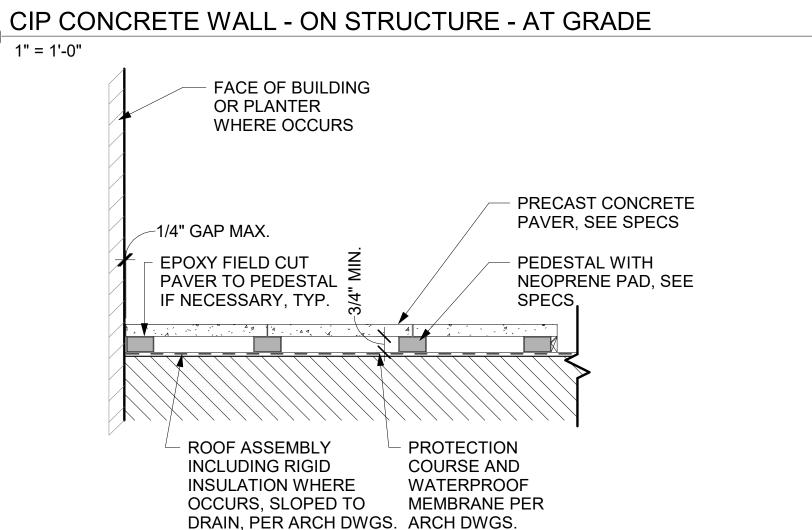

PEDESTAL PAVER - ON STRUCTURE 1" = 1'-0"

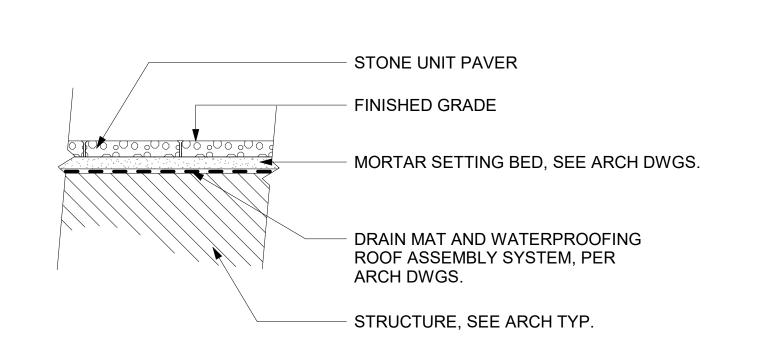

MORTAR SET PAVER - ON STRUCTURE 3/8" RADIUS SEALANT, SANDED SMOOTH ___ PREMOLDED JOINT FILLER PORTLAND CEMENT CONCRETE, SEE CIVIL, 4" MIN THICKNESS #4 SMOOTH STEEL DOWEL 6'-0" OC INSTALL AT EXPANSION JOINTS, OMIT AT ISOLATION JOINTS SLEEVE (ONE END OF DOWEL) INSTALL AT EXPANSION JOINTS, **OMIT AT ISOLATION JOINTS** SUB BASE CONDITIONS VARIES

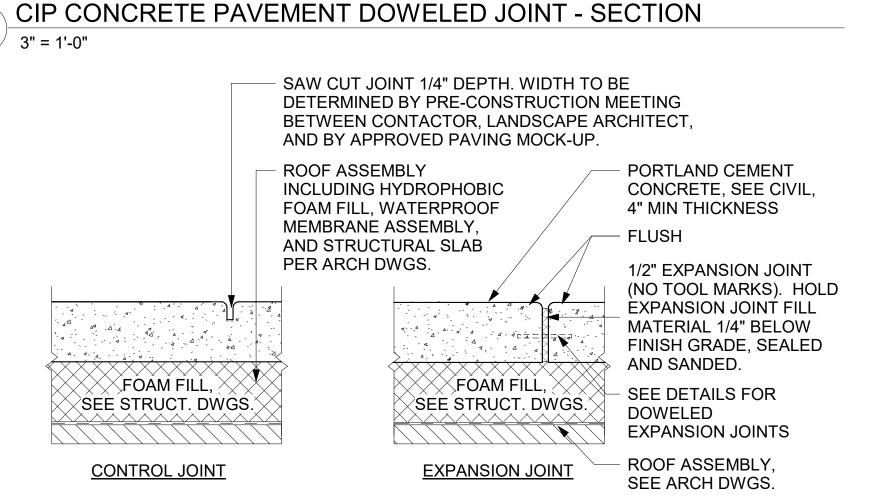

NOTES:

1. SEE LAYOUT PLANS FOR PAVEMENT JOINTING. 2. SLOPE PAVEMENT TO DRAIN.

3. PROVIDE EXPANSION JOINT AT EDGE OF PAVING, SITE WALLS, BUILDING, AND OTHER VERTICAL ELEMENTS.

CIP CONCRETE SCORING AND JOINTING - ON STRUCTURE 3/4" = 1'-0"



801 Second Avenue, Suite 501 Seattle, Washington 98104 T 206 682 3460 www.lmnarchitects.com

HEWITT architecture

(206) 626-0541

Professional Seal

NORTON BUILDING **MODERNIZATION**

801 Second Ave Seattle, WA 98104

Submittal

DESIGN DEVELOPMENT

Revisions Description PERMIT SUBMITTAL 08/31/2023

DESIGN DEVELOPMENT

09/07/2023

Sheet Owner

LMN Proj No

SITE DETAILS

Sheet Number



DEMOLITION NOTES

1. DEMOLITION DRAWINGS INDICATE THE GENERAL EXTENT OF ALTERATIONS REQUIRED. THESE DOCUMENTS DO NOT NECESSARILY SHOW EVERYTHING TO BE REMOVED IN ORDER TO PREPARE THE EXISTING BUILDING FOR NEW CONSTRUCTION.

2. THE CONTRACTOR SHALL FIELD VERIFY ALL EXISTING & SURROUNDING CONDITIONS PRIOR TO COMMENCEMENT OF WORK. CONTRACTOR TO NOTIFY ARCHITECT OF ANY DISCREPANCIES AND REQUEST CLARIFICATION FROM THE ARCHITECT & OWNER FOR ANY WORK IN QUESTION, PRIOR TO REMOVAL.

3. IN CASES OF INTERCONNECTION OF NEW WORK WITH EXISTING, THE CONTRACTOR SHALL FIELD VERIFY ALL DATA (DIMENSIONS, ELEVATIONS, GRADES, ETC.) OF EXISTING CONDITIONS. CONTRACTOR SHALL BE RESPONSIBLE FOR RECTIFYING ALL COORDINATION OR OTHER ISSUES ARISING FROM FAILURE TO VERIFY EXISTING CONDITIONS.

4. IT IS THE CONTRACTORS RESPONSIBILITY TO LOCATE AND REMOVE ALL MECHANICAL, ELECTRICAL AND MISC. EQUIPMENT AS REQUIRED TO COMPLETE THE WORK. REFER TO TO MECH, ELEC, PLUMB & STRUCT DRAWINGS FOR ADDITIONAL INFORMATION.


5. THE CONTRACTOR SHALL COORDINATE WITH THE OWNER PRIOR TO DICONNECTING ANY OPERATING EQUIPMENT, SERVICES OR UTILITIES. PROVIDE TEMP SERVICE OR EQUIPMENT TO SUPPLY UNINTERUPTED SERVICES TO THE EXISTING BUILDING, ROOM OR EQUIPMENT.

6. CONTRACTOR TO PROTECT ALL CONDITIONS TO REMAIN, THROUGHOUT THE DURATION OF CONSTRUCTION. ANY ITEMS DAMAGED OR IMPACTED DURING CONSTRUCTION SHALL BE REPAIRED OR REPLACED TO MATCH EXISTING CONDITION.

7. CONTRACTOR TO PATCH & REPAIR ALL SURFACES IMPACTED BY DEMOLITION TO MATCH SURROUNDING FINISH CONDITIONS. NEW FINISH TO MATCH EXISTING IN COLOR, TEXTURE & THICKNESS, ETC. TO SATISFACTION OF OWNER.

8. AT PENETRATIONS OF FIRE RATED WALLS, CEILINGS, FLOORS OR ROOF, COMPLETELY SEAL VOIDS WITH FIRE RATED CONSTRUCTION FOR FULL THICKNESS OF THE EXISTING ELEMENT TO MAINTAIN RATING IN ACCORDANCE WITH AHJ.

DEMOLITION LEGEND

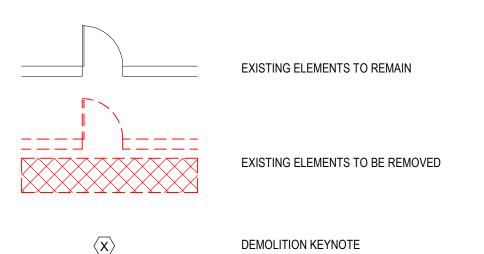


DEMOLITION NOTES

- DEMO EXISTING STONE FLOORING, MORTAR BED, AND CARPETING COMPLETELY. PATCH/REPAIR EXISTING CONCRETE TO RECEIVE NEW FLOOR FINISH.
- DEMO EXISTING STONE PAVERS, MORTAR BED AND WATERPROOFING COMPLETELY.
- REMOVE EXISTING STONE WALL FINISH AND LIGHT GAUGE FRAMING COMPLETELY. REMOVE AND
- (4) REMOVE EXISTING WALL FINISH COMPLETELY.
- 5 DEMO EXISTING RAISED PLANTERS COMPLETELY.
- 6 DEMO STEEL TRELLIS COMPLETELY.

SALVAGE STONE TILES.

- DEMO EXISTING POLE LIGHTS COMPLETELY.
- DEMO EXISTING MONUMENT SIGNS COMPLETELY.
- DEMO EXISTING INTERIOR WALL COMPLETELY.
- DEMO EXISTING DOOR AND FRAME COMPLETELY.

 REMOVE EXISTING PLUMBING FIXTURES COMPLETELY.
- REMOVE EXISTING LIGHTING FIXTURES COMPLETELY. PATCH AND REPAIR GYP CEILING WHERE REQUIRED. EXISTING CAMERAS, GRILLES, EXIT SIGNAGE TO REMAIN.
- (13) REMOVE EXISTING SIGNAGE.
- ALTERNATE A: DEMO OLD LMN SHOP ITEMS INCLUDING SINK WITH EYEWASH STATION, PAINT HOOD TABLE, LASER HOODS, 3D PRINTER HOOD, ASSOCIATED FILTERS AND BLOWER, AND THE ASSOCIATED EXHAUST DUCTWORK THAT IS IN THE CORRIDOR TO THE LOADING DOCK. INCLUDE MARKUPS AND DUMP
- 15 FIRST FLOOR TENANT PINK GRANITE WALL AND FAUX COLUMN TO REMAIN.
- (16) ALTERNATE: DEMOLISH CEILING AND LIGHT FIXTURES COMPLETELY.

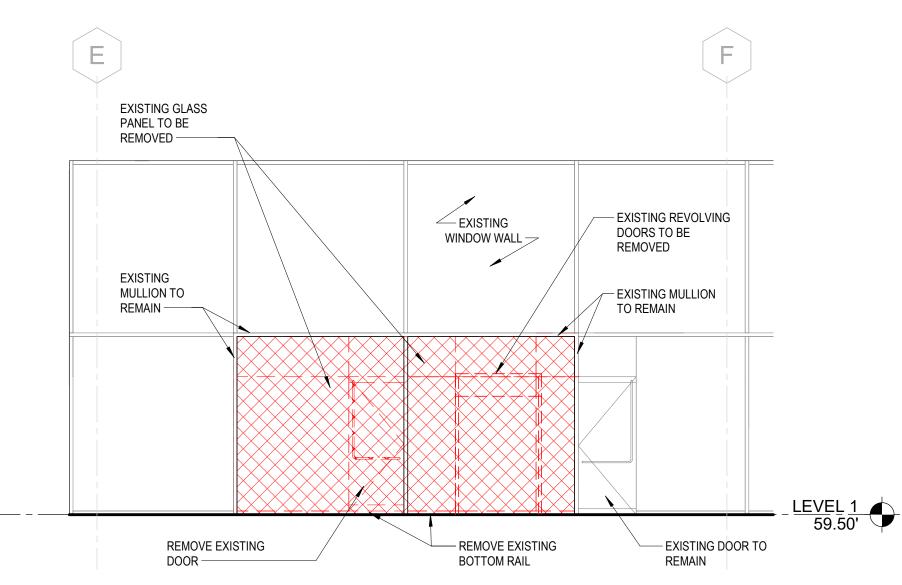

2 LOBBY ELEVATION - DEMO 2 AD003 3/16" = 1'-0" Architecture
Urban Design

801 Second Avenue, Suite 501 Seattle, Washington 98104 T 206 682 3460 www.lmnarchitects.com

.....

IES

NORTON BUILDING MODERNIZATION

801 Second Avenue Seattle, WA 98104

DESIGN

Submittal

DEVELOPMENT

Revisions
Date Description
09/07/23 DD SET

neet Owner Author
AN Proj No 22004-01


ate 09/07/2023heet Title

Sheet little

LEVEL 1 DEMOLITION PLAN

Sheet Number

2.AD003

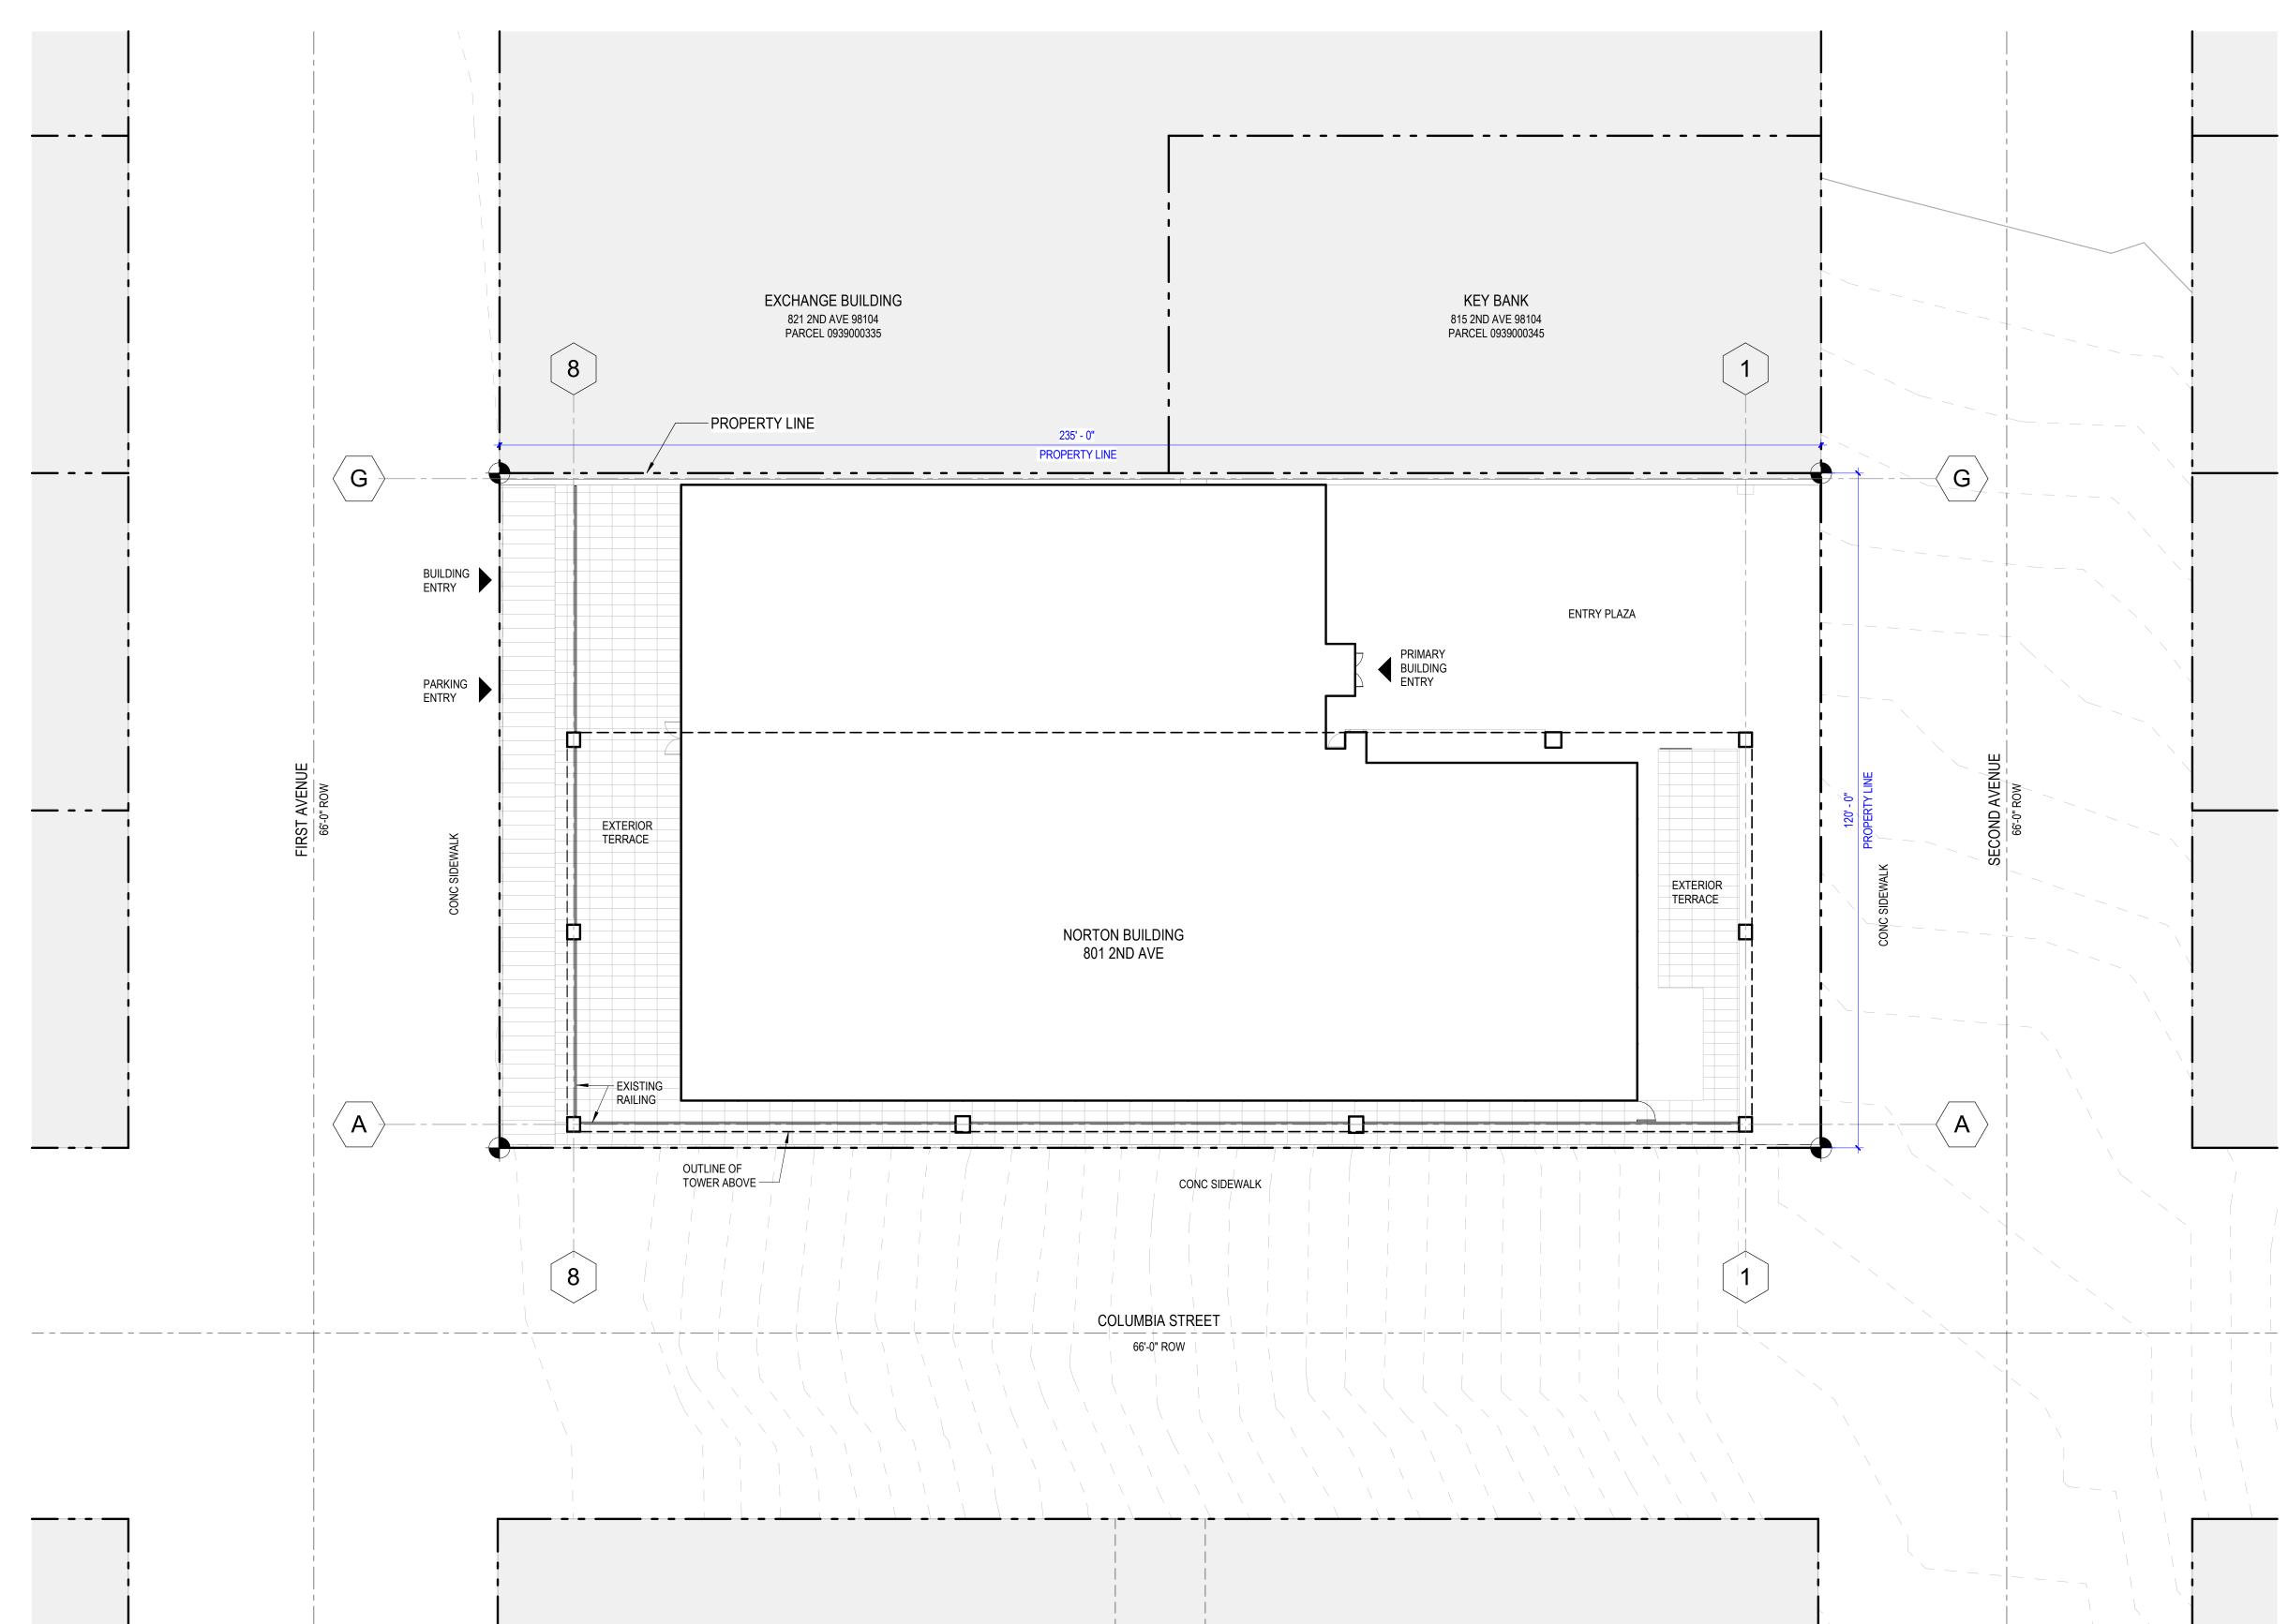

SITE INFORMATION NORTON BUILDING 801 SECOND AVENUE SEATTLE, WA 98104 PROJECT ADDRESS: PARCEL NUMBER: LEGAL DESCRIPTION: 093900-0355 BOREN AND DENNYS ADD LESS ST & POR OF VAC ALLEY ADJ (VO 56715) PLAT BLOCK: PLAT LOT: 5 THRU 8 **ZONING:** DMC 340 / 290-440 BUILDING OCCUPANCY: CONSTRUCTION TYPE: B/S 1-A LOT AREA: TOTAL BUILDING AREA: 28,200 SF 214,800 GSF

UNLIMITED

17 STORIES + 1 STORY BELOW GRADE

MAXIMUM ALLOWED BUILDING AREA:

NUMBER OF STORIES:

801 Second Avenue, Suite 501
Seattle, Washington 98104
T 206 682 3460
www.Imnarchitects.com

Professional
Seal

AHJ Review
Stamp

NORTON BUILDING MODERNIZATION

801 Second Avenue Seattle, WA 98104

DESIGN DEVELOPMENT

Revisions
Date Desc

Descrip 23 DD SE

Sheet Owner
LMN Proj No

Proj No 22004-01 09/07/202


Sheet Title


SITE PLAN


Sheet Number

2.A011

5 SITE PLAN 2.A011 1/16" = 1'-0"

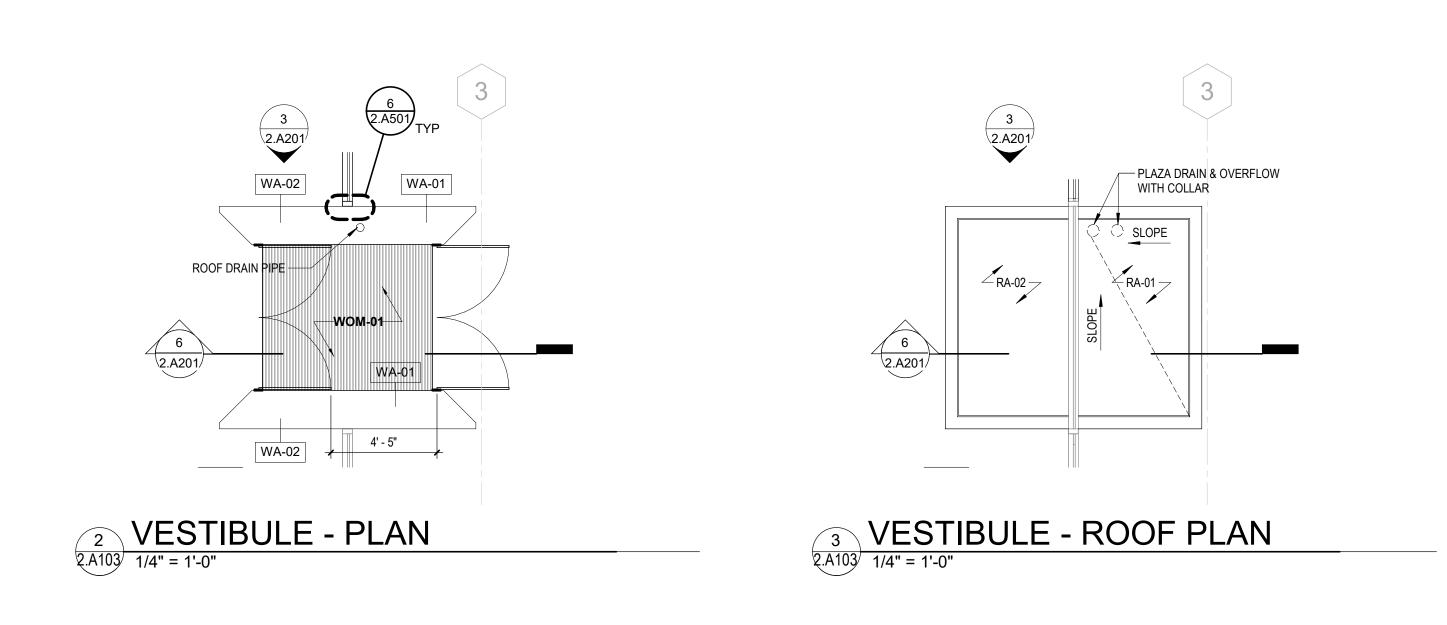

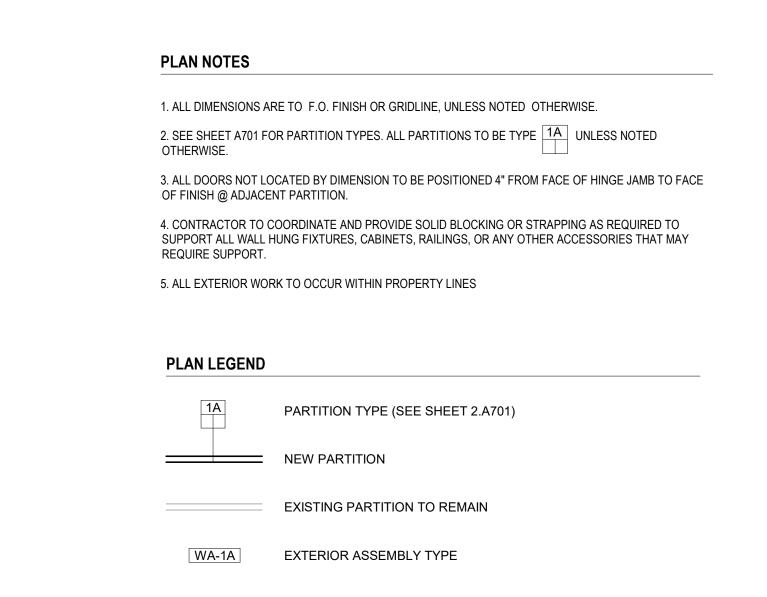

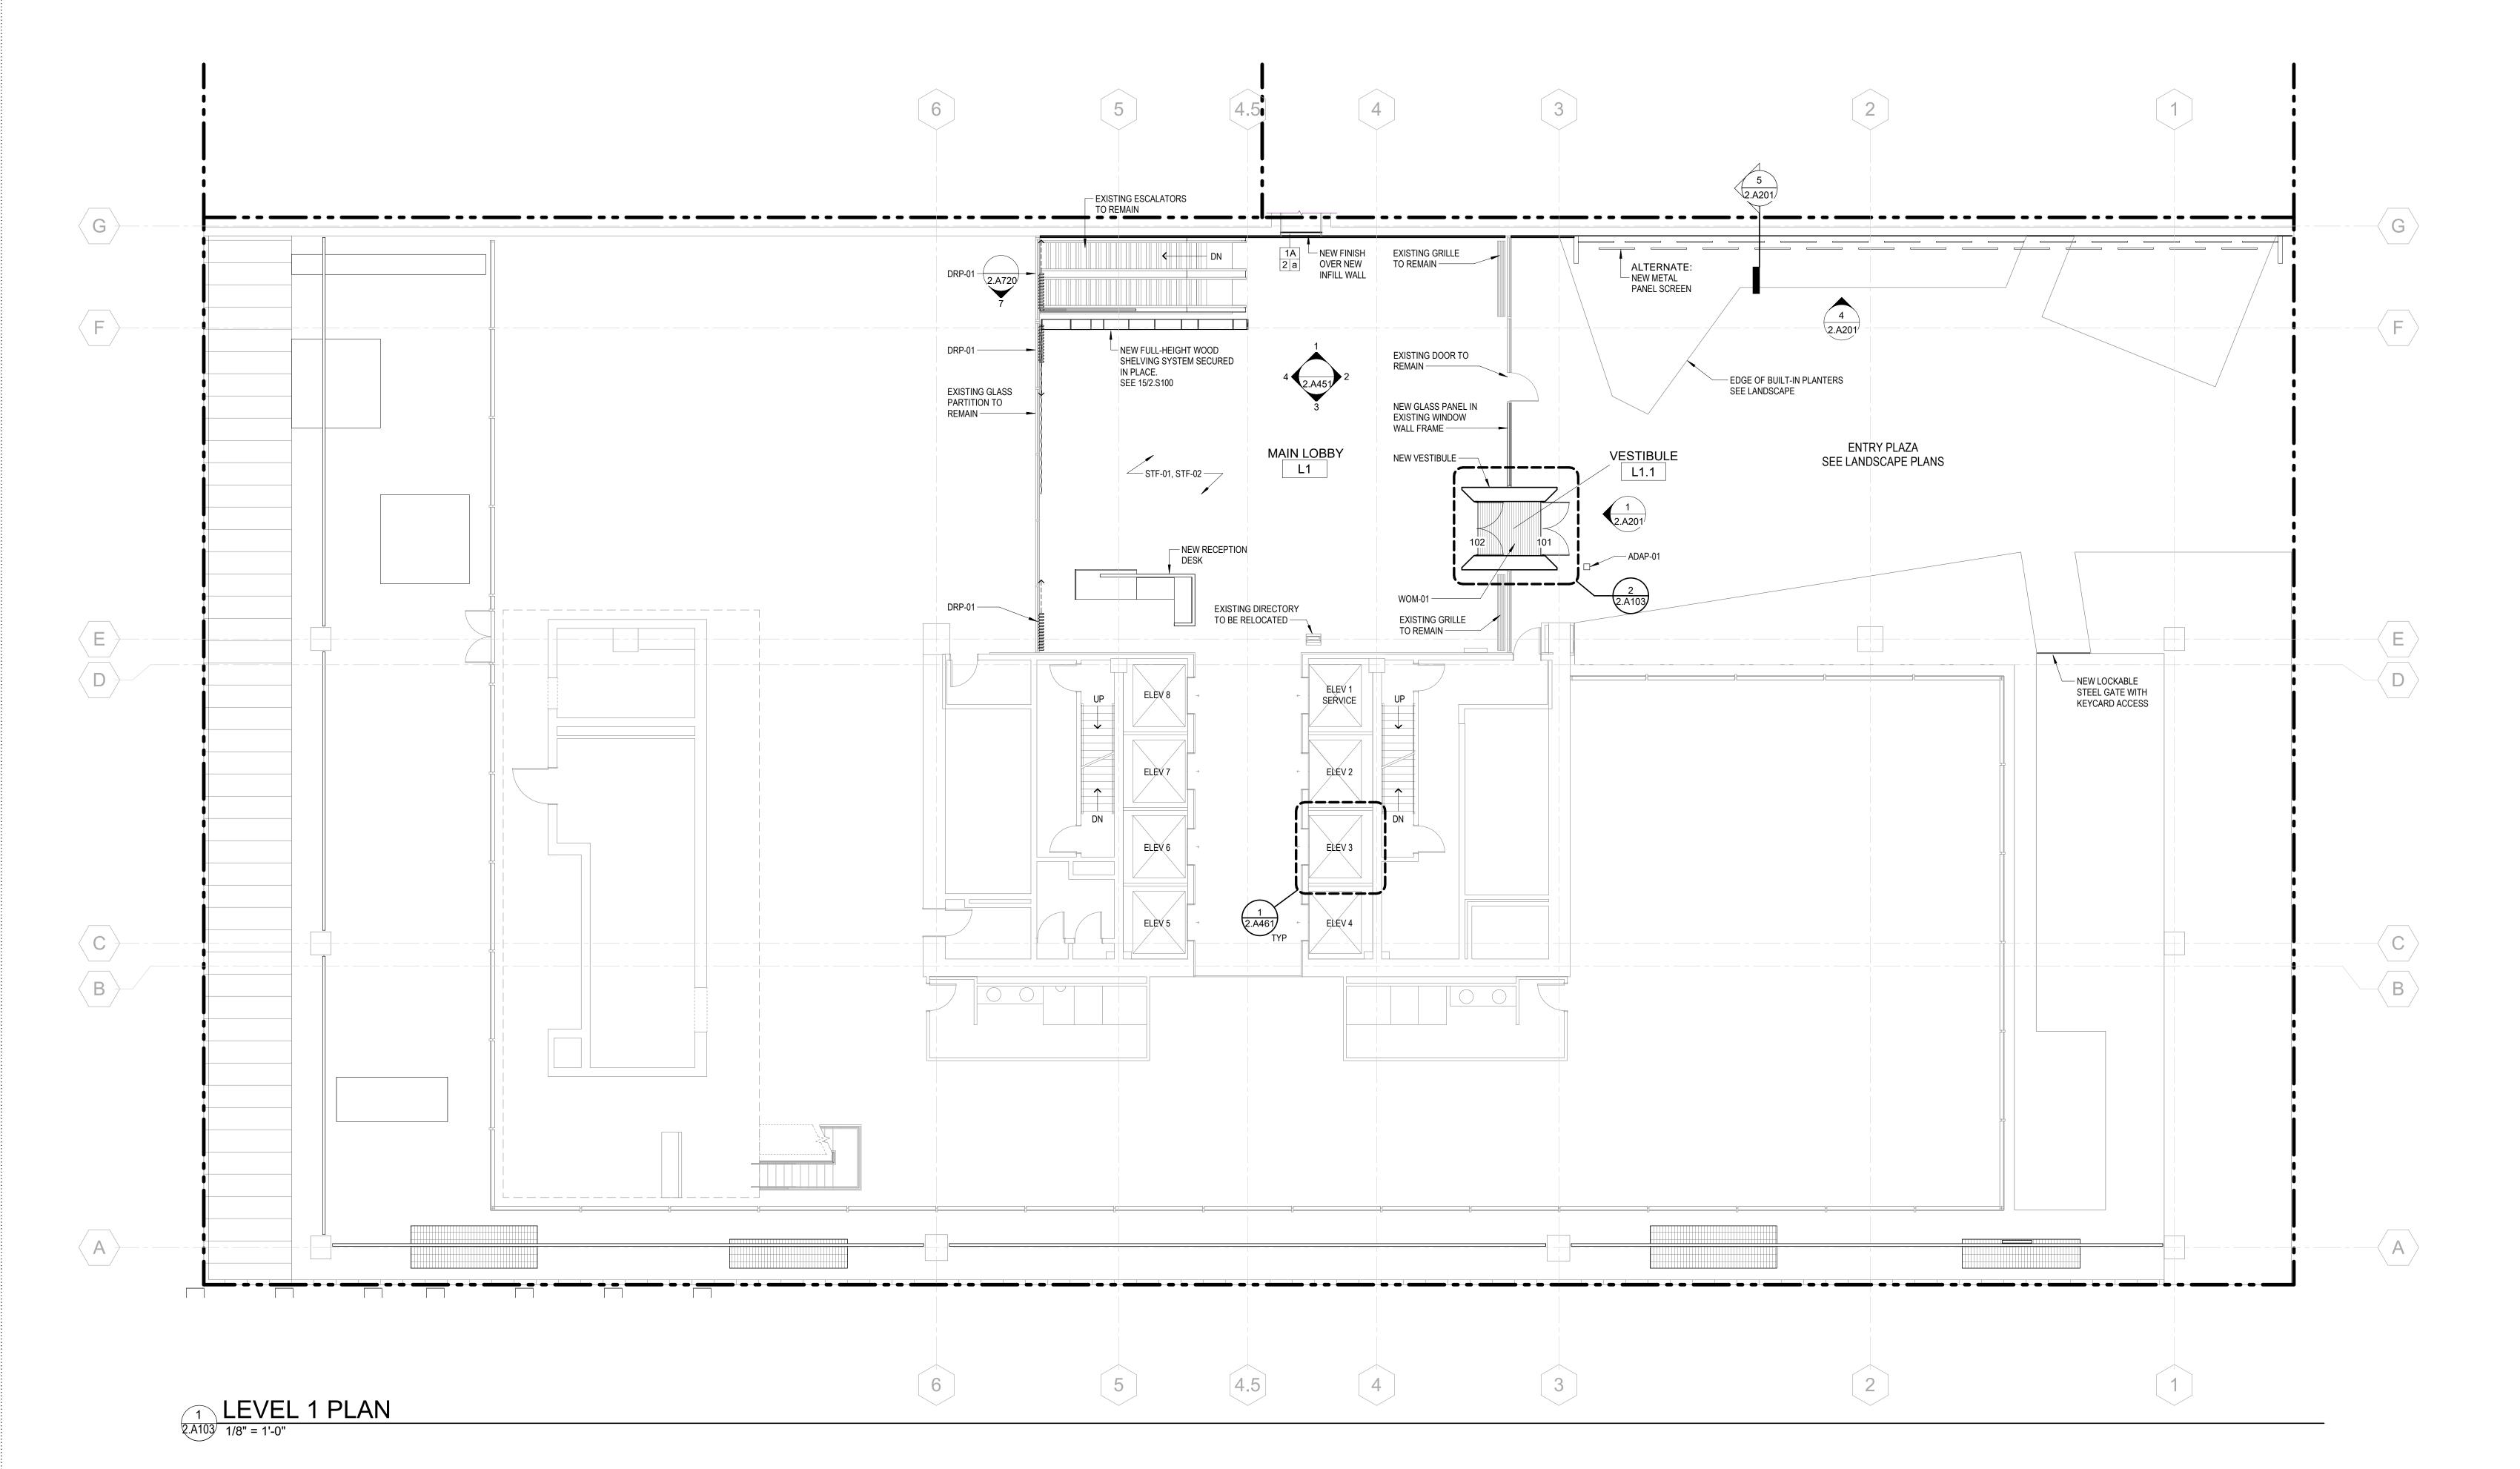



Architecture
Urban Design
Interiors

801 Second Avenue, Suite 501 Seattle, Washington 98104 T 206 682 3460 www.lmnarchitects.com

rofessional

AHJ Review Stamp

ΞS

NORTON BUILDING MODERNIZATION

801 Second Avenue Seattle, WA 98104

Submittal

DESIGN DEVELOPMENT

Revisions

Date Description
09/07/23 DD SET

Sheet Owner


LMN Proj No 22004-01


Date 09/07/202


Sheet Title

LEVEL 1 FLOOR PLAN

Sheet Number

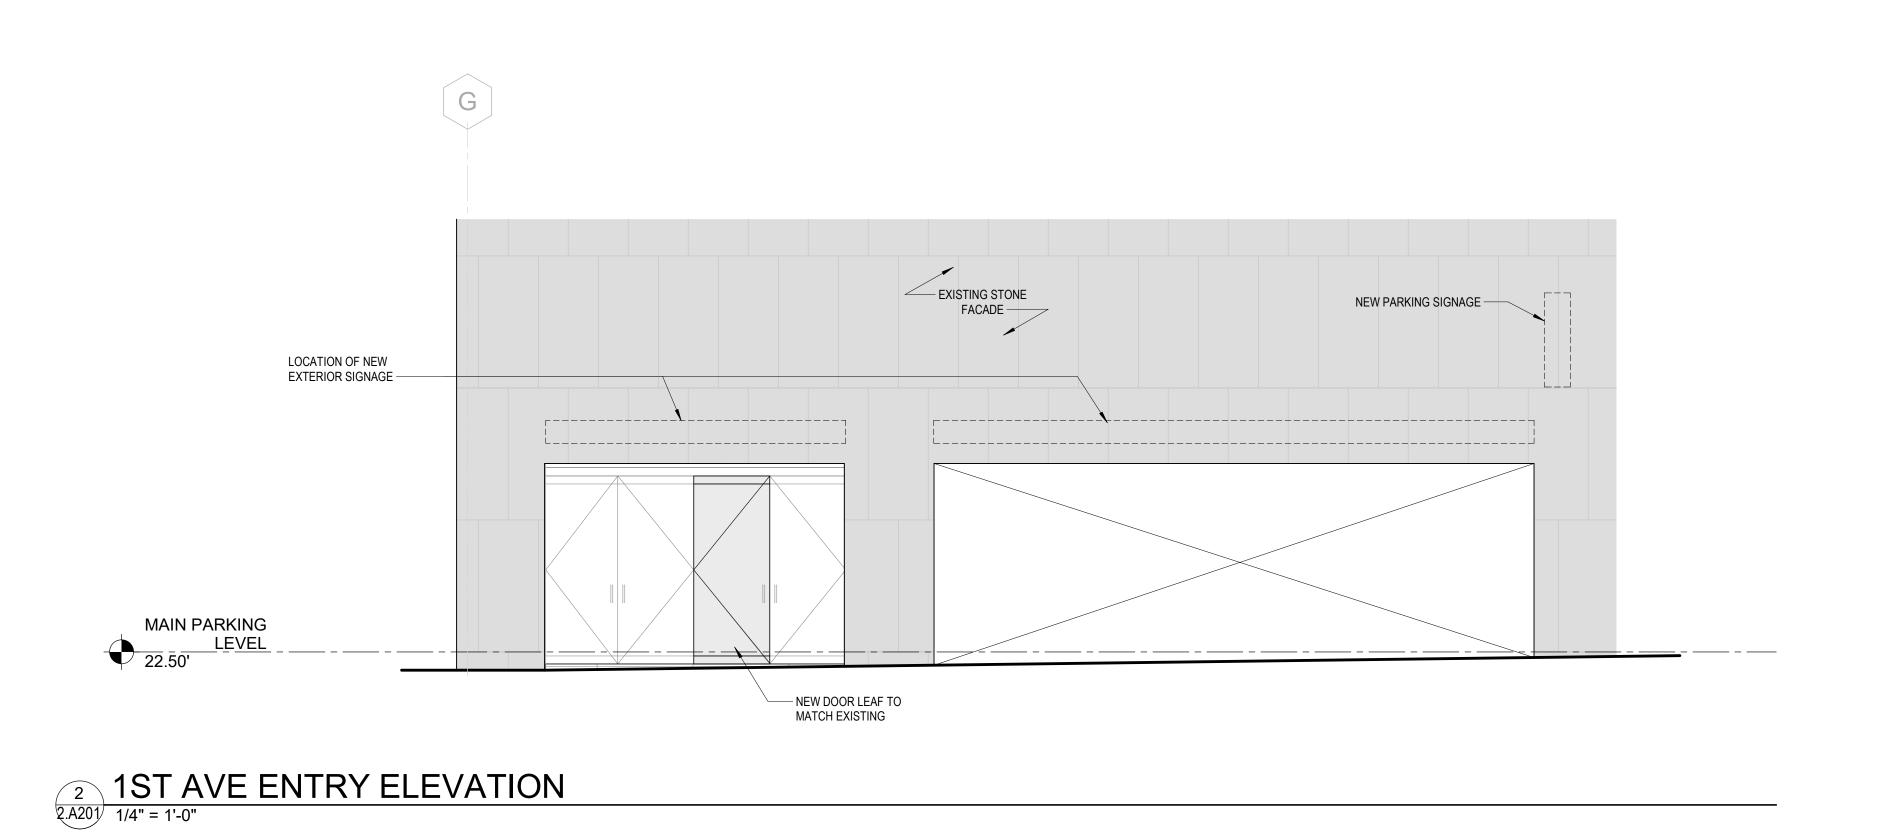

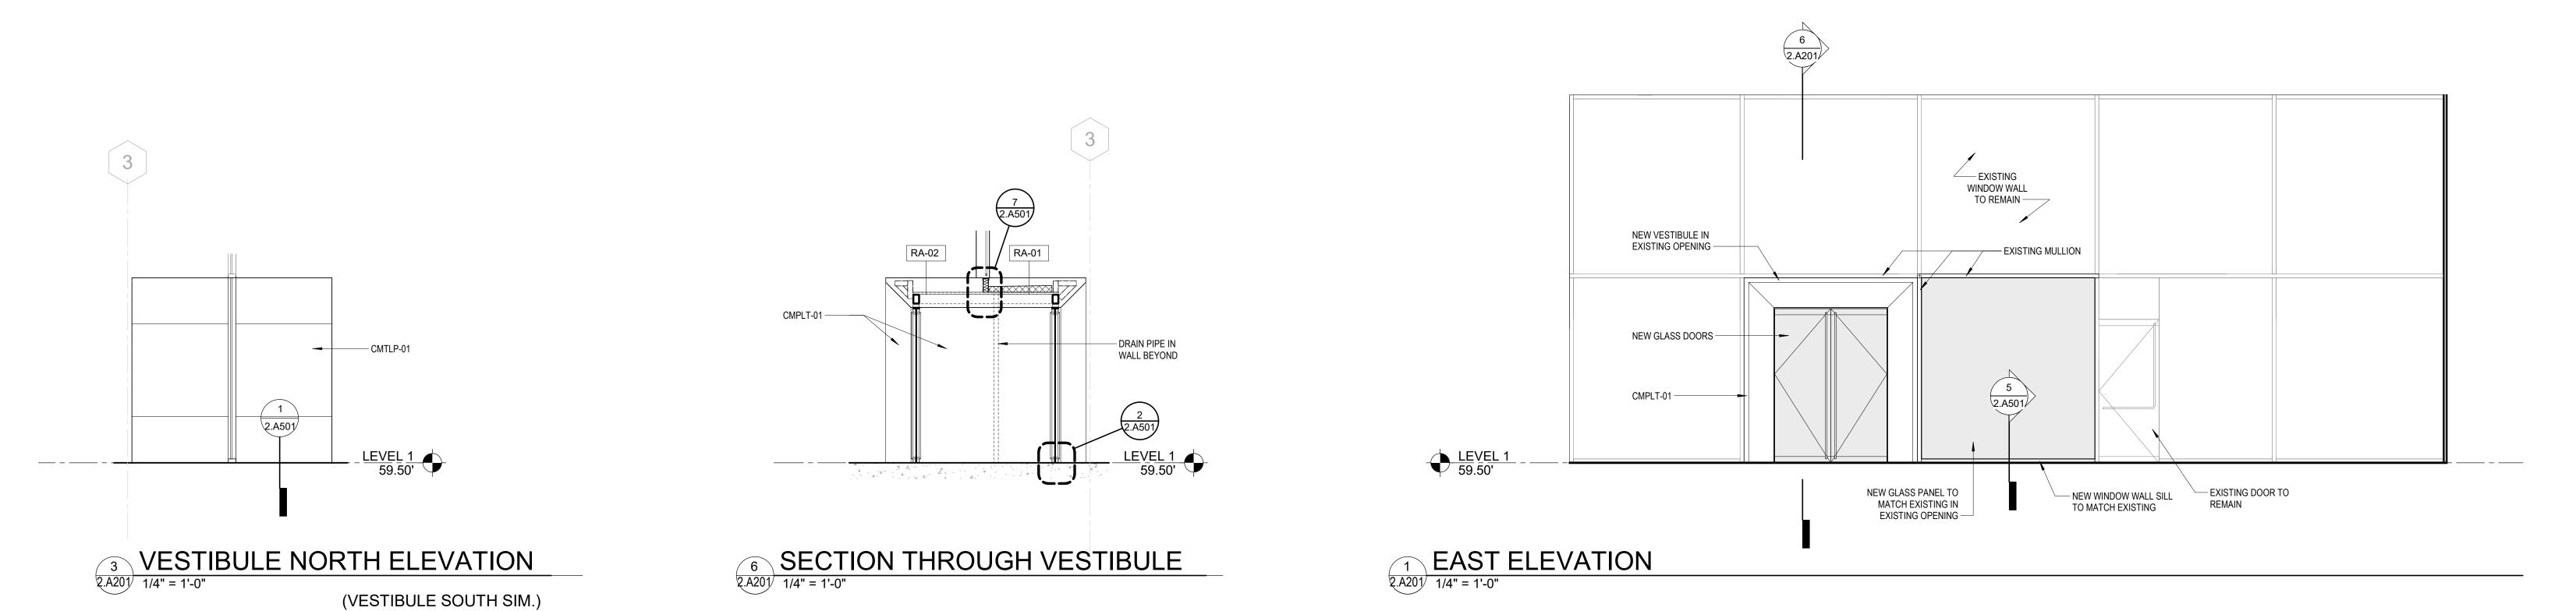

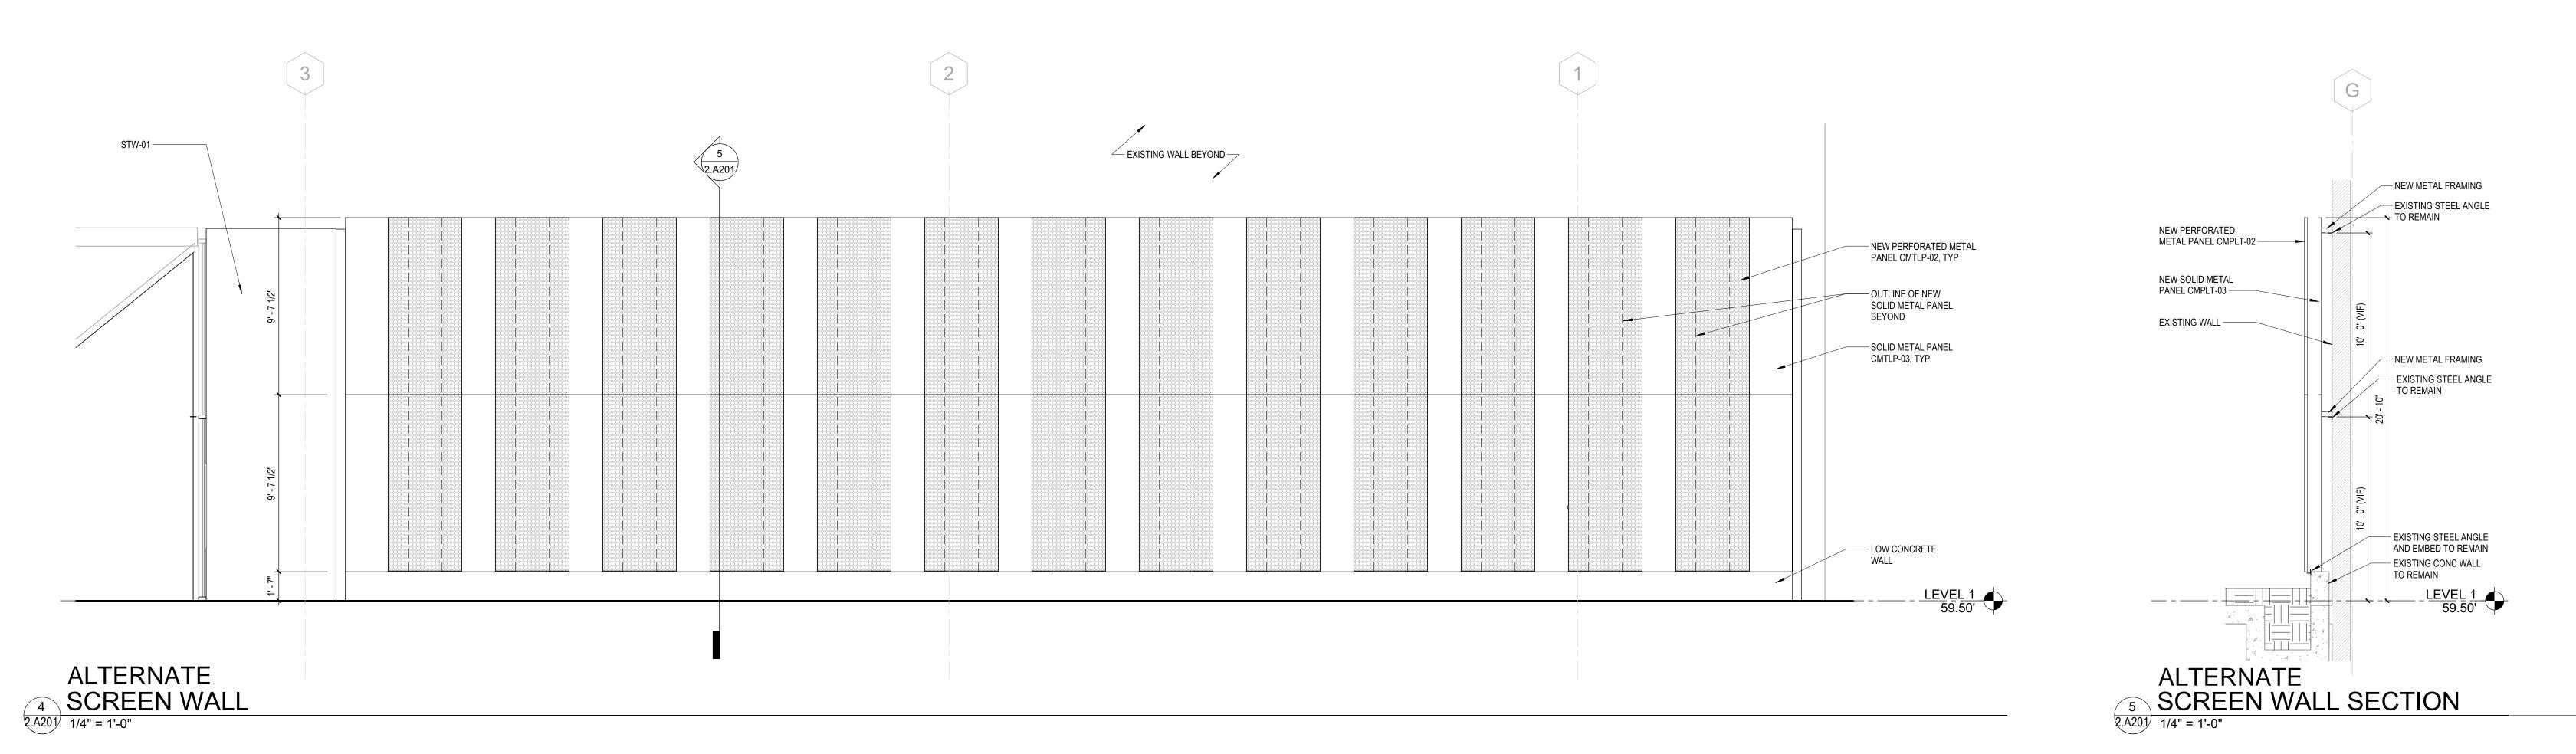





801 Second Avenue, Suite 501 Seattle, Washington 98104 T 206 682 3460 www.lmnarchitects.com **NORTON BUILDING MODERNIZATION** 801 Second Avenue Seattle, WA 98104 Submittal **DESIGN** DEVELOPMENT


Revisions Date 09/07/23


BUILDING SECTIONS & ELEVATIONS


2.A201

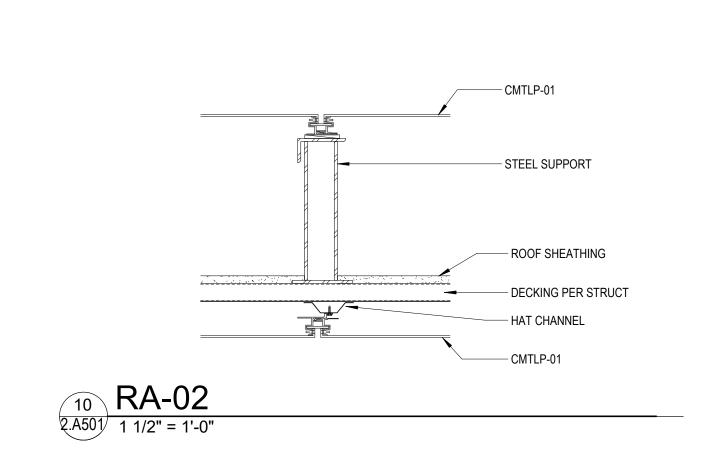


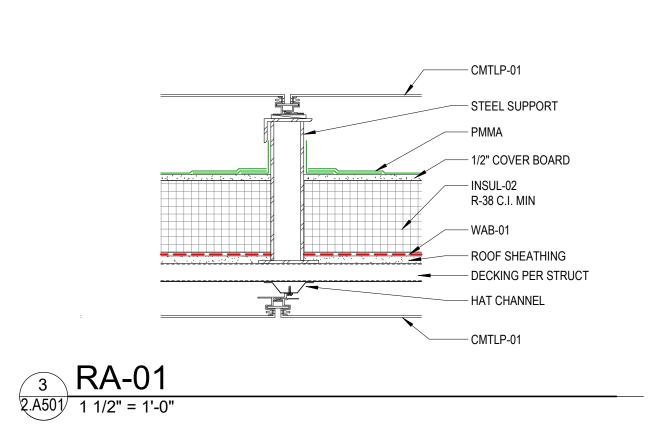

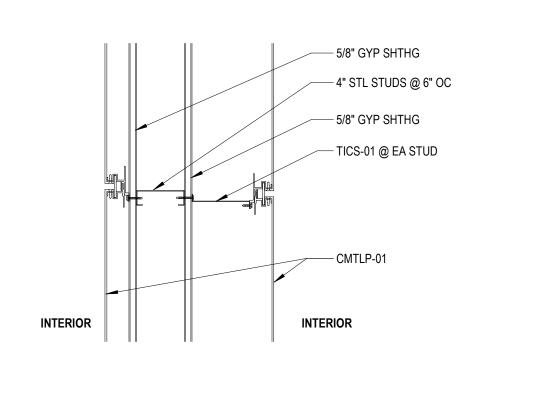


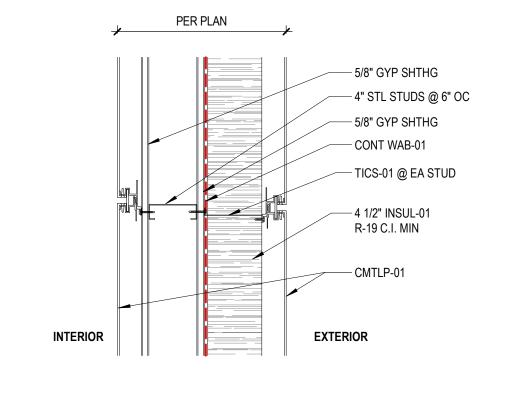

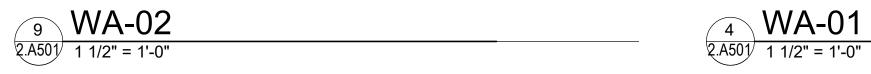


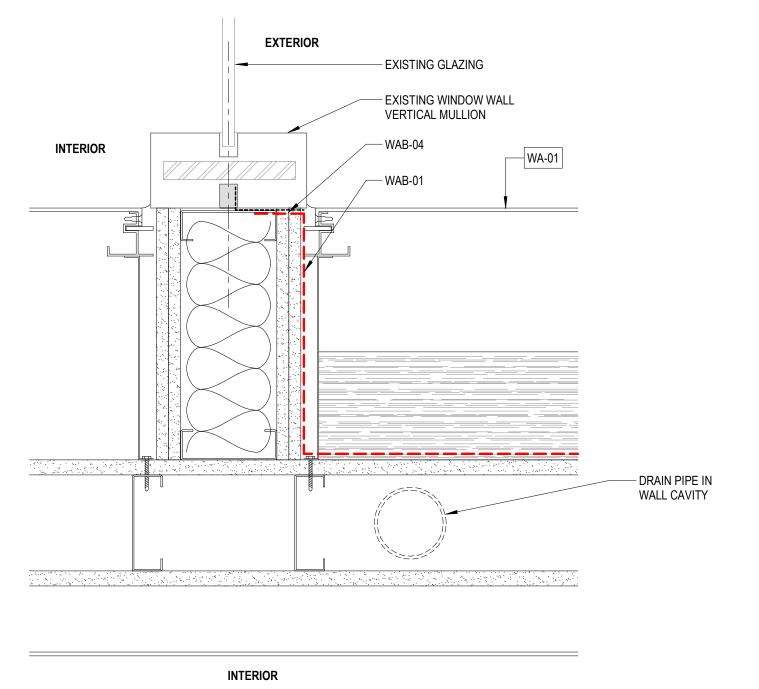




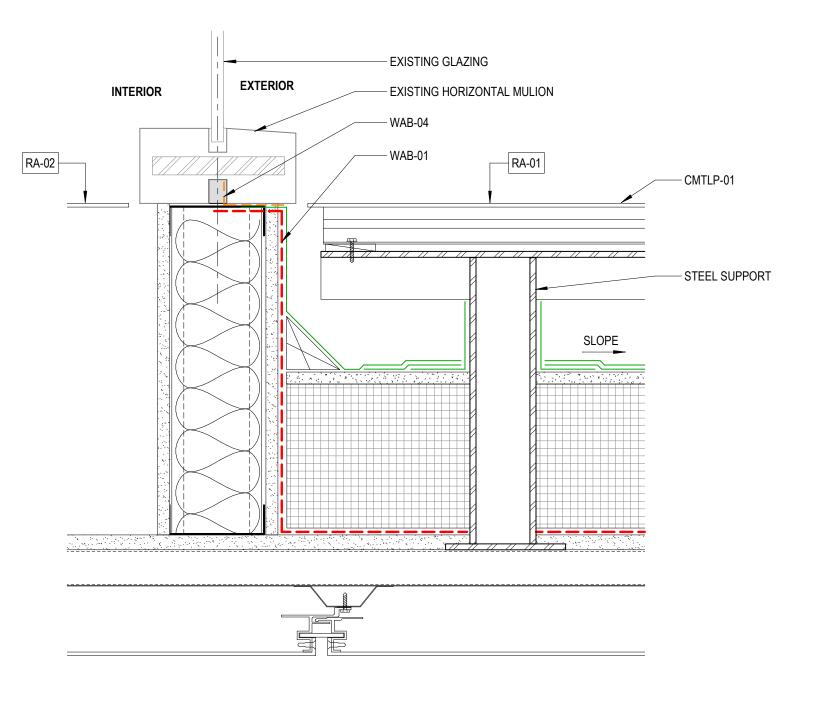


7 VESTIBULE ROOF @ EXISTING HORIZ MULLION 2.A501 3" = 1'-0"

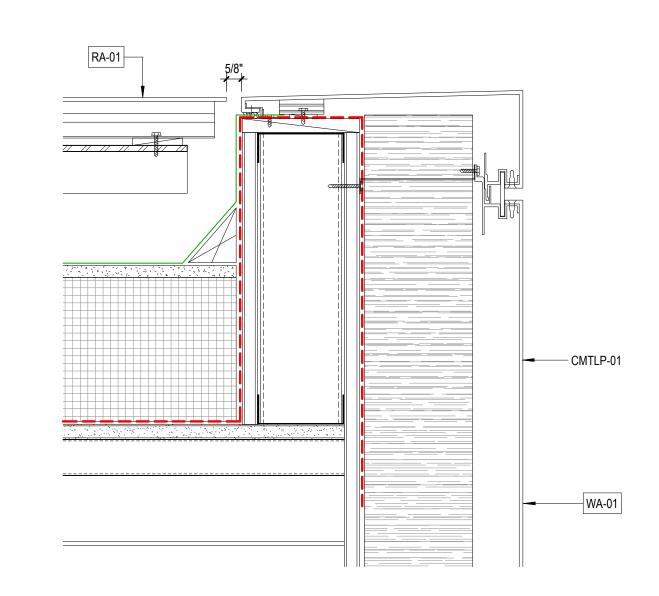


8 CMTLP ROOF CURB, TYP
2.A501 3" = 1'-0"

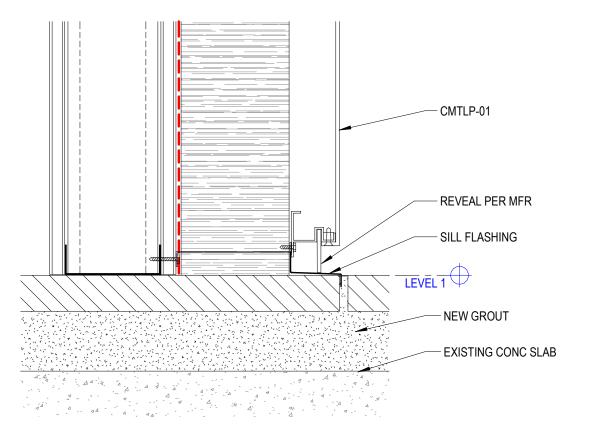

1 2.A501 3" = 1'-0"

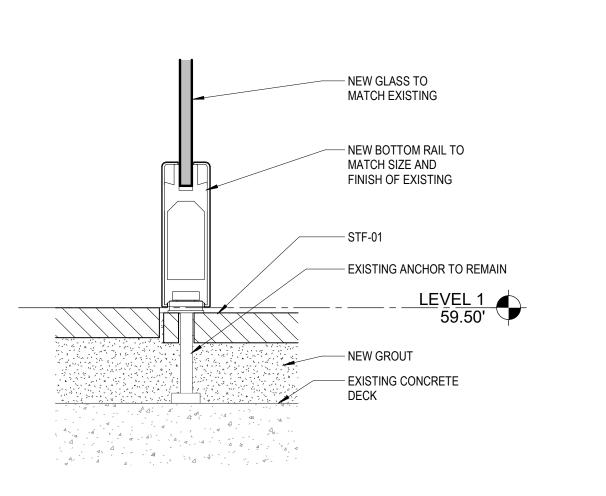

5 NEW SILL @ WINDOW WALL
2.A501 3" = 1'-0"

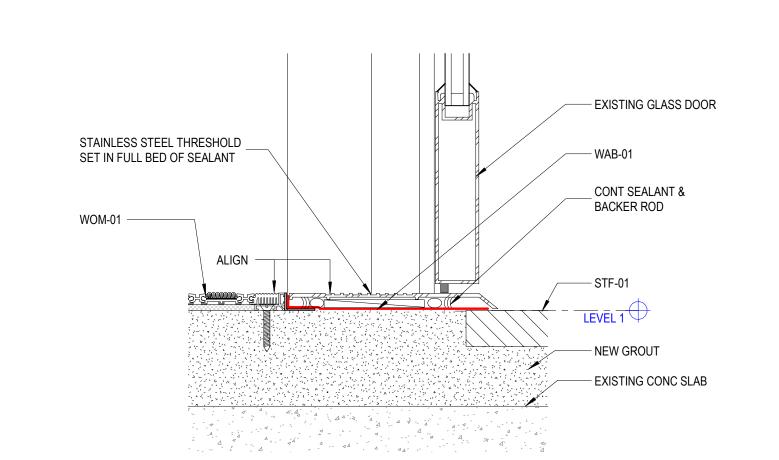

THRESHOLD @ VESTIBULE ENTRY, TYP

Architecture
Urban Design
Interiors

801 Second Avenue, Suite 501
Seattle, Washington 98104
T 206 682 3460
www.lmnarchitects.com

Professional Seal

AHJ Review Stamp

HINES

NORTON BUILDING MODERNIZATION

801 Second Avenue Seattle, WA 98104

DESIGN DEVELOPMENT

Revisions
Date Description
09/07/23 DD SET

Sheet Owner Author
LMN Proj No 22004-01

Date 09/07/202

Date 09/07/2023


Sheet Title

THERMAL ASSEMBLY
TYPES & EXTERIOR
DETAILS

Sheet Number

2.A501



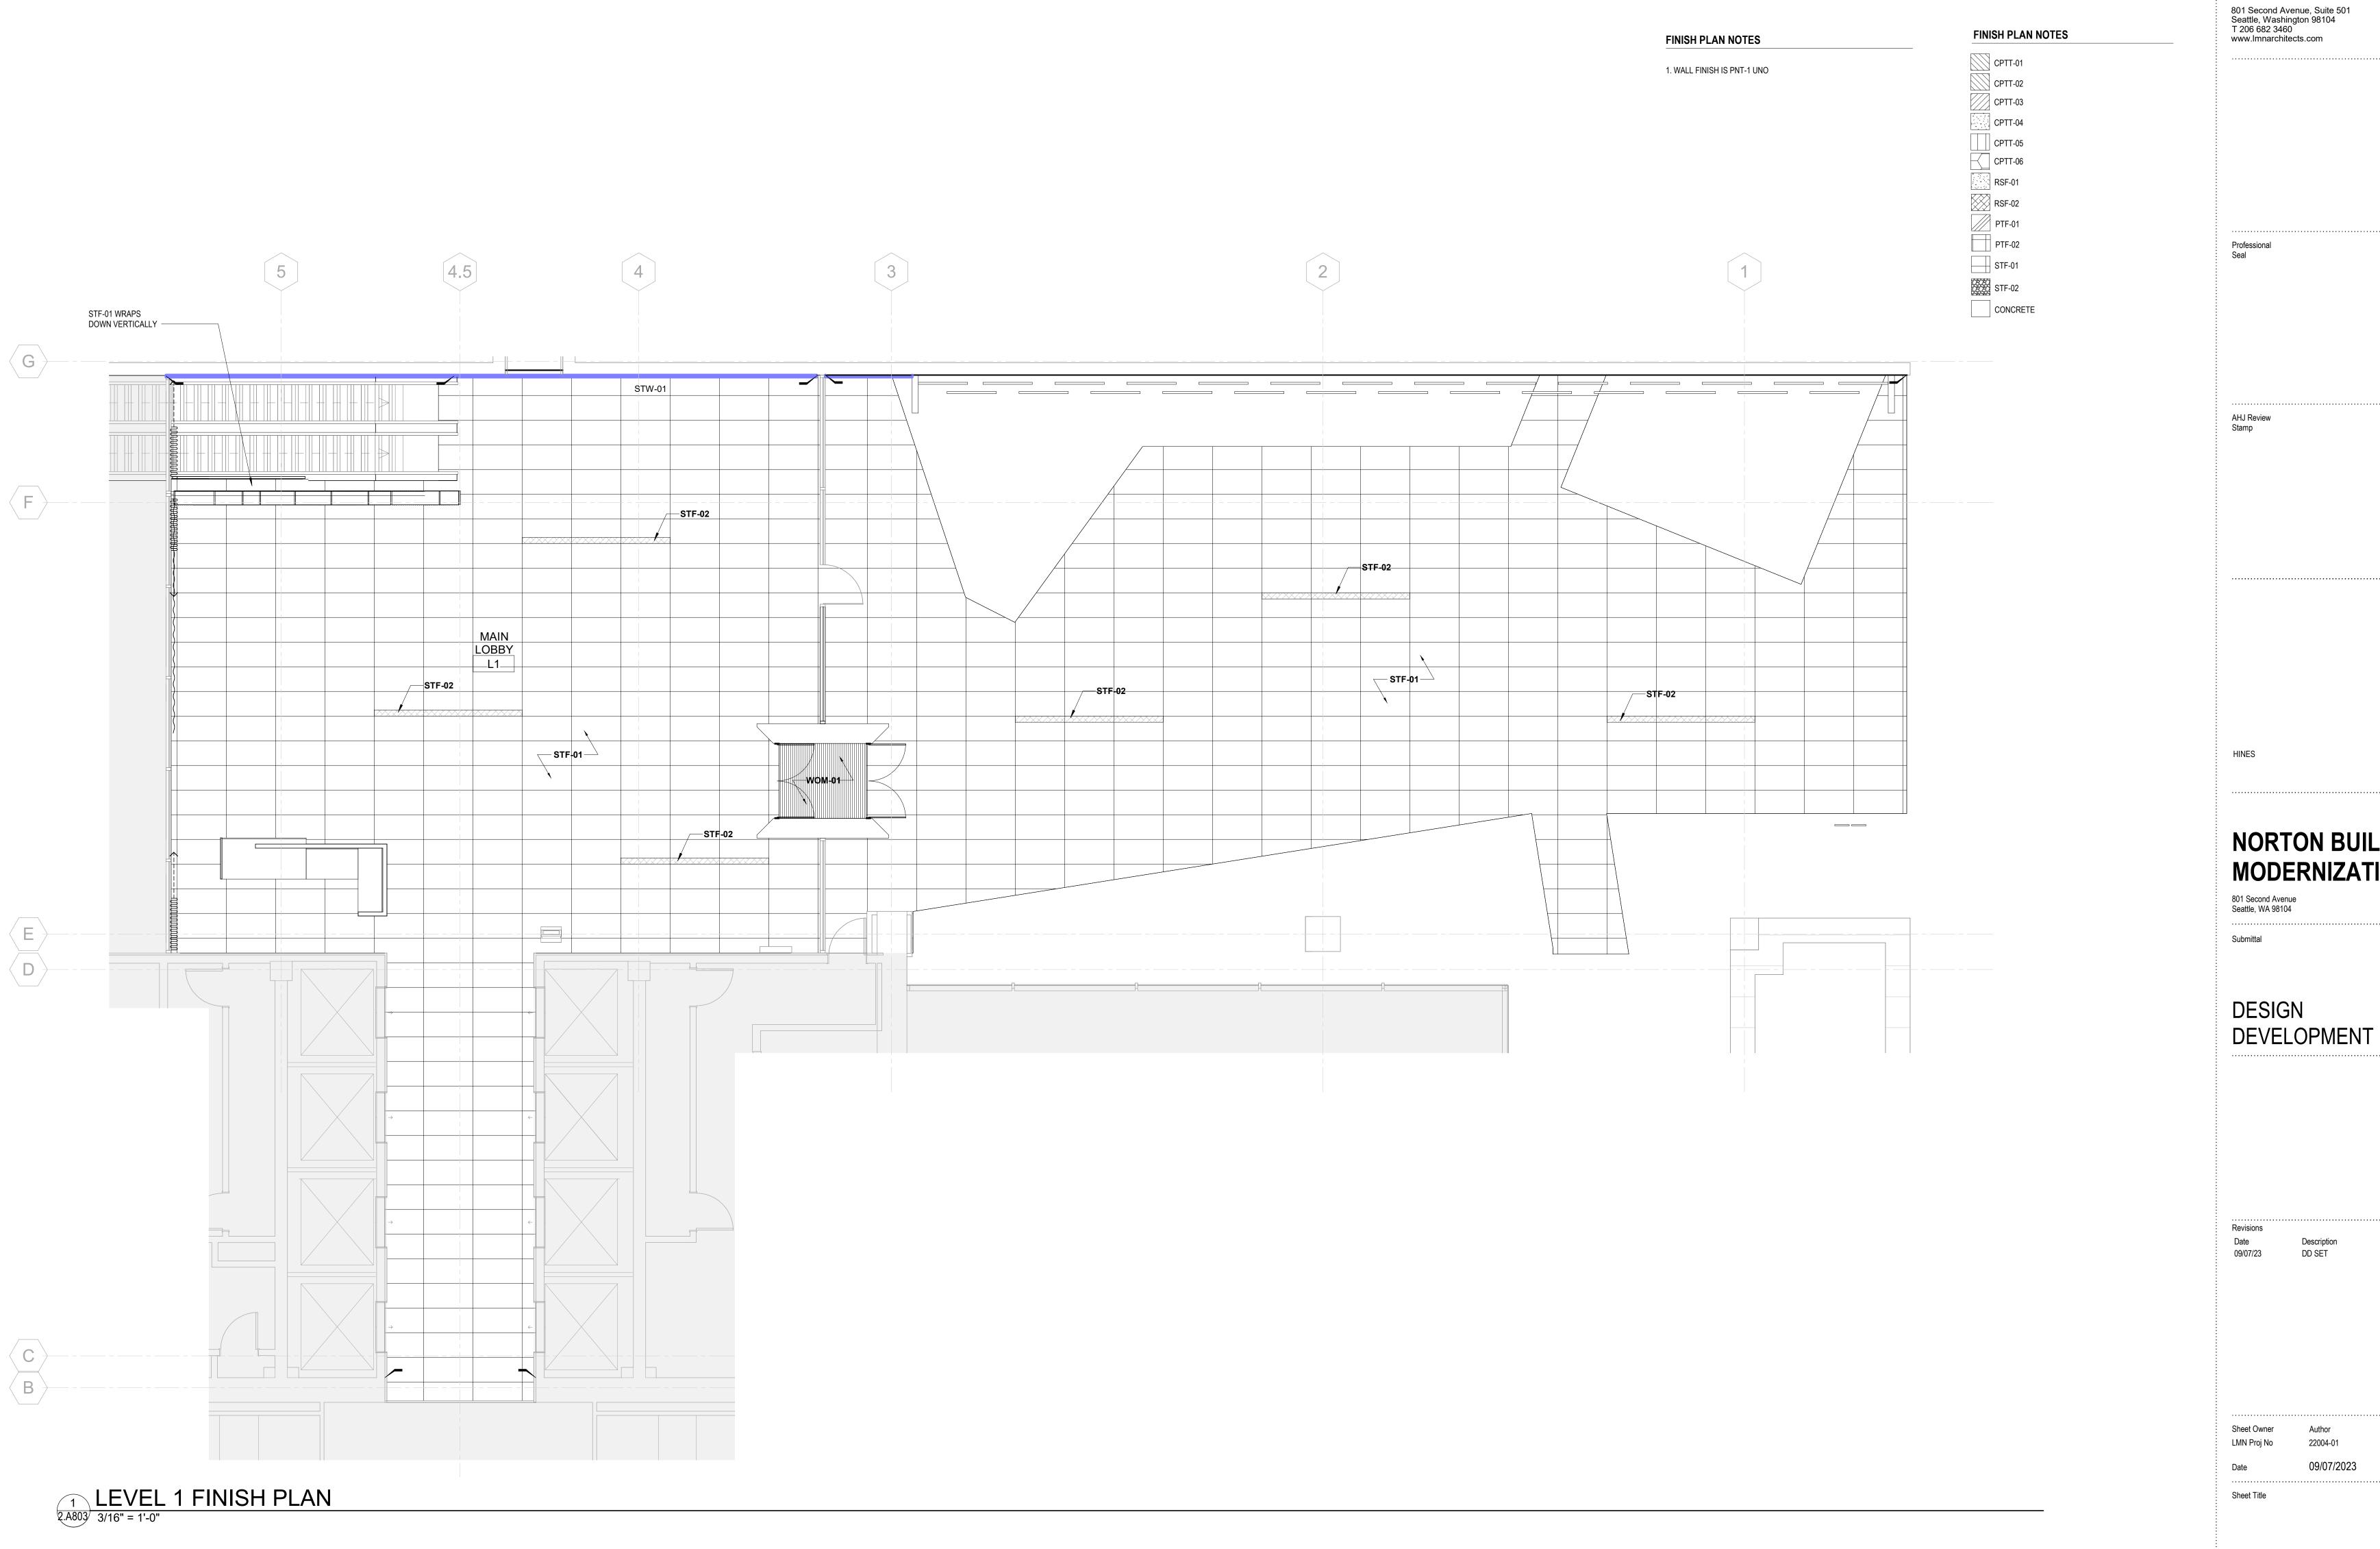

NORTON BUILDING MODERNIZATION

LEVEL 1 FINISH PLAN



INDEX

EG.0.01 Index & General Notes EG.0.02 Schedules

EG.0.03 Signs Overview

EG.0.04 Materials, Finishes & Color

EG.0.05 Typography
EG.1.06 Location Plan

EG.2.01 M1: Exterior Monument

EG.2.02 ID1: Primary Building ID

EG.2.03 ID2, D1 & D2: First Avenue Signage Overview

EG.2.04 ID2: Secondary Building ID

EG.2.05 D1: Parking Directional Header EG.2.06 D2: Parking Directional Blade

GENERAL NOTES

The purpose of these drawings is to illustrate design intent and provide sufficient information for ROM pricing. Drawings are not for construction. Fabricator to provide itemized pricing for all sign types.

Fabricator to submit requested samples and mockups to the Project Owner and Studio Matthews prior to proceeding with fabrication. Finish samples as well as a minimum x1 mockup of each sign type are required. See page 0.02.

Prior to fabrication, Studio Matthews will issue a 100% Design Intent set that gives greater detail regarding design and specifications. After issuance, further development and engineering of drawings contained shall be submitted as shop drawings by the Fabricator to the Project Owner and Studio Matthews prior to proceeding with fabrication. Any variations to design, materials, or fabrication methods must be approved by the Owner or Representative. Fabricator to verify field dimensions and confirm locations of all obstructions.

Contractors shall verify and be responsible for all final quality, dimensions, materials, and conditions on the job. The quality of fit and finish on the final product must meet or exceed the requirements of these design intent documents.

Fabricator assumes responsibility for identifying and confirming all details within this scope of work are of sound structural design and comply with any structural and/or life safety requirements.

Any requisite outside consultation with licensed engineer should be carried under Fabricator scope of work. Fabricator to coordinate any structural and/or electrical requirements/ locations/details with appropriate trades.

Written dimensions on these drawings have precedence over scaled dimensions. Studio Matthews shall not be responsible for scale discrepancies caused by reduced or enlarged drawings. Dimensions shown are approximate and for pricing purposes only. Final installation dimensions to be finalized via vendor submittal review process or artwork files provided by Studio Matthews.

Welds: All welds shall be ground smooth, paint all seams.

Hardware: All exposed hardware shall be tamper proof fasteners.

Application of anti-graffiti and UV protective coating required for all exterior signage.

FINAL ARTWORK

Messages shown in these drawings are for general reference only.

Colors shown are for reference only and are subject to the limitations of the printing process. Refer to the 100% Design Intent set for color system specifications.

Fabricator to confirm as-built conditions and complete shop drawings for all signs prior to final artwork submission by Studio Matthews.

All final artwork to be provided by Studio Matthews.
Fabricator to provide graphic proofs of all artwork for Project
Owner and Studio Matthew's approval prior to production.



801 Second Avenue, Suite 501 Seattle, Washington 98104 T 206 682 3460 www.lmnarchitects.com

Studio Matthews

1517 12th Avenue, No 304 Seattle WA 98122 206 432-9641 studiomatthews.com

> Professional Seal

AHJ Review Stamp

HINES

NORTON BUILDING MODERNIZATION

801 Second Avenue Seattle, WA 98104

.....

DESIGN DEVELOPMENT

sions

Owner

oj No 22004-01 09/07/20:

Sheet Title

Index & General Notes

TITLE BLOCK

Sheet Number

SIGN SCHEDULE

SIGN TYPE	DESCRIPTION	QTY	FINAL ARTWORK DELIVERABLE FROM SM
M1	Exterior Monument	x1	Final Art
ID1	Primary Building ID	x1	Final Art
ID2	Secondary Building ID	x1	Final Art
D1	Parking Directional Header	x1	Final Art
D2	Parking Directional Blade	x1	Final Art

SAMPLES SCHEDULE

Fabricator to provide Qty. 2 of all samples listed: x1 to Project Owner and x1 to Studio Matthews, unless otherwise noted in sample schedule.

ITEM	DESCRIPTION	QTY	SIZE	DETAILS
MTRL-1	Stainless Steel Sheet	x1	4"x4" min.	_
MTRL-2	Steel Sheet	x1	4"x4" min.	Powdercoated CLR–1
MTRL-4	Stainless Steel Tube	x1	4" min. length	_
MTRL-5	Light-Diffusing Acrylic, White	x1	4"x4" min.	_

MOCKUPS SCHEDULE

Fabricator to provide at minimum Qty. 1 of all mockups listed to Studio Matthews, unless otherwise noted in mockup schedule. Mockups are required to match all colors and materials as specified for Project Owner approval.

ITEM	DESCRIPTION	QTY	SIZE	DETAILS
M1	Exterior Monument	x1	15"x15" min.	Full-scale partial assembly including large MTRL–1 letter "R", small MTRL–3 lettering, and direct printed artwork
ID1	Primary Building ID	x1	9"x9" min.	Full-scale partial assembly including partial shroud replica. Mockup to serve as proof of concept for final installation. Coordinate closely with Architect and G.C.
ID2	Secondary Building ID	x1	15"x9" min.	Full-scale partial assembly
D2	Parking Directional Blade	x1	12"x12" min.	Full-scale partial assembly including rigid panel to serve as mounting substrate stand-in and functional illumination



801 Second Avenue, Suite 501 Seattle, Washington 98104 T 206 682 3460 www.lmnarchitects.com

Studio Matthews

1517 12th Avenue, No 304 Seattle WA 98122 206 432-9641 studiomatthews.com

Professional

AHJ Reviev

NORTON BUILDING MODERNIZATION

801 Second Avenue Seattle, WA 98104

.....

DESIGN DEVELOPMENT

.....

Description

Sheet Owner

22004-01

Schedules

TITLE BLOCK







M1—Exterior Monument



ID2—Secondary Building ID & D1—Parking Directional Header

D2—Parking Directional Blade



801 Second Avenue, Suite 501 Seattle, Washington 98104 T 206 682 3460 www.lmnarchitects.com

Studio Matthews

1517 12th Avenue, No 304 Seattle WA 98122 206 432-9641 studiomatthews.com

Professional Seal

AHJ Review

.....

HINES

NORTON BUILDING MODERNIZATION

801 Second Avenue Seattle, WA 98104

Submittal

DESIGN DEVELOPMENT

Sheet Owner

ate 09/07/20

Sheet Title

Signs Overview

TITLE BLOCK

Sheet Number

MATERIALS





Product Details	_
Finish	_
Notes	_



MTRL-2 Stainless Steel Sheet

-	
Product Details	_
Finish	Brushed (vertical)
Notes	_



MTRL-3 Aluminum Sheet

Product Details	_
Finish	_
Notes	_



MTRL-4 Stainless Steel Tube

Product Details	_
Finish	Brushed
Notes	_



MTRL-5 Light-Diffusing Acrylic, White

Product Details	Greencast™ or product with similar sustainable qualities
Finish	Matte
Notes	_



CLR-1 Blacked Bronze	
Product Details	_
Finish	To match new vestibule entry shroud
Notes	Coordinate with G.C. to acquire control sample
Notes	

CLR-2 White	9
Draduat Dataila	

Product Details	_
Finish	_
Notes	CMYK 0, 0, 0, 0

801 Second Avenue, Suite 501 Seattle, Washington 98104 T 206 682 3460 www.lmnarchitects.com

Studio Matthews 1517 12th Avenue, No 304 Seattle WA 98122 206 432-9641 studiomatthews.com

AHJ Review Stamp

NORTON BUILDING MODERNIZATION

801 Second Avenue Seattle, WA 98104

DESIGN DEVELOPMENT

Materials, Finishes & Color

TITLE BLOCK

KABEL LT STD HEAVY

ABCDEFGHIJKLMNOPQRSTUVWXYZ abcdefghijklmnopqrstuvwxyz 1234567890 / * () _- —" '

NEUE HAAS EE TEXT PRO 55 ROMAN

ABCDEFGHIJKLMNOPQRSTUVWXYZ abcdefghijklmnopqrstuvwxyz 1234567890 / * () _- -" '

Architecture
Urban Design
Interiors

801 Second Avenue, Suite 501 Seattle, Washington 98104 T 206 682 3460 www.lmnarchitects.com

Studio Matthews

1517 12th Avenue, No 304 Seattle WA 98122 206 432-9641 studiomatthews.com

NORTON BUILDING MODERNIZATION

801 Second Avenue Seattle, WA 98104


DESIGN DEVELOPMENT

Typography

TITLE BLOCK

SIGN TYPES

- M1 Exterior Monument
- **ID1** PrimaryBuilding ID
- ID2 PrimaryBuilding ID
- **D1** Parking Directional Header
- **D2** Parking Directional Blade

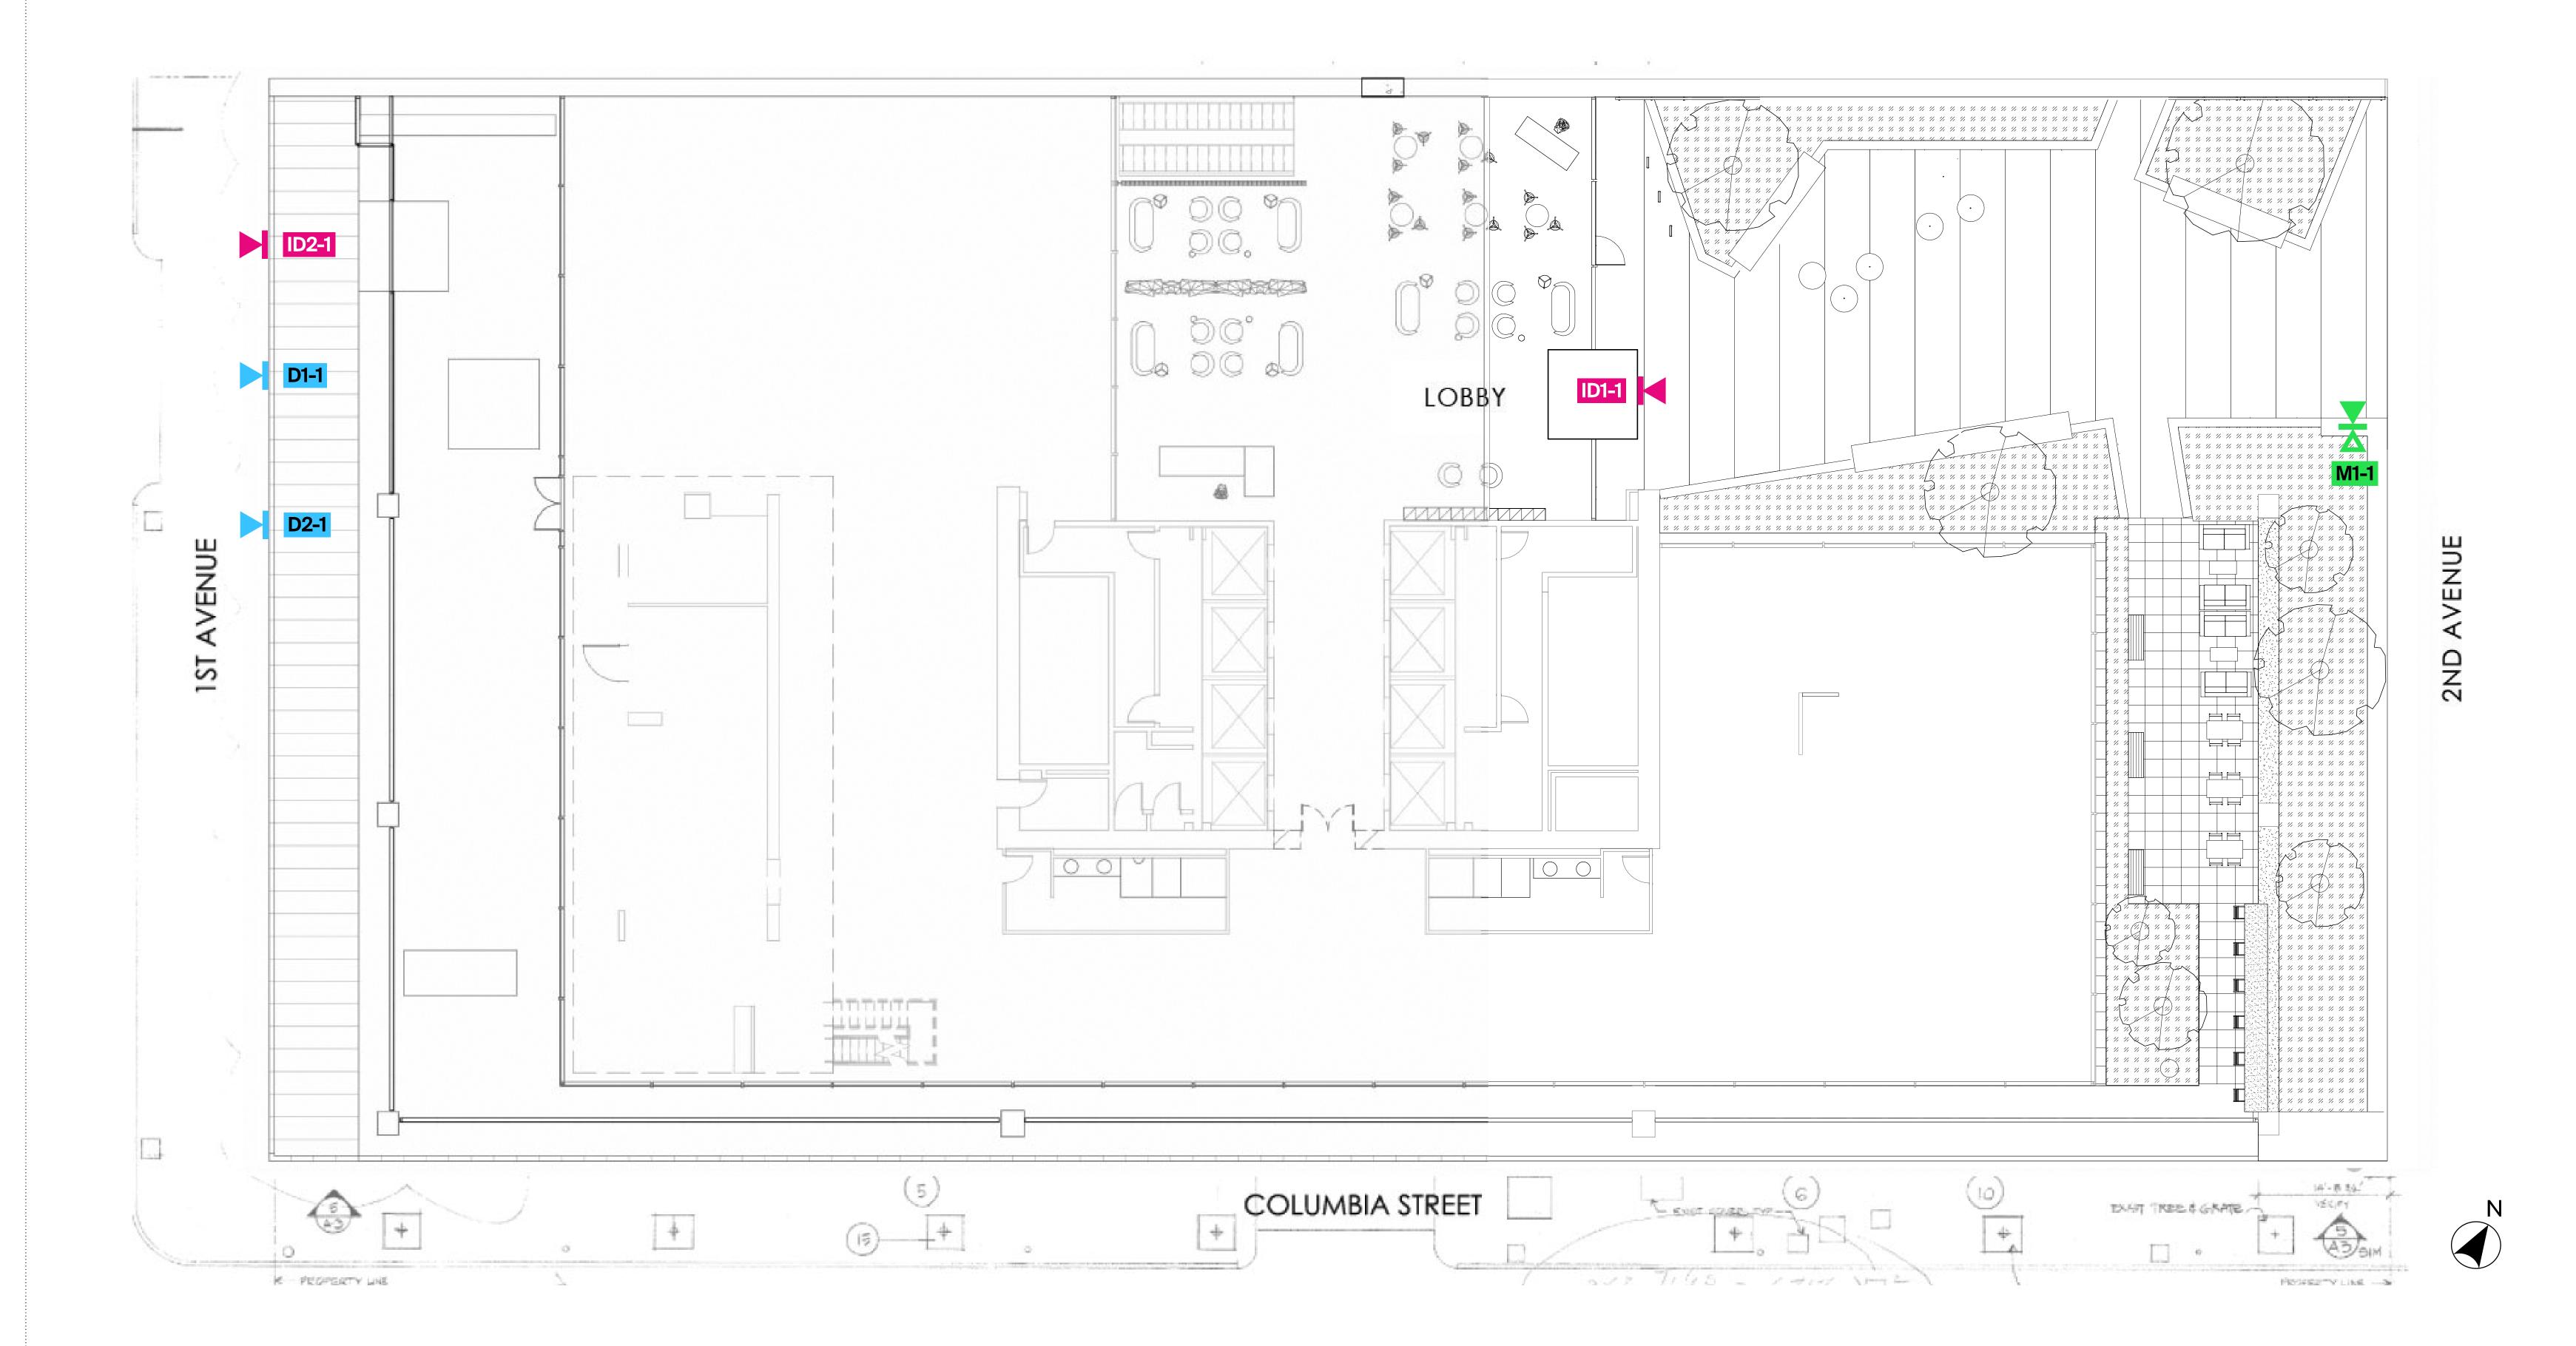



801 Second Avenue, Suite 501 Seattle, Washington 98104 T 206 682 3460 www.lmnarchitects.com

AHJ Review Stamp

HINES

NORTON BUILDING MODERNIZATION

801 Second Avenue Seattle, WA 98104

DESIGN DEVELOPMENT

sions

Description

Sheet Owner Author
LMN Proj No 22004

LMN Proj No 22004-01

Date 09/07/202


Location Plan

TITLE BLOCK

EG.1.06


- 1 MTRL-1 closed hollow forms with all corners and edges eased for safety, powdercoated CLR-1 on all sides, mounted flush to new plinth (by others).* All hardware to be concealed.
- 2 MTRL-2 letterforms, mounted flush to faces of 1 form, using both concealed hardware and adhesive to prevent vandalism/removal.*
- 3 MTRL-3 letterforms, painted to match CLR-2, mounted flush to faces of 1 form.*
- 4 CLR-2 direct printed on faces of 1 form.


*Coordinate with G.C. Exact mounting Details TBD in shop drawing process.

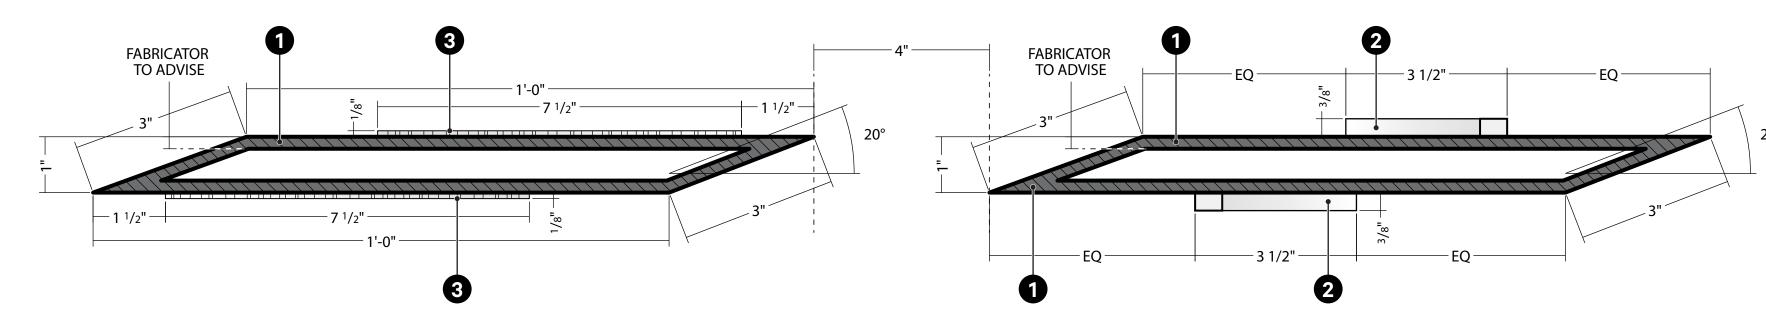

M1: Exterior Monument—Section A

Scale: 6" = 1'-0"

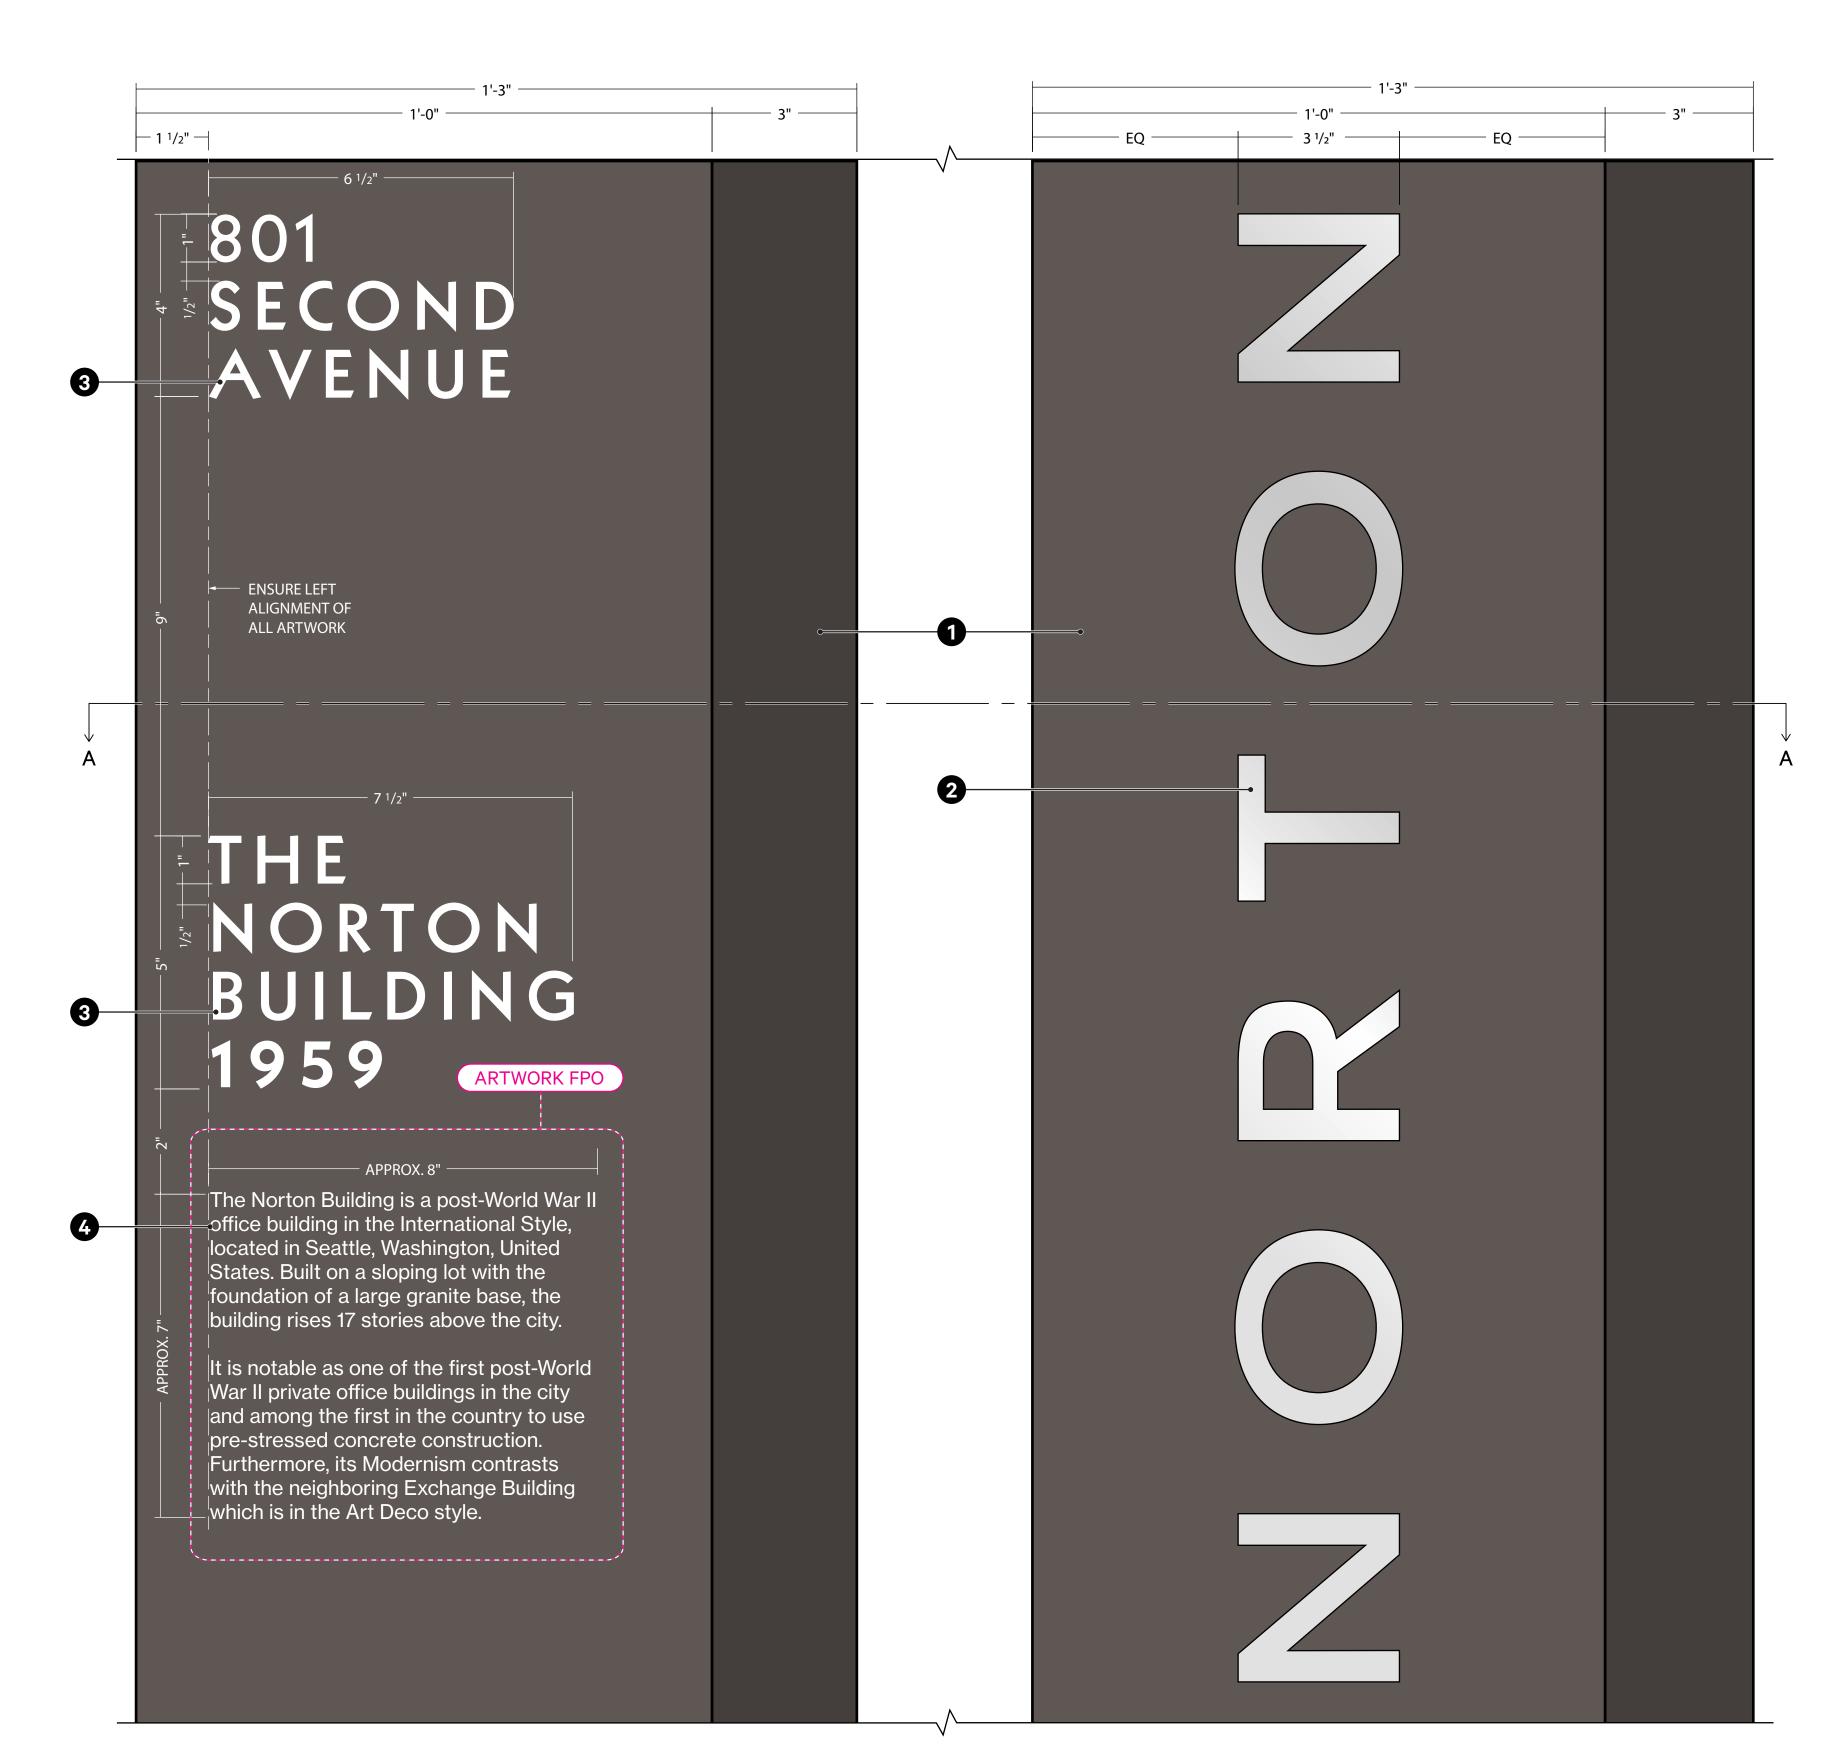


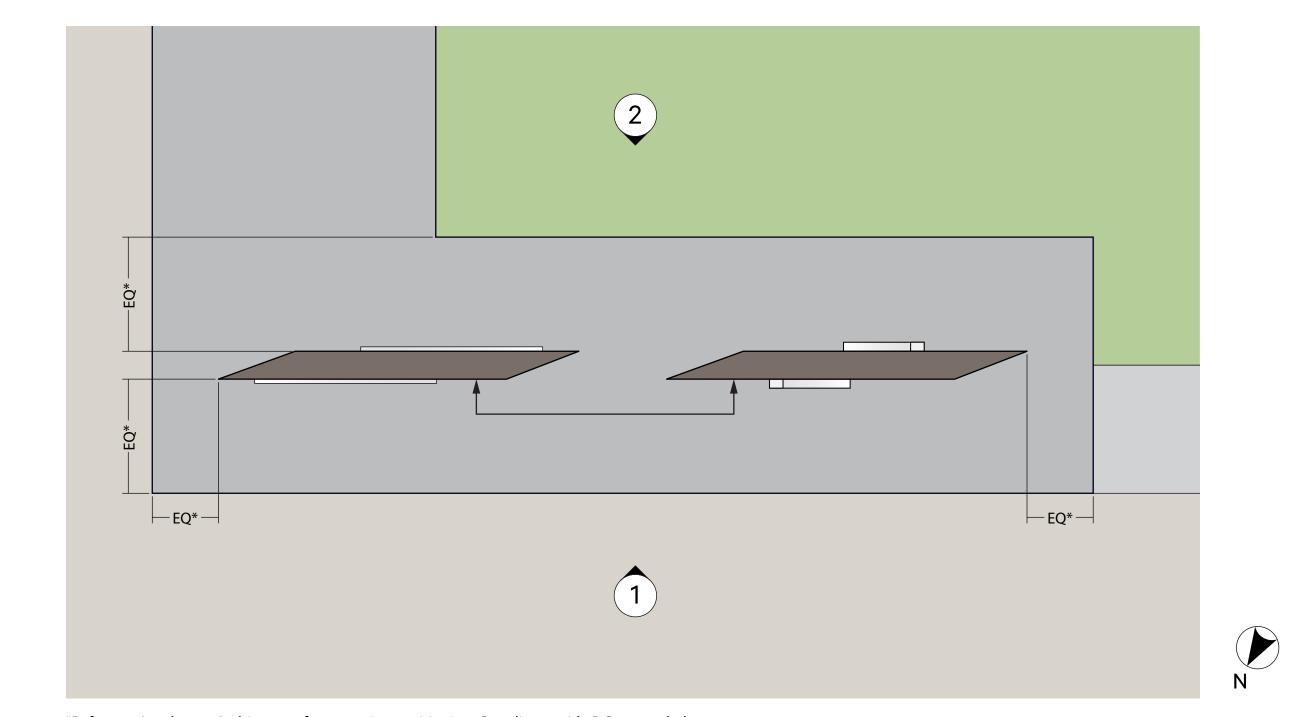

*Reference Landscape Architect set for exact sign positioning. Coordinate with G.C. as needed.

M1: Exterior Monument—Plan

Scale: 3" = 1'-0"

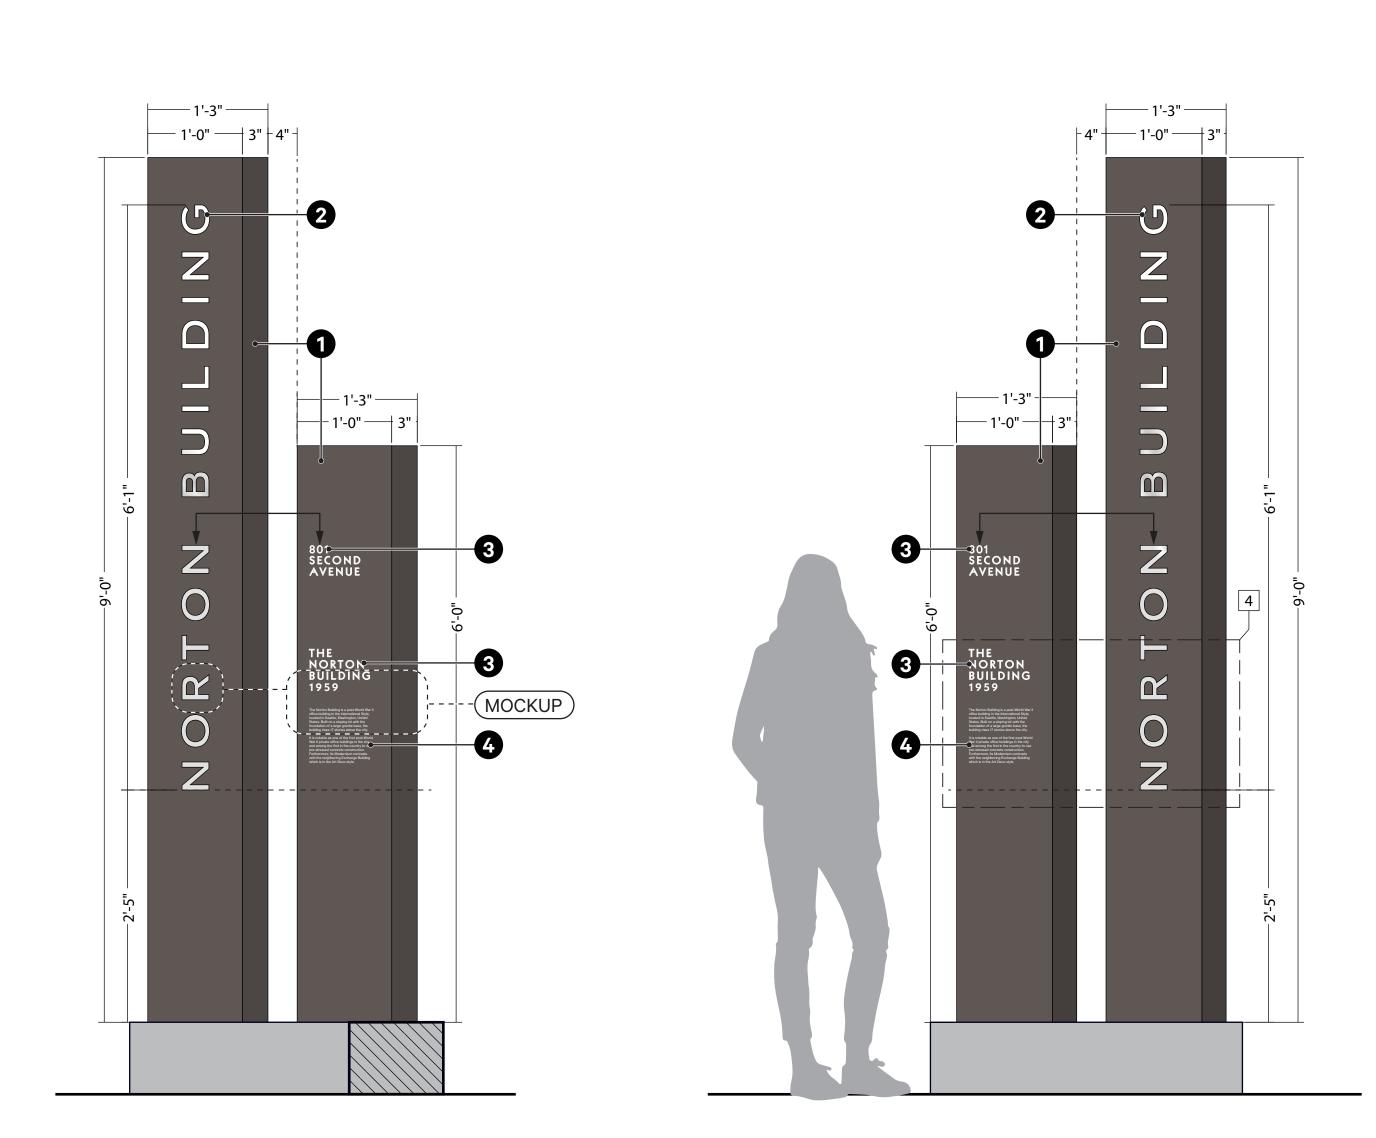

M1: Exterior Monument—South Elevation
Scale: 1" = 1'-0"

M1: Exterior Monument—North Elevation

Scale: 1" = 1'-0"

Architecture Urban Design Interiors

801 Second Avenue, Suite 501 Seattle, Washington 98104 T 206 682 3460 www.lmnarchitects.com

Studio Matthews

1517 12th Avenue, No 304 Seattle WA 98122 206 432-9641 studiomatthews.com

Professional Seal

AULD :

HINES

NORTON BUILDING MODERNIZATION

801 Second Avenue Seattle, WA 98104

Submittal

DESIGN DEVELOPMENT

evisions

Sheet Owner Author
MN Proj No 22004-01

Sheet Title

M1: Exterior

Monument


TITLE BLOCK
Sheet Number

- 1 MTRL-2 letterforms mounted to new vestibule shroud with 2 standoffs.* Shroud by others.
- 2 Standoffs tied directly into new vestibule shroud, painted CLR–1.*

*Coordinate with Architect and G.C. Exact mounting Details TBD in shop drawing process.




1 - Ne. Section of the section of th

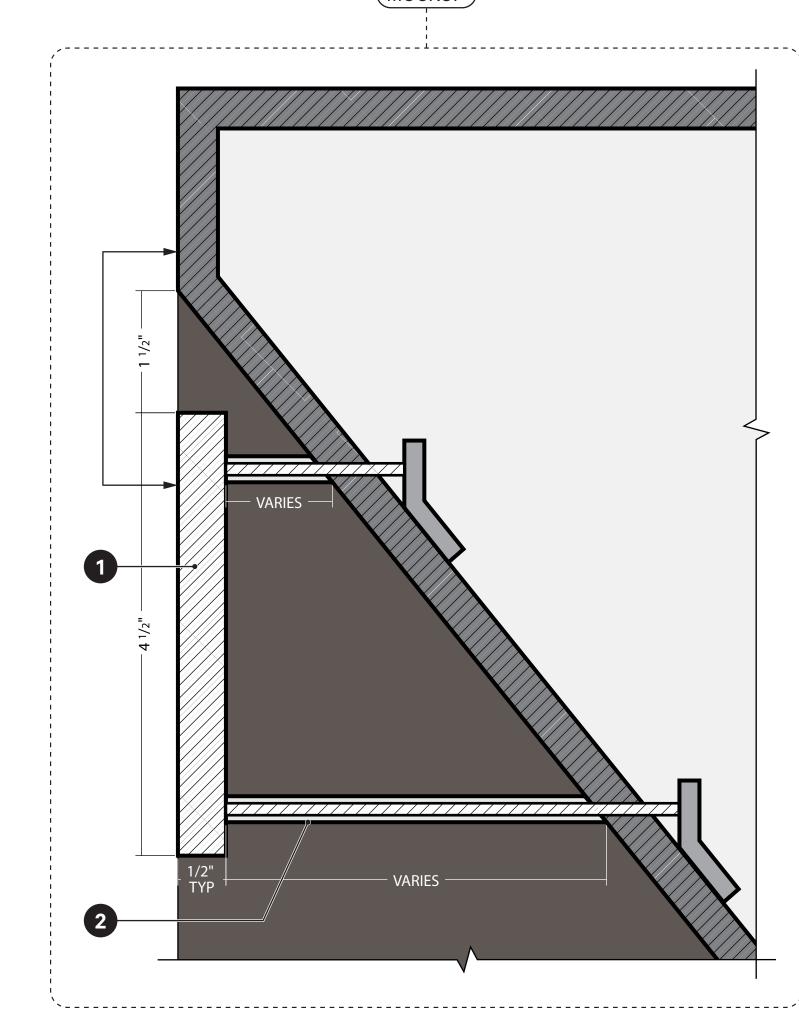


5 ID1: Primary Building ID—Context Elevation
Scale: 1/8" = 1'-0"

ID1: Primary Building ID—Elevation Detail
Scale: 1" = 1"

3 ID1: Primary Building ID—Section B

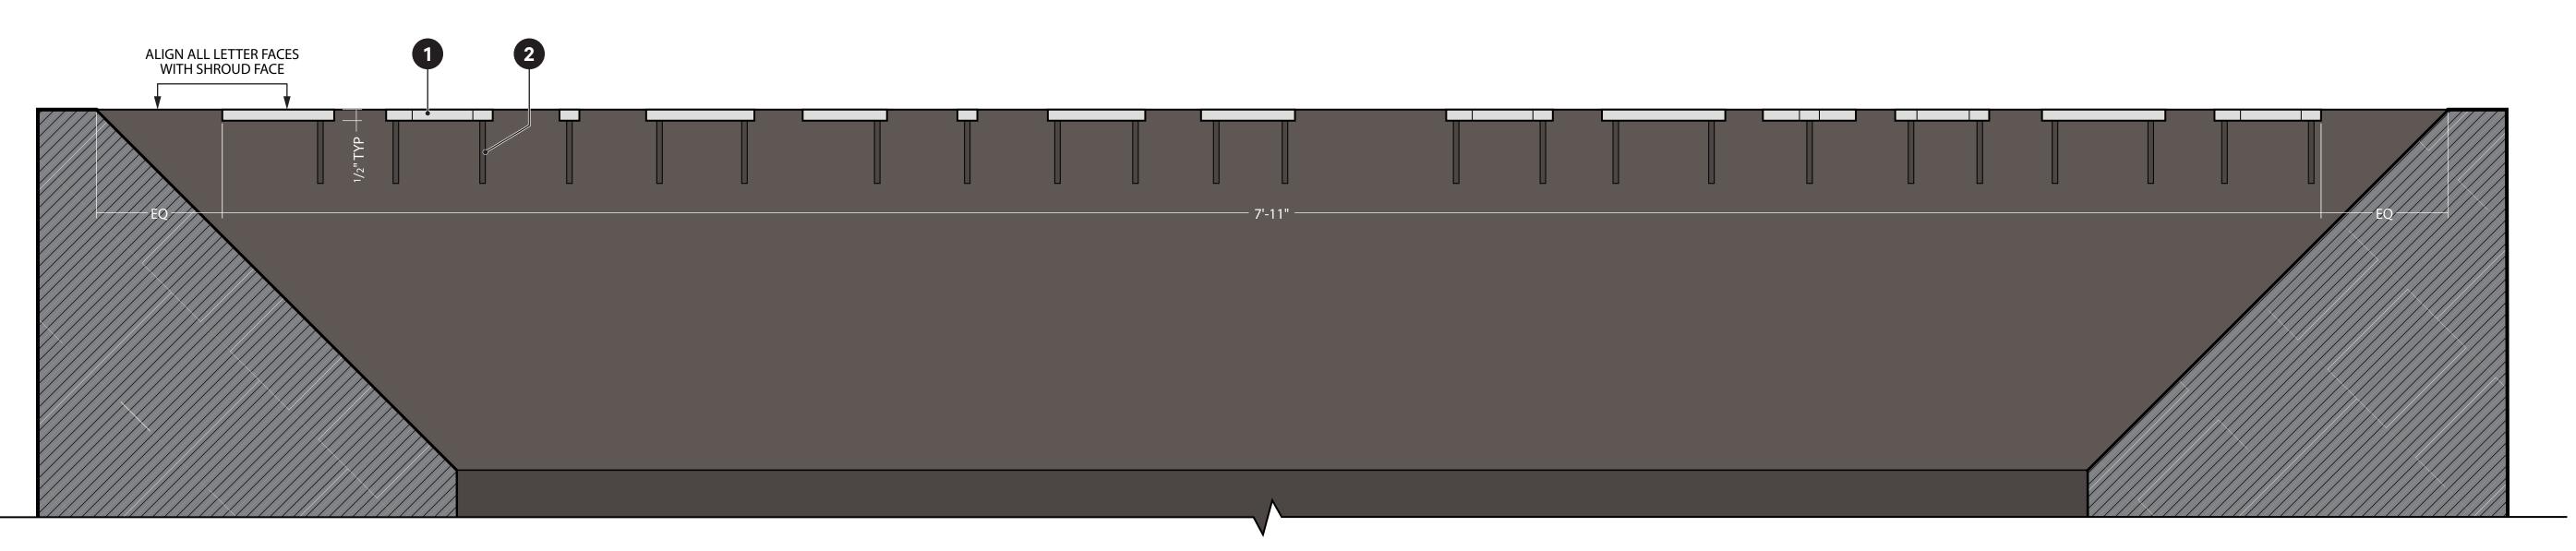

D1: Primary Building ID—Section A
Scale: 3" = 1'-0"

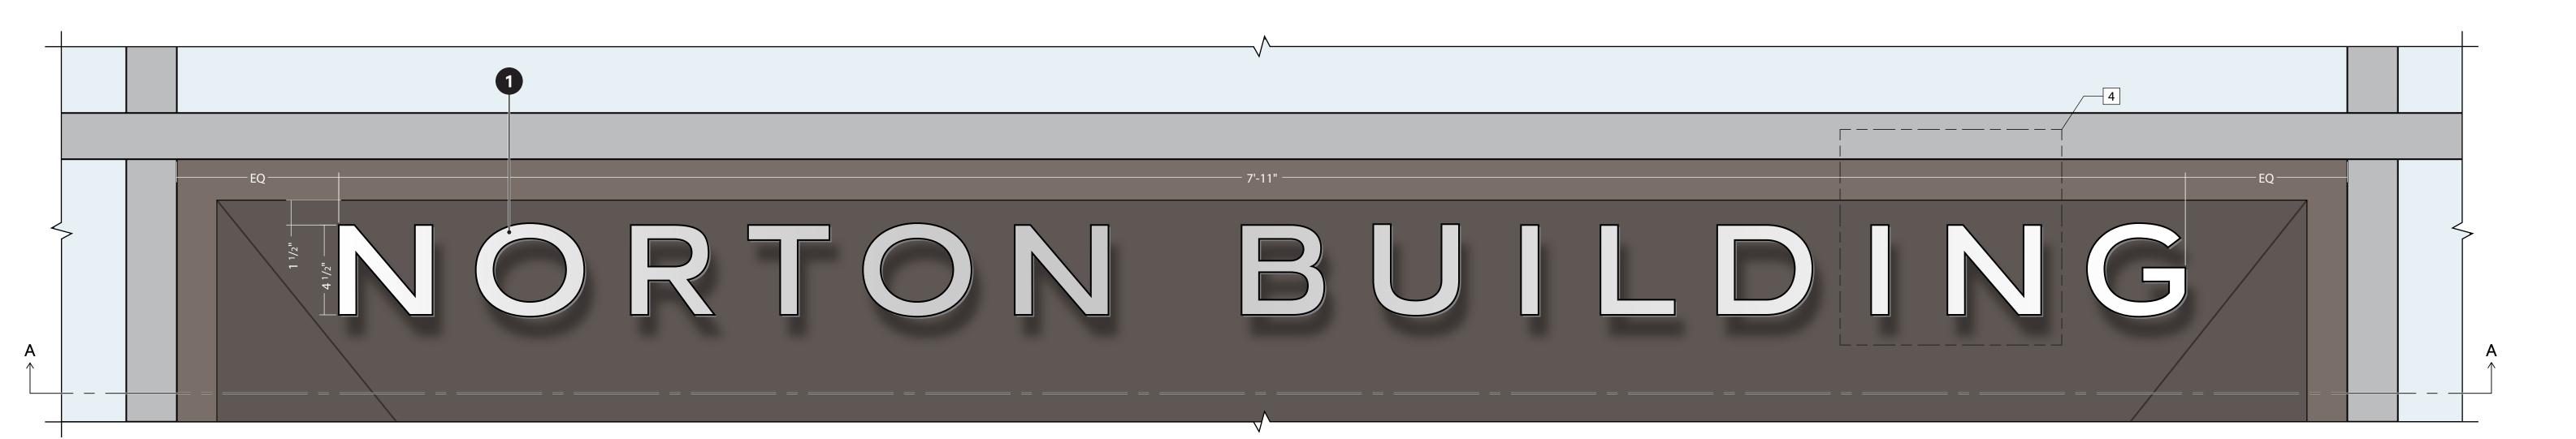

1 ID1: Primary Building ID—Elevation
Scale: 3" = 1'-0"

Architecture
Urban Design
Interiors

801 Second Avenue, Suite 501 Seattle, Washington 98104 T 206 682 3460 www.lmnarchitects.com

Studio Matthews

Matthews

1517 12th Avenue, No 304
Seattle WA 98122
206 432-9641
studiomatthews.com

ofessional al

AHJ Review

NORTON BUILDING MODERNIZATION

801 Second Avenue Seattle, WA 98104

Submittal

DESIGN DEVELOPMENT

Revisions

Sheet Owner /

N Proj No 22004-01

ID1: Primary Building ID

TITLE BLOCK

Sheet Number

See respective pages for details.

Fabricator responsible for removal of existing signage. Coordinate with G.C.



Architecture
Urban Design
Interiors

801 Second Avenue, Suite 501 Seattle, Washington 98104 T 206 682 3460 www.lmnarchitects.com

Studio Matthews

1517 12th Avenue, No 304 Seattle WA 98122 206 432-9641 studiomatthews.com

NORTON BUILDING MODERNIZATION


DESIGN DEVELOPMENT


ID2, D1 & D2: First Avenue Signage Overview

TITLE BLOCK

- 1 Steel C-channel, mounted flush to building exterior,* painted CLR-1 on all visible sides. All hardware to be concealed or painted CRL-1.
- 2 MTRL–2 letterforms mounted to 1 channel with 3 standoffs.*
- 3 Standoffs tied directly into 1 channel, painted CLR-1.*

*Coordinate with Architect and G.C. Exact mounting Details TBD in shop drawing process.

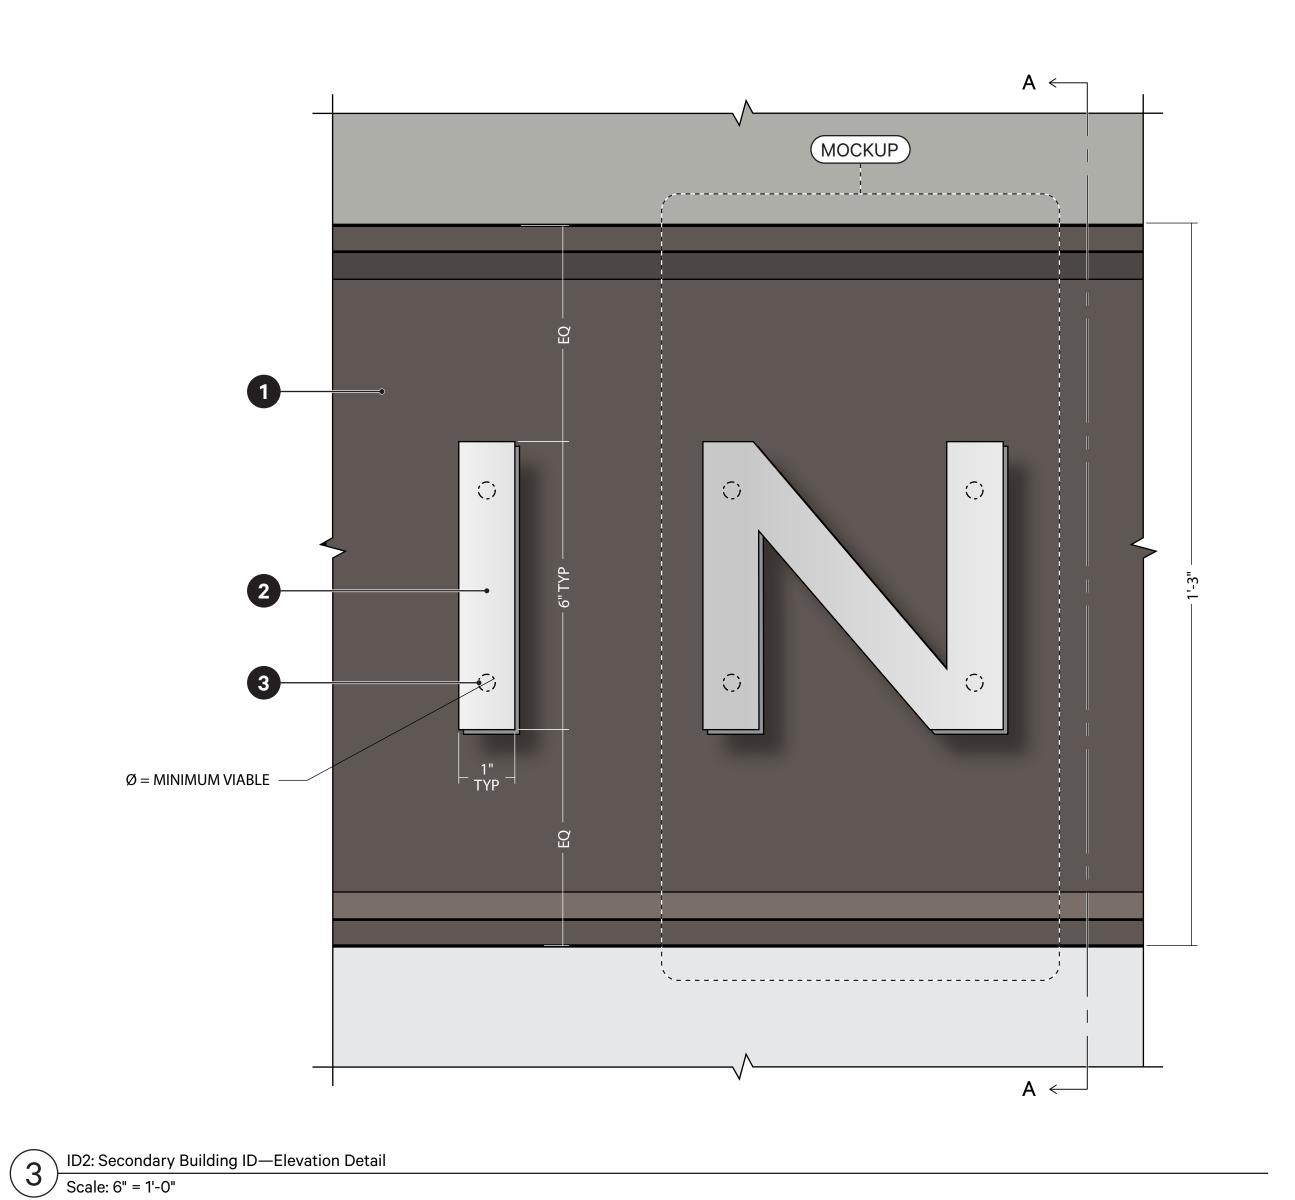

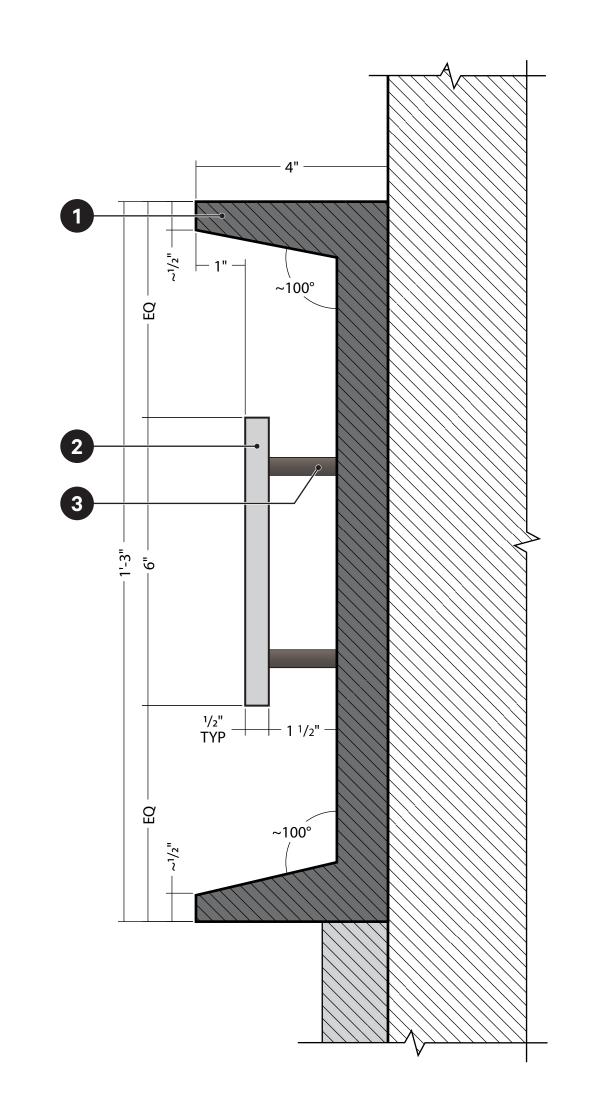

DD2: Secondary Building ID—Section A

Scale: 6" = 1'-0"



ID2: Secondary Building ID—Elevation
Scale: 1" = 1'-0"



801 Second Avenue, Suite 501 Seattle, Washington 98104 T 206 682 3460 www.lmnarchitects.com

Studio Matthews

1517 12th Avenue, No 304 Seattle WA 98122 206 432-9641 studiomatthews.com

> Professional Seal

AHJ Revie

NORTON BUILDING MODERNIZATION

801 Second Avenue Seattle, WA 98104

Submittal

DESIGN DEVELOPMENT

Povicione

Sheet Owner

pj No 22004-01

Date 09/07/2


ID2: Secondary Building ID


TITLE BLOCK

Sheet Number

- 1 MTRL-3 channel, mounted flush to building exterior,* painted CLR-1 on all visible sides. All hardware to be concealed or painted CRL-1.
- 2 MTRL–2 letterforms mounted to 1 channel with 3 standoffs.*
- 3 Standoffs tied directly into 1 channel, painted CLR-1.*


*Coordinate with Architect and G.C. Exact mounting Details TBD in shop drawing process.

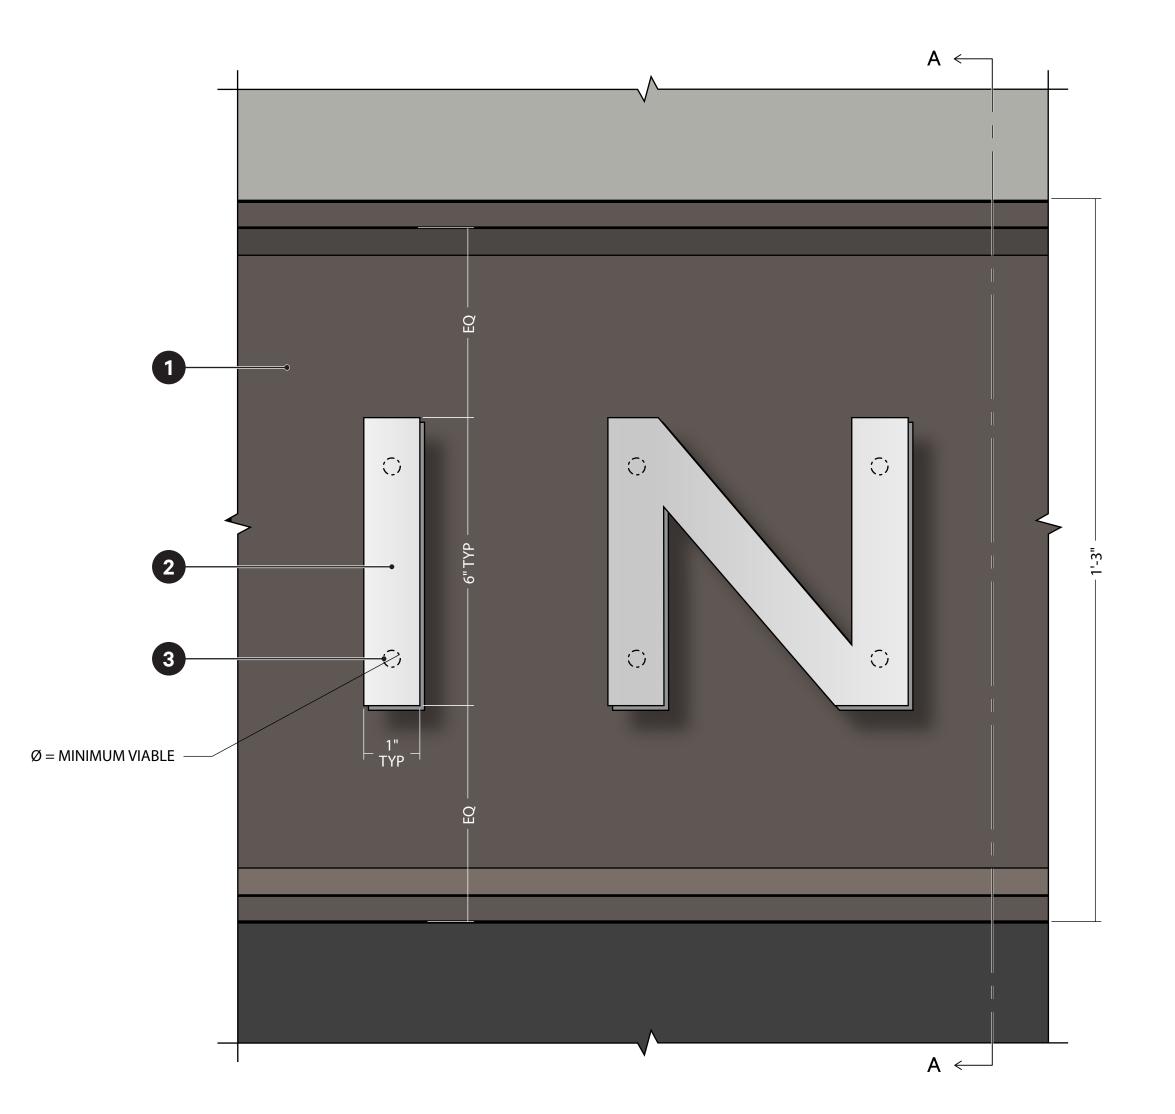

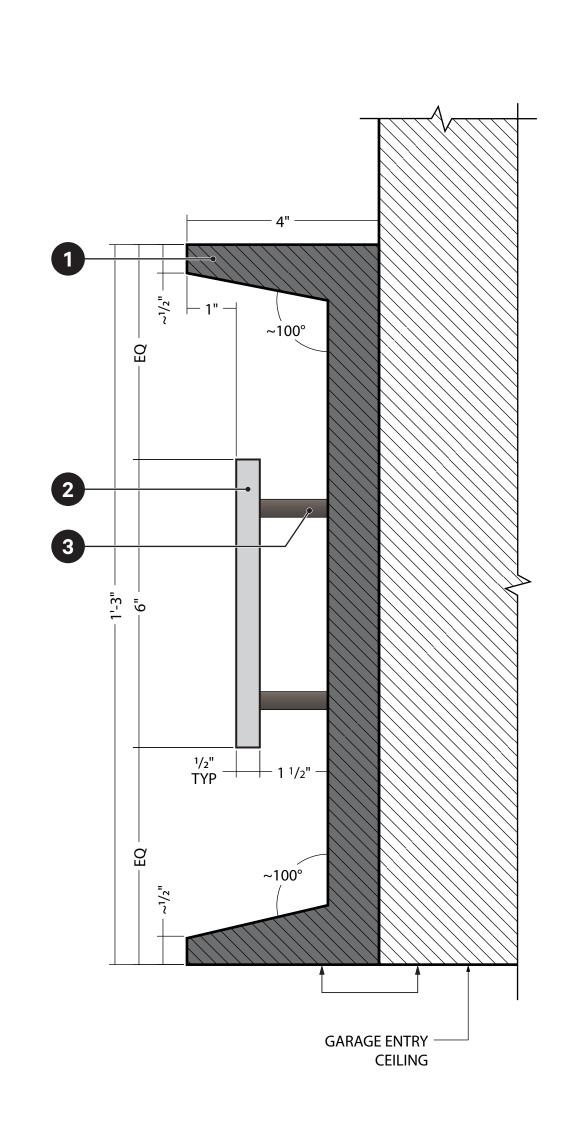

D1: Parking Directional Header—Elevation Detail

Scale: 6" = 1'-0"

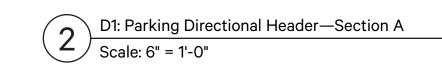





801 Second Avenue, Suite 501 Seattle, Washington 98104 T 206 682 3460 www.lmnarchitects.com

Studio Matthews

1517 12th Avenue, No 304 Seattle WA 98122 206 432-9641 studiomatthews.com

> Professional Seal

AHJ Revie Stamp

HINES

NORTON BUILDING MODERNIZATION

801 Second Avenue Seattle, WA 98104

DESIGN DEVELOPMENT

Date Description

Sheet Owner

Proj No 22004-0

Date 09/07/2
.....
Sheet Title

D1: Parking Directional Header


TITLE BLOCK

Sheet Number

- MTRL-3 routed discs, powdercoated CLR-1, adhered flush to 2 core.
- 2 MTRL-5 internally illuminated core mounted to building exterior with 3 posts.*
- 3 MTRL-4 posts mounted directly to building exterior,[†]


*Coordinate power with G.C.


[†]Coordinate with Architect and G.C. Exact mounting Details TBD in shop drawing process.

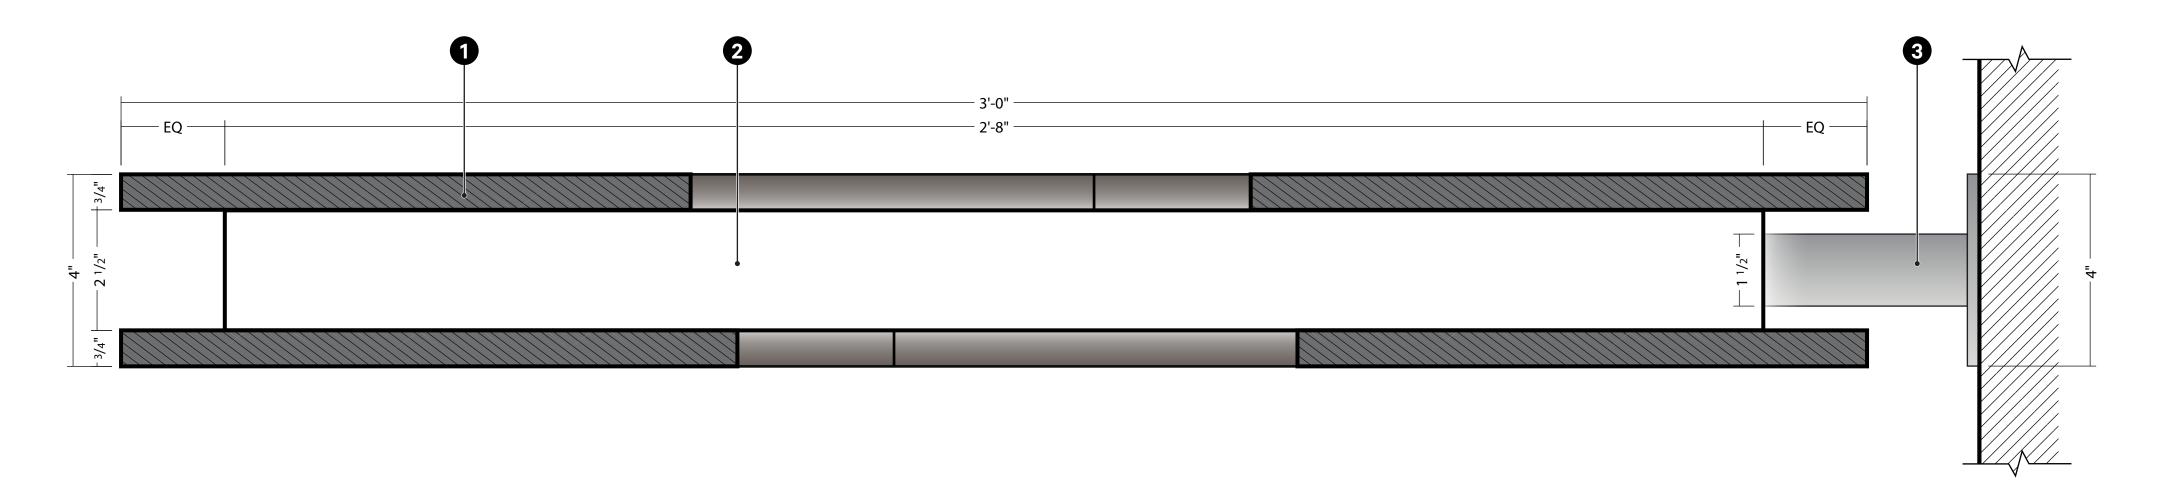


D2: Parking Directional Blade—Section A

Scale: 6" = 1'-0"

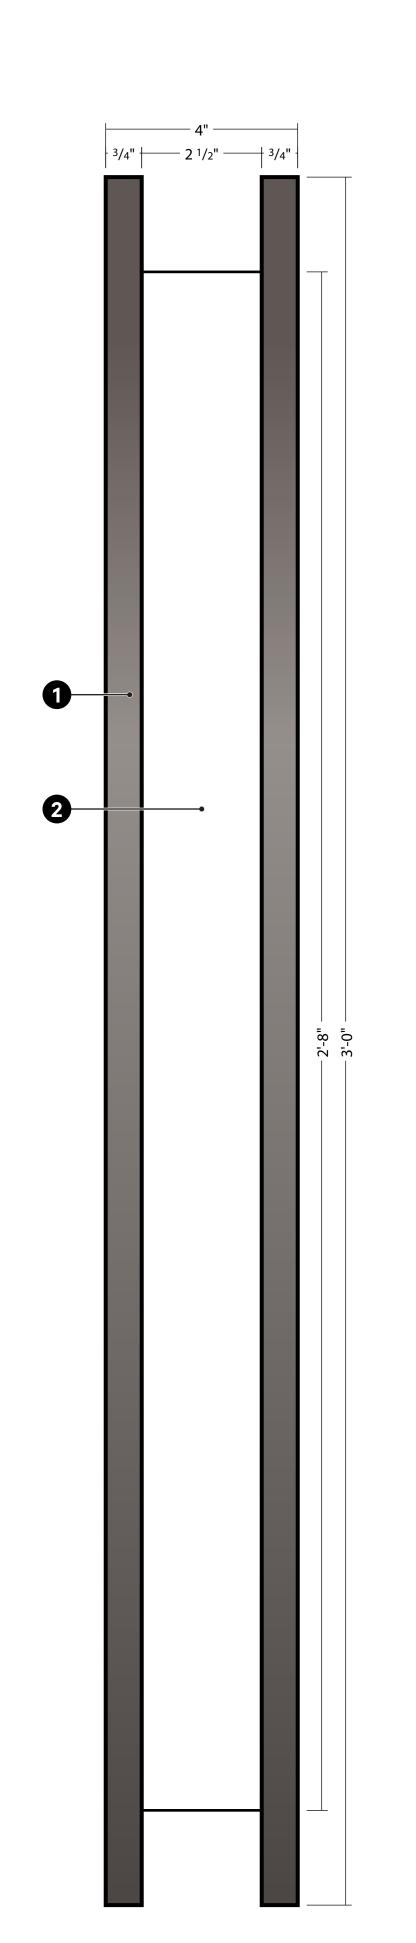

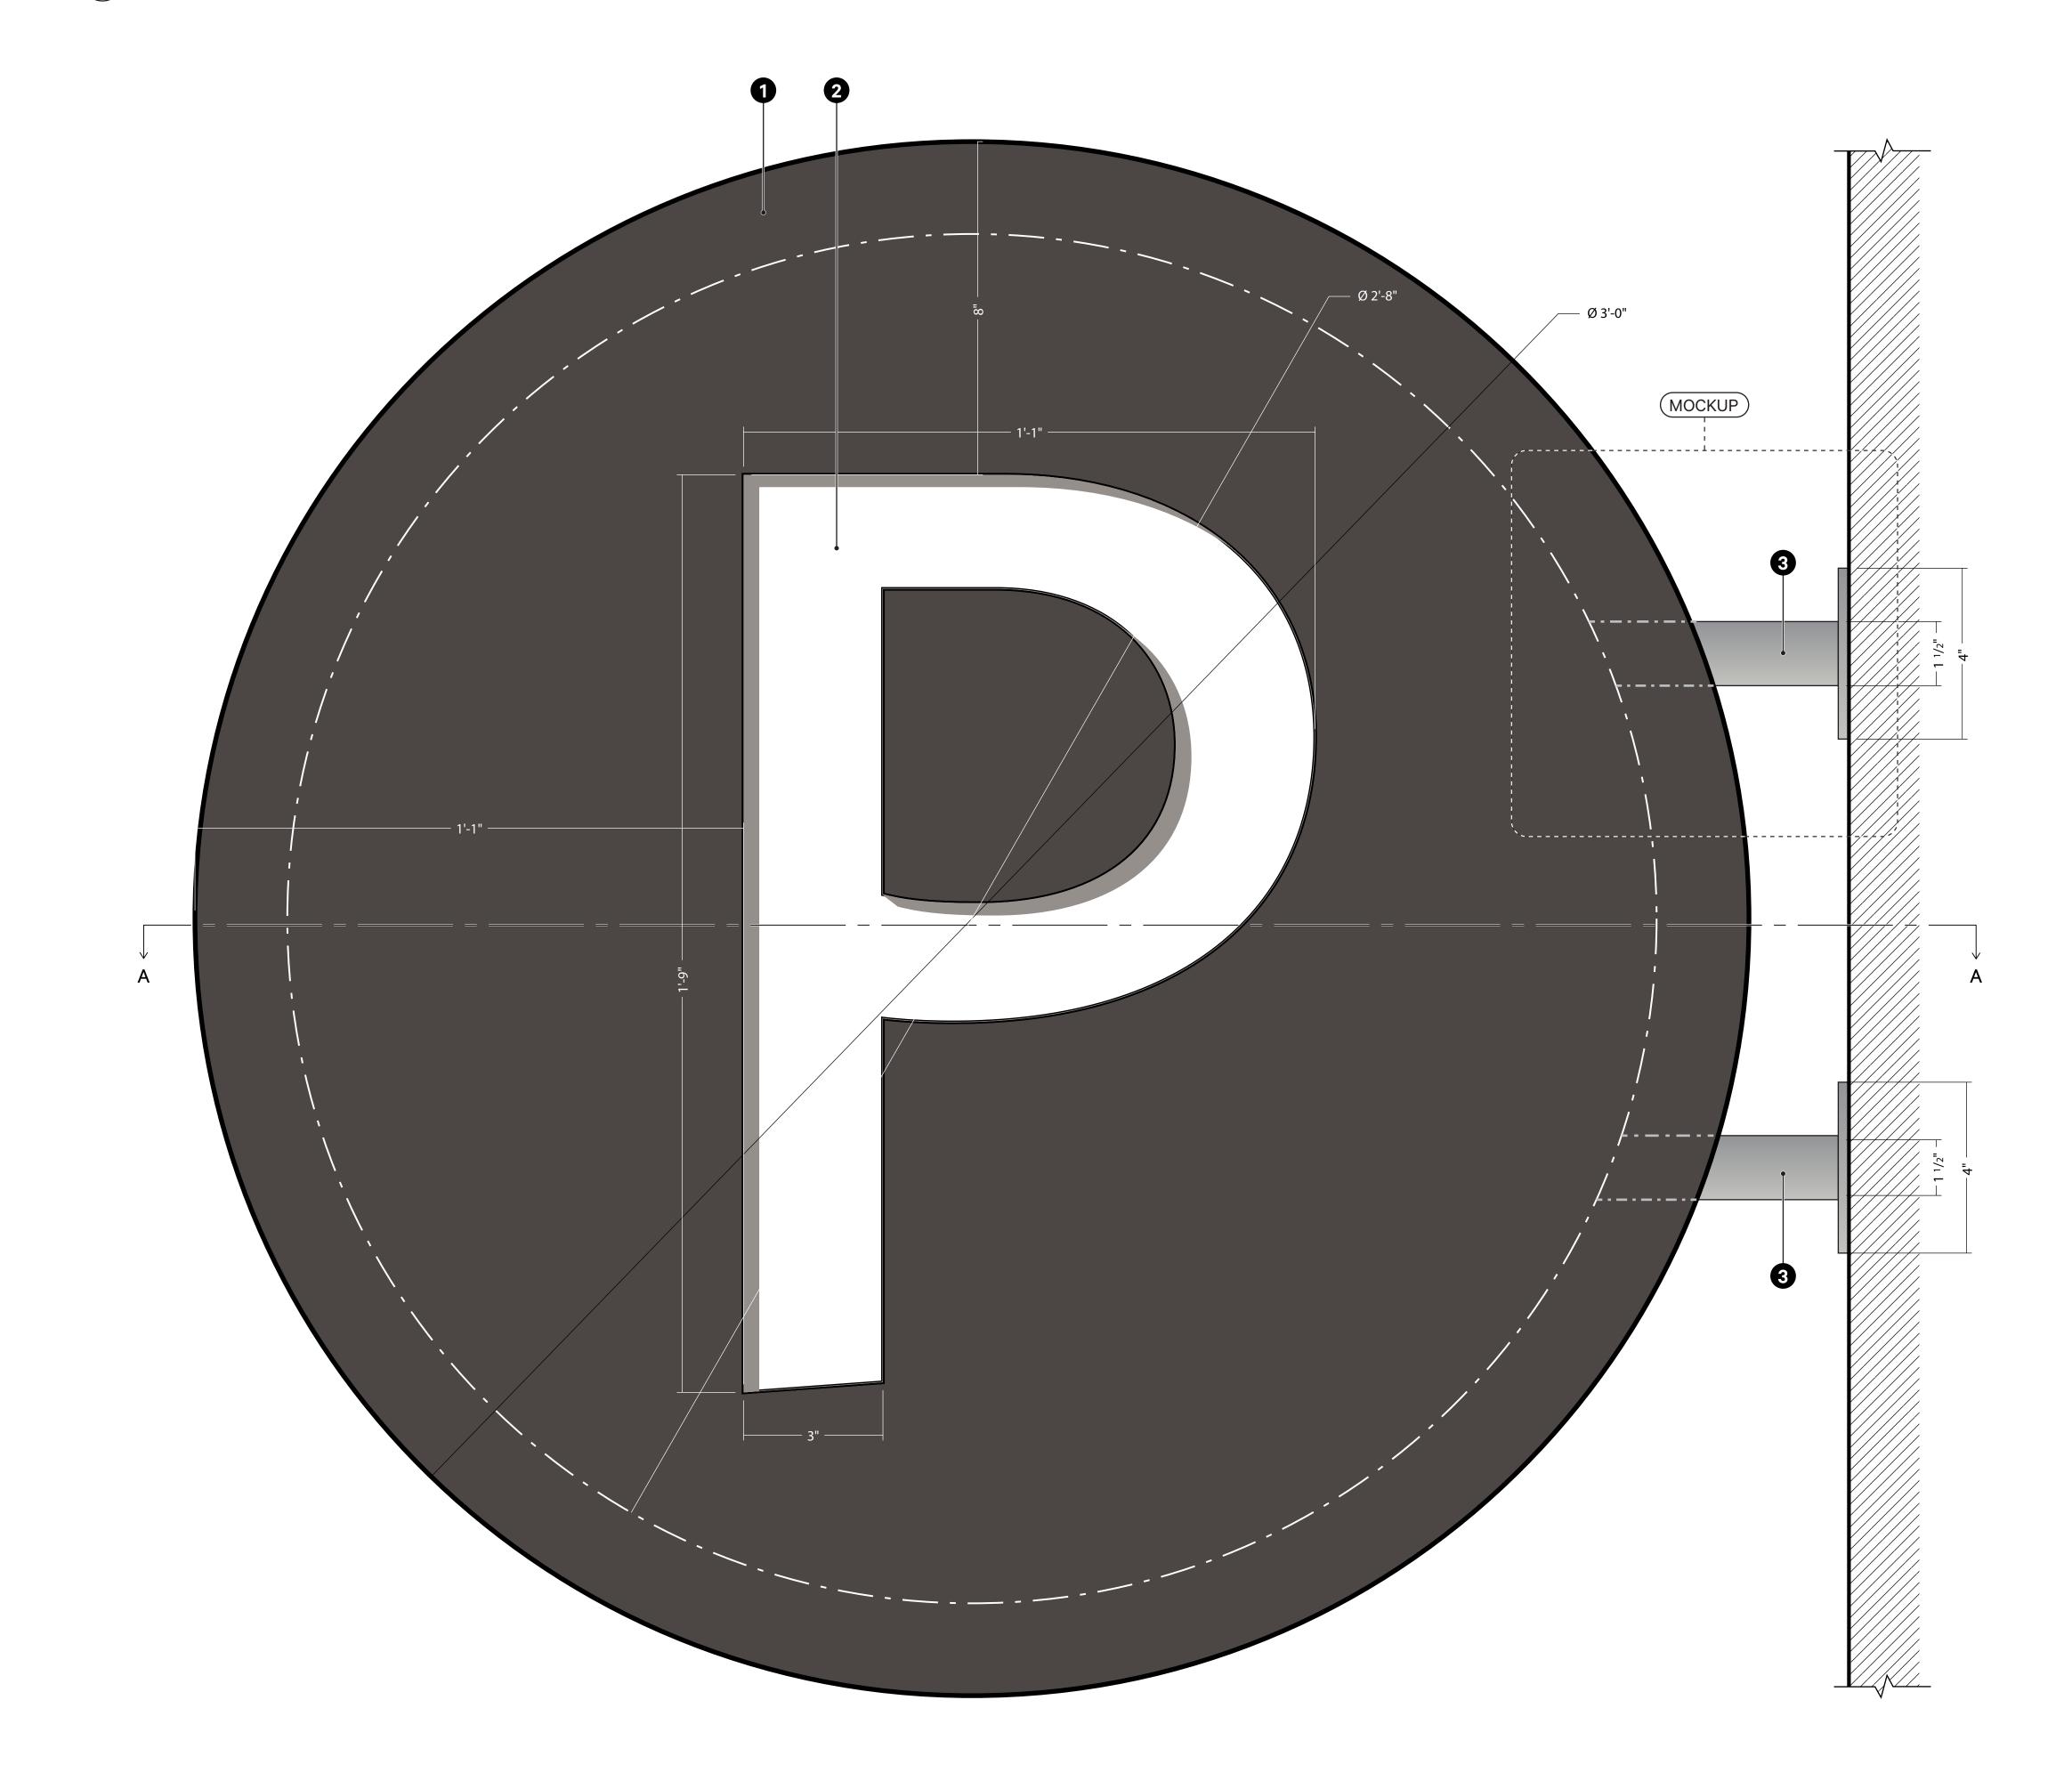

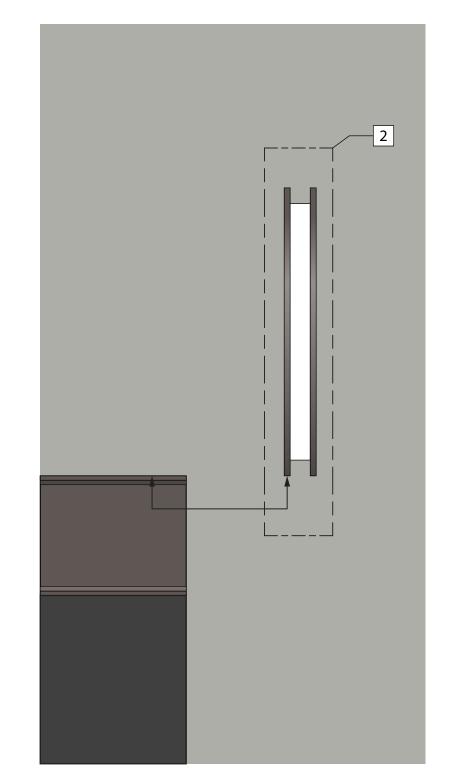

D2: Parking Directional Blade—Placement Elevation

Scale: 1" = 1'-0"

Architecture
Urban Design
Interiors

801 Second Avenue, Suite 501 Seattle, Washington 98104 T 206 682 3460 www.lmnarchitects.com

Studio Matthews

1517 12th Avenue, No 304 Seattle WA 98122 206 432-9641 studiomatthews.com

NORTON BUILDING MODERNIZATION

DESIGN DEVELOPMENT

D2: Parking Directional Blade

TITLE BLOCK