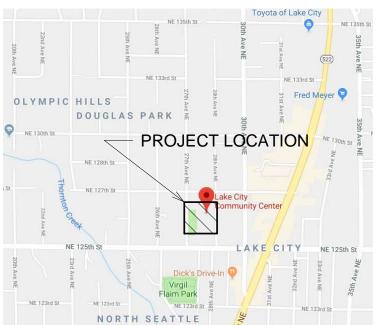
LAKE CITY COMMUNITY CENTER & HOUSING







VICINITY MAP

NTS

CONTACT DATA:

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INNOVA ARCHITECTS ARCHITECT: 950 PACIFIC AVENUE, SUITE 450 TACOMA, WASHINGTON 98402 CONTACT: GEOFF ANDERSON, AIA

TEL: 253-572-4903 EMAIL: ganderson@INNOVAArchitects.com

PROJECT DESCRIPTION:

CONCEPTUALLY THE PLAN IS TO REPLACE THE EXISTING 2-STORY LAKE CITY COMMUNITY CENTER WHICH IS LOCATED INSIDE OF ALBERT DAVIS PARK PROPERTY WITH A NEW 5-STORY COMMUNITY CENTER CONTAINING HOUSING ON TOP. THE PROJECT IS PROPOSING TWO LEVELS OF UNDERGROUND PARKING WITH THE COMMUNITY CENTER OCCUPYING THE FIRST AND SECOND FLOORS IMMEDIATELY ABOVE THE PARKING WITH FIVE LEVELS OF HOUSING UNITS OVER THE COMMUNITY CENTER. THE EXISTING PARK AREA WAS RECENTLY RECONSTRUCTED AND WILL REMAIN WITH SMALL MODIFICATIONS TO PROVIDE ADEQUATE ACCESS FROM THE NEW COMMUNITY CENTER.

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	A1.21	GARAGE FLOOR PARKING -1	A7.22	SUN STUDY AT WINTER TIME (21TH DECEMBER)



950 Pacific Avenue, Suite 450 Tacoma, WA 98402 253-572-4903

Project Title:

CITY LAKE COMMUNITY **CENTER & HOUSING**

12531 28th Avenue NE, Seattle, WA 98125

SEATTLE PARKS AND RECREATION

Job Number:

18-016

Issue Set and Date: SCHEMATIC DESIGN OCTOBER 18 2018

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Revisions:

Sheet Title: TITLE SHEET

Designed by: GEA, GO

Drawn by: GO

Checked by: GEA

Sheet Number:

DAMPPROOFING

DEAD LOAD

DOWN

DISPOSAL, DISPENCER

DISP

DMPF

DN

4RR	REVIATIONS									SYMBO	LS
:	AND AT	DPR DR	DAMPER DOOR	HDWD HDWR	HARDWOOD HARDWARE	OFF OFOI	OFFICE OWNER FURNISHED OWNER	SP SPEC	STANDPIPE SPECIFICATION. SPECIFIED		
) /C	AIR CONDITIONING	DS	DOWNSPOUT	HIWC	HIGH IMPACT WALL COVERING		INSTALLED	SQ	SQUARE	MORI	PROJECT NORTH (PLAN R
	ANCHOR BOLT	DV	DRYER VENT	HM	HOLLOW METAL	OFOI	OWNER FURNISHED/OWNER INSTALLED	SR	SEMI-RECESSED SANITARY SEWER. STAINLESS	•	ONLY - SEE SURVEY FOR TRUE N
	ACOUSTIC ACOUSTIC CEILING BOARD	DW DWG	DISHWASHER DRAWING	HND HO	HANDRAIL, HANDED HOLD-OPEN	ОН	OVERHEAD	SS	STEEL STAINLESS		SEE SURVET FOR TRUET
	ACCESSIBLE	_		HORIZ	HORIZONTAL	OPNG OPP	OPENING OPPOSITE	SSK SSM	SERVICE SINK SOLID SURFACE MATERIAL	A	— SECTION CUT/ELEVATION
US	ASBESTOS CONTAINING MATERIAL ACOUSTICAL	E EA	EAST EACH	HP HPC	HORSE POWER HIGH PERFORMANCE COATING	OR	OUTSIDE RADIUS	SSIVI	STAINLESS STEEL		NUMBER OR LETTER
	ACOUSTICAL CEILING PANEL	EB	EXPANSION BOLT	HR	HOUR	ORD	OVERFLOW ROOF DRAIN ORIENTED STRAND BOARD	ST	STAIN, STONE, STREET	VA6 A8/	- SHEET DRAWN
	ACOUSTICAL CEILING TILE AIR CONDITIONING UNIT	EF EFS	EACH FACE, EXHAUST FAN EXTERIOR FINISH SYSTEM	HS HT	HOOK STRIP, HIGH STRENGTH HEIGHT	OSB OTS	OPEN TO STRUCTURE	STC STD	SOUND TRANSMISSION CLASS STANDARD		— SHEET TAKEN
	AREA DRAIN, ACCESS DOOR	EIFS	EXTERIOR INSULATION & FINISH	HTG	HEATING	Б	DOMED	STL	STEEL		— DETAIL NUMBER
ı	ADDENDUM, ADDITIVE ADDITIONAL	EJ	SYSTEM EXPANSION JOINT	HTR HVAC	HEATER HEATING/VENTILATION/AIR	P PA	POWER PUBLIC ADDRESS	STRUCT SURF	STRUCTURE, STRUCTURAL SURFACE		
DL J	ADJACENT, ADJUSTABLE	EL	ELEVATION	TIVAC	CONDITIONING	PAR	PARALLEL	SUSP	SUSPENDED	A8	
	ACOUSTICAL FABRIC COVER	ELEC ELEV	ELECTRIC(AL) ELEVATOR. ELEVATION	HVC HW	HOSE VALVE CABINET HOT WATER	PB PBD	PANIC BAR PARTICLE BOARD	SV SWL	SHEET VINYL STATIC WATER LEVEL		— SHEET DRAWN
i	ABOVE FINISH FLOOR ABOVE FINISH GRADE	EM	ENTRY MAT	HW	HOT WATER TANK	PC	PRECAST, POINT OF CURVE	SWR	SEWER		
6	AGGREGATE	EN ENCL	ENAMEL ENCLOSURE	HWD HWY	HOT WATER DISPENSER HIGHWAY	PERF PERP	PERFORATED PERPENDICULAR	SYM	SYMMETRICAL		— DETAIL NUMBER
М	ALTERNATE ALUMINUM	EOS	EDGE OF SLAB	HYD	HYDRANT	PF	PREFABRICATED	PTN	PARTITION (TOILET)	1	— SHEET DRAWN
D	ANODIZED	EP	ELECTRICAL PANEL	ID.	INCIDE DIMENSION INCIDE	PI PJ	POINT OF INTERSECTION PANEL JOINT	T	TEMPERED GLASS	A6 A8	
	ACCESS PANEL ACOUSTICAL PANEL CEILING	EPX EQ	EPOXY EQUALLY	ID	INSIDE DIMENSION, INSIDE DIAMETER	PL	PLATE	T&B T&G	TOP & BOTTOM TONGUE & GROOVE		— SHEET TAKEN
D	APPROVED	EQUIP	EQUIPMENT	IE IN	INVERT ELEVATION INCH	PLAM	PLASTIC LAMINATE	ТВ	TOWEL BAR	1	
ROX	APPROXIMATE(LY) APARTMENT UNIT	ES EST	EACH SIDE ESTIMATE(ED)	IN INCL	INCLUDE(D, ING)	PLAS PLYWD	PLASTER PLYWOOD	TEL TER, TZ	TELEPHONE TERRAZZO		SHEET ON WHICH INTERIO
Н	ARCHITECTURE (URAL)	EW	EACH WAY	INFO	INFORMATION	PNL	PANEL	TESC	TEMPORARY EROSION &	2 (A1.601) 4	ELEVATION IS DRAWN
1	ASPHALT	EWC EX	ELECTRIC WATER COOLER EXPANSION	INSUL INT	INSULATE(D), (ION) INTERIOR	PNT POC	PAINT POINT OF CONNECTION	TFOI	SEDIMENTATION CONTROL TENANT FURNISHED/OWNER		
	AVENUE ACOUSTICAL WALL FABRIC	EXC	EXPANSION EXCAVATE	INV	INVERT	POL	POLISHED		INSTALLED	3	
•	ACOUSTICAL WALL PANEL	EXH EXIST, (E)	EXHAUST EXISTING	IPS	IRON PIPE SIZE	POLY PP	POLYETHYLENE POWER POLE	THK TKBD	THICK(NESS) TACKBOARD	-	
	ANGLE	EXIST, (E) EXP	EXISTING EXPANSION	JAN	JANITOR	PR	PAIR	ТО	TOP OF	1	
	ВАТН	EXT	EXTERIOR	JB	JUNCTION BOX	PRCST	PRECAST	TOB TOC	TOP OF BEAM TOP OF CURB. TOP OF CONCRETE.		— SHEET ON WHICH
	BARBEQUE BOARD	F/F	FACE TO FACE	JST JT	JOIST JOINT	PREFAB PROP	PREFABRICATED PROPERTY		TOP OF COLUMN	(A1.301)	ELEVATION IS DRAWN
	BOTH FACES	FA	FIRE ALARM			PSF	POUNDS PER SQUARE FOOT	TOF TOM	TOP OF FOUNDATION TOP OF MASONRY	711.001)	
,	BITUMEN, BITUMINOUS	FBO FD	FURNISHED BY OTHERS FLOOR DRAIN	K, KIT KD	KITCHEN KILN DRIED	PSI PSL	POUNDS PER SQUARE INCH PARALLEL STRAND LUMBER	TOP	TOP OF PAVEMENT, TOP OF PLATE		
G (G)	BUILDING BLOCK(ING)	FDCS	FOLD DOWN CHANGING STATION	KDF	KNOCK DOWN FRAME	PT	POINT, PRESSURE TREATED	TOS	TOP OF WALL	(1)	DOOR TYPE
	BEAM, BENCH MARK	FDN FE	FOUNDATION FIRE EXTINGUISHER	KO KP	KNOCK OUT KICK PLATE	PTD/WR	PAPER TOWEL DISPENSER & WASTE RECEPTACLE	TOW TP	TOP OF WALL TOILET DISPENSER	A	FRAME TYPE
	BOTTOM OF BOTTOM	FEC	FIRE EXTINGUISHER FIRE EXTINGUISHER CABINET	KS	KNEE SPACE	PVC	POLYVINYL CHLORIDE	TRAN	TRANSPARENT	<u></u>	TIMINE TIPE
	BRICK, BEDROOM	FF	FACTORY FINISH	1	LONG, LENGTH, LEFT	PVG PVMT	PAVING PAVEMENT	TRD TS	TREAD TUBE STEEL	1	WALL TYPE
	BEARING BACKSPLASH	FF&E	FURNITURE, FIXTURES & EQUIPMENT	LAM	LAMINATE	PW	POTABLE WATER, PLYWOOD	TTD	TOILET TISSUE DISPENSER		
	BASEMENT	FGL	FIBERGLASS	LAV	LAVATORY	PWT	PREFABRICATED WOOD TRUSS	TTH TV	TOOTHBRUSH HOLDER TELEVISION	[1]	DEMO FLAG NOTE
N	BETWEEN BUILT-UP ROOFING	FH FHC	FIRE HYDRANT FIREHOSE CABINET	LB LBS, #	LAG BOLT POUNDS	QT	QUARRY TILE	TWC	TEXTILE WALL COVERING	⟨ <u>12</u> ⟩	WORK FLAG NOTE
₹	Boilet of Noor inc	FIN	FINISH(ED)	LF	LINEAL FOOT/FEET	QUAN	QUANTITY	TYP	TYPICAL		
	CENTERLINE CHANNEL	FL FLUOR	FLOOR(ING) FLUORESCENT	LG LH	LENGTH, LONG LEFT HAND	R	RADIUS, RISER, THERMAL	U/C	UNDER COUNTER	(13.5)	GRID LINE
	COMPLETE WITH	FM	FACTORY MUTUAL	LHR	LEFT HAND REVERSE	R&R	RESISTANCE REMOVE & REPLACE	UC UFAS	UNDERCUT UNIFORM FEDERAL ACCESSIBILITY		
	CABINET, CEMENT ASBESTOS	FND FO, F/O	FEMININE NAPKIN DISPOSAL FACE OF	LKR LL	LOCKER LIVE LOAD	r&r R&S	REMOVE & REPLACE ROD & SHELF	UFAS	STANDARDS		INDICATES FRONT OF THE
	BOARD CATCH BASIN	FOC FOC	FACE OF CONCRETE OR CMU	LMS	LIQUID MARKING SURFACE	RA	RETURN AIR	UG	UNDERGROUND	▼	
	CEMENTIOUS BACKER UNITS	FOF	FACE OF FINISH	LPT	LOW POINT	RAD, R RB	RADIUS RESILIENT BASE, RUBBER BASE	UL UNF	UNDERWRITERS LABORATORIES UNFINISHED		DOOR NUMBER
И R	CEMENT CERAMIC	FOIC	FURNISHED BY OWNER/INSTALLED BY CONTRACTOR	LRH LRH	LIGHT REFLECTIVE HARDNER LIGHT REFLECTIVE HARDNER	RBR	RUBBER	UNO	UNLESS NOTED OTHERWISE	<u>[10]</u>	DOOK NUMBER
1	CUBIC FEET	FOIO	FURNISHED BY OWNER/INSTALLED BY OWNER	LS	LANDSCAPE	RD RD/O	ROOF DRAIN, ROAD ROOF DRAIN OVERFLOW	UR UV	URINAL ULTRA VIOLET		
	CONTRACTOR FINISHED/CONTRACTOR INSTALLED	FOM	FACE OF MASONRY	LSD LT	LIQUID SOAP DISPENSER LIGHT	REBAR	REINFORCING BAR			KITCHEN 113	ROOM IDENTIFICATION NU
	CUBIC FEET PER MINUTE	FOS FP	FACE OF STUD FIREPLACE	LTG	LIGHTING	REC RECEP	RECESSED RECEPTACLE	V VAR	VENT VARIES		
	CONDUCTIVE FLOOR TILE CORNER GUARD	FPRF	FIREPROOFING	LVR LWC	LOUVER LIGHTWEIGHT CONCRETE	RECIRC	RECIRCULATION	VAT	VINYL ASBESTOS TILE	⊸ UP/DN	STAIR OR SLOPE DIRECTI
CHAN	CHANNEL	FPWH	FREEZE PROOF WALL HYDRANT			RECT	RECTANGULAR	VCT VENT	VINYL COMPOSITION TILE VENTILATOR		
	CAST IRON CAST IN PLACE	FR FRC	FIRE-RESISTIVE FIBER REINFORCED CONCRETE	MACH MAS	MACHINE MASONRY	REF REG	REFERENCE, REFRIGERATOR REGISTER	VERT	VERTICAL	 X	CHAIN LINK FENCE
	CONTROL JOINT	FRCB	FIBER REINFORCED CEMENT	MAT	MATERIAL	REINF	REINFORCE(D)(ING)	VEST	VESTIBULE	1	
	CHAIN LINK FENCE	FRG	BOARD FIBER REINFORCED GYPSUM	MAX	MAXIMUM	REQ RESIL	REQUIRED, REQUIREMENT RESILIENT	VG VIN	VERTICAL GRAIN VINYL		ELEVATION INDICATOR
	CEILING CAULKING	FRP	FIBERGLASS REINFORCED PLASTIC	MB MDF	MACHINE BOLT MEDIUM DENSITY FIBERBOARD	RET	RETAINING	VR	VAPOR RETARDER		1 HR SEPARATION
	CLOSET	FS FT	FLOOR SINK FOOT, FEET	MDO	MEDIUM DENSITY OVERLAY	REV RFG	REVISION ROOFING	VTR VWC	VENT THROUGH ROOF VINYL WALL COVERING		
J	CLEAR(ANCE) CONCRETE MASONRY UNIT	FTG	FOOTING	MECH MEMB	MECHANICAL MEMBRANE	RH	RIGHT HAND, RELATIVE HUMIDITY,			VINYLCPT	FLOOR MATERIAL INDICAT
	CLEAN OUT	FURR FUT	FURRING, FURRED FUTURE	MEZZ	MEZZANINE	RHR	ROBE HOOK RIGHT HAND REVERSE	W W/	WATER, WEST, WIDE, WIDTH, WASH WITH		
- NC	COLUMN CONCRETE	101	TOTORE	MFR MH	MANUFACTURER MANHOLE	RL	RAIN LEADER	W/I	WITHIN	=	VIDUAL DISCIPLINE SHEETS F
NN	CONNECTION	G	GAS	MIN	MINIMUM	RM	ROOM ROUGH OPENING	W/O	WITHOUT WALL TO WALL	ADDITIONAL SY	/MBOLS AND ABBREVIATIONS
NST	CONSTRUCTION CONTINUOUS	GA GAL	GAUGE GALLON	MIR MISC	MIRROR MISCELLANEOUS	RO RR	RAILROAD	W/W WB	WALL BASE, WASTE BASKET	DIMENSIONS A	RE FACE OF STUD, FACE OF S
NT ORD	COORDINATE	GALV	GALVANIZED	MLDG	MOLDING	RS	ROUGH SAWN	WC	WATER CLOSET, WALL COVERING	OR CENTER OF	•
RR	CORRIDOR	GALV STL GB	GALANIZED STEEL GRAB BAR	MO	MASONRY OPENING	RT RWL	RESILIENT TILE RAIN WATER LEADER	WD WF	WOOD WIDE FLANGE		
- S	CARPET(ED) COURSE(ES)	GC	GENERAL CONTRACTOR	MOD MR	MODIFIED MOISTURE RESISTANT			WG	WIRE GLASS		
	CONCRETE SEALER	GD GEN	GARBAGE DISPOSAL GENERAL	MTD	MOUNTED	S S/MH	SLOPE, SOUTH SHELF/MOP HOLDER	WH WIN	WATER HEATER, WALL HUNG WINDOW		
1	CASE WORK CERAMIC TILE	GFCI	GROUND FAULT CIRCUIT	MTL MUL	METAL MULLION	S/V	STAIN & VARNISH	WM	WIRE MESH		
S	CERAMIC TILE CORNER SHELF	GFRC	INTERRUPTOR GLASS FIBER REINFORCED	MW	MICROWAVE OVEN	SAM SAN	SELF ADHERING MEMBRANE SANITARY, SEWER	WP WPL	WATER PROOF, WORKING POINT WEATHER PROOF LOUVER		
R SK	COUNTER COUNTER SINK		CONCRETE	NP	NOT PROVIDED	SC	SOLID CORE	WR	WASTE RECEPTACLE, WATER		
,	CABLE TELEVISION	GFRG	GLASS FIBER REINFORCED GYPSUM	(N)	NEW	SCHED	SEAT COVER DISPENSER	WR/GWB	REPELLANT, WATER RESISTANT WATER RESISTANT GWB		
	CUBIC COLD WATER	GFRP	GLASS FIBER REINFORCED	N N/A	NORTH NOT APPLICABLE	SCHED SCR	SCHEDULE SHOWER CURTAIN ROD	WRB	WEATHER RESISTANT BARRIER		
3	COLD WATER CAPILLARY WATER BARRIER	GKT	PLASTER GASKET	N/A N/C	NOT APPLICABLE NONCOMBUSTIBLE	SD	SOAP DISPENSER, STORM DRAIN,	WS	WOOD SCREW, WATERSTOP, WEATHERSTRIP		
	CUBIC YARD(S)	GL	GLASS, GLAZING, GLAZED	NAT	NATURAL NON EDGGE CHICAGO	SECT	SMOKE DETECTOR SECTION	WSCT	WAINSCOT		
	DEEP, DEPTH, DRYER	GLU-LAM GND	GLUE-LAMINATED GROUND	NFS NFVA	NON-FROST SUSCEPTIBLE NET FREE VENT AREA	SF	SQUARE FOOT/FEET	WT	WEIGHT, WATER TANK		
R	PENNY NAILS	GPM	GALLONS PER MINUTE	NIC	NOT IN CONTRACT	SFP SG	SPRAY-ON FIREPROOFING SAFETY GLAZING	WWF	WELDED WIRE FABRIC		
	DOUGLAS FIR DOUBLE	GR GS	GRADE GALVANIZED STEEL	NO, # NOM	NUMBER NOMINAL	SGL	SINGLE	X BRACE	CROSS BRACE		
0	DEMOLITION, DEMOLISH	GSF	GROSS SQUARE FOOT(AGE)	NOM NR	NONRATED	SH SHT	SHOWER SHEET	YD	YARD, YARD DRAIN		
т	DEPRESSED	GSL	GYPSUM SHAFT LINER	NRC	NOISE REDUCTION COEFFICIENT	SHTG	SHEATHING	=	,		
PT Γ, DTL	DEPARTMENT DETAIL	GWB GYP	GYPSUM WALL BOARD GYPSUM	NSF NTS	NET SQUARE FEET NOT TO SCALE	SIM	SIMILAR				
,	DRINKING FOUNTAIN	GYP SHTG	GYPSUM SHEATHING			SLR SLV	SEALER SLEEVE				
	DUCTILE IRON, DEIONIZED WATER DIAMETER	Н	HIGH	O O/O	OVER OUT TO OUT	SM	SHEET METAL, SHOWER MODULE				
G	DIAGONAL	НВ	HOSE BIB	OA	OVERALL	SMHC SMR	SHOWER MODULE HANDICAPPED SURFACE METAL RACEWAY				
_	DIMENCIONI	HBGC	HIGH BUILD GLAZE COATING	OC	ON CENTER	SND	SANITARY NAPKIN DISPENSER,				
IM IM PT	DIMENSION DIMENSION POINT	HC	HANDICAP, HOLLOW CORE	OD	OUTSIDE DIMENSION, OVERFLOW	SND	SANITARY NAPKIN DISPOSAL				

OWNER FURNISHED/CONTRACTOR INSTALLED

OUTSIDE FACE

HAND DRYER, HAIR DRYER

HIGH DENSITY OVERLAID

HOLLOW CLAY TILE

HEADER

HDR

SANITARY NAPKIN DISPOSAL

SLAB ON GRADE

SHUT OFF VALVE

NORTH (PLAN REFERENCE EY FOR TRUE NORTH)

I WHICH INTERIOR N IS DRAWN

FRONT OF THE BUILDING

NTIFICATION NUMBER

SLOPE DIRECTION

TERIAL INDICATOR

LINE SHEETS FOR BBREVIATIONS

TUD, FACE OF STRUCTURE,



950 Pacific Avenue, Suite 450 Tacoma, WA 98402 253-572-4903

Project Title:

CITY LAKE COMMUNITY **CENTER & HOUSING**

12531 28th Avenue NE, Seattle, WA 98125

Client:

SEATTLE PARKS AND RECREATION

Job Number:

18-016

Issue Set and Date: SCHEMATIC DESIGN OCTOBER 18 2018

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Revisions:

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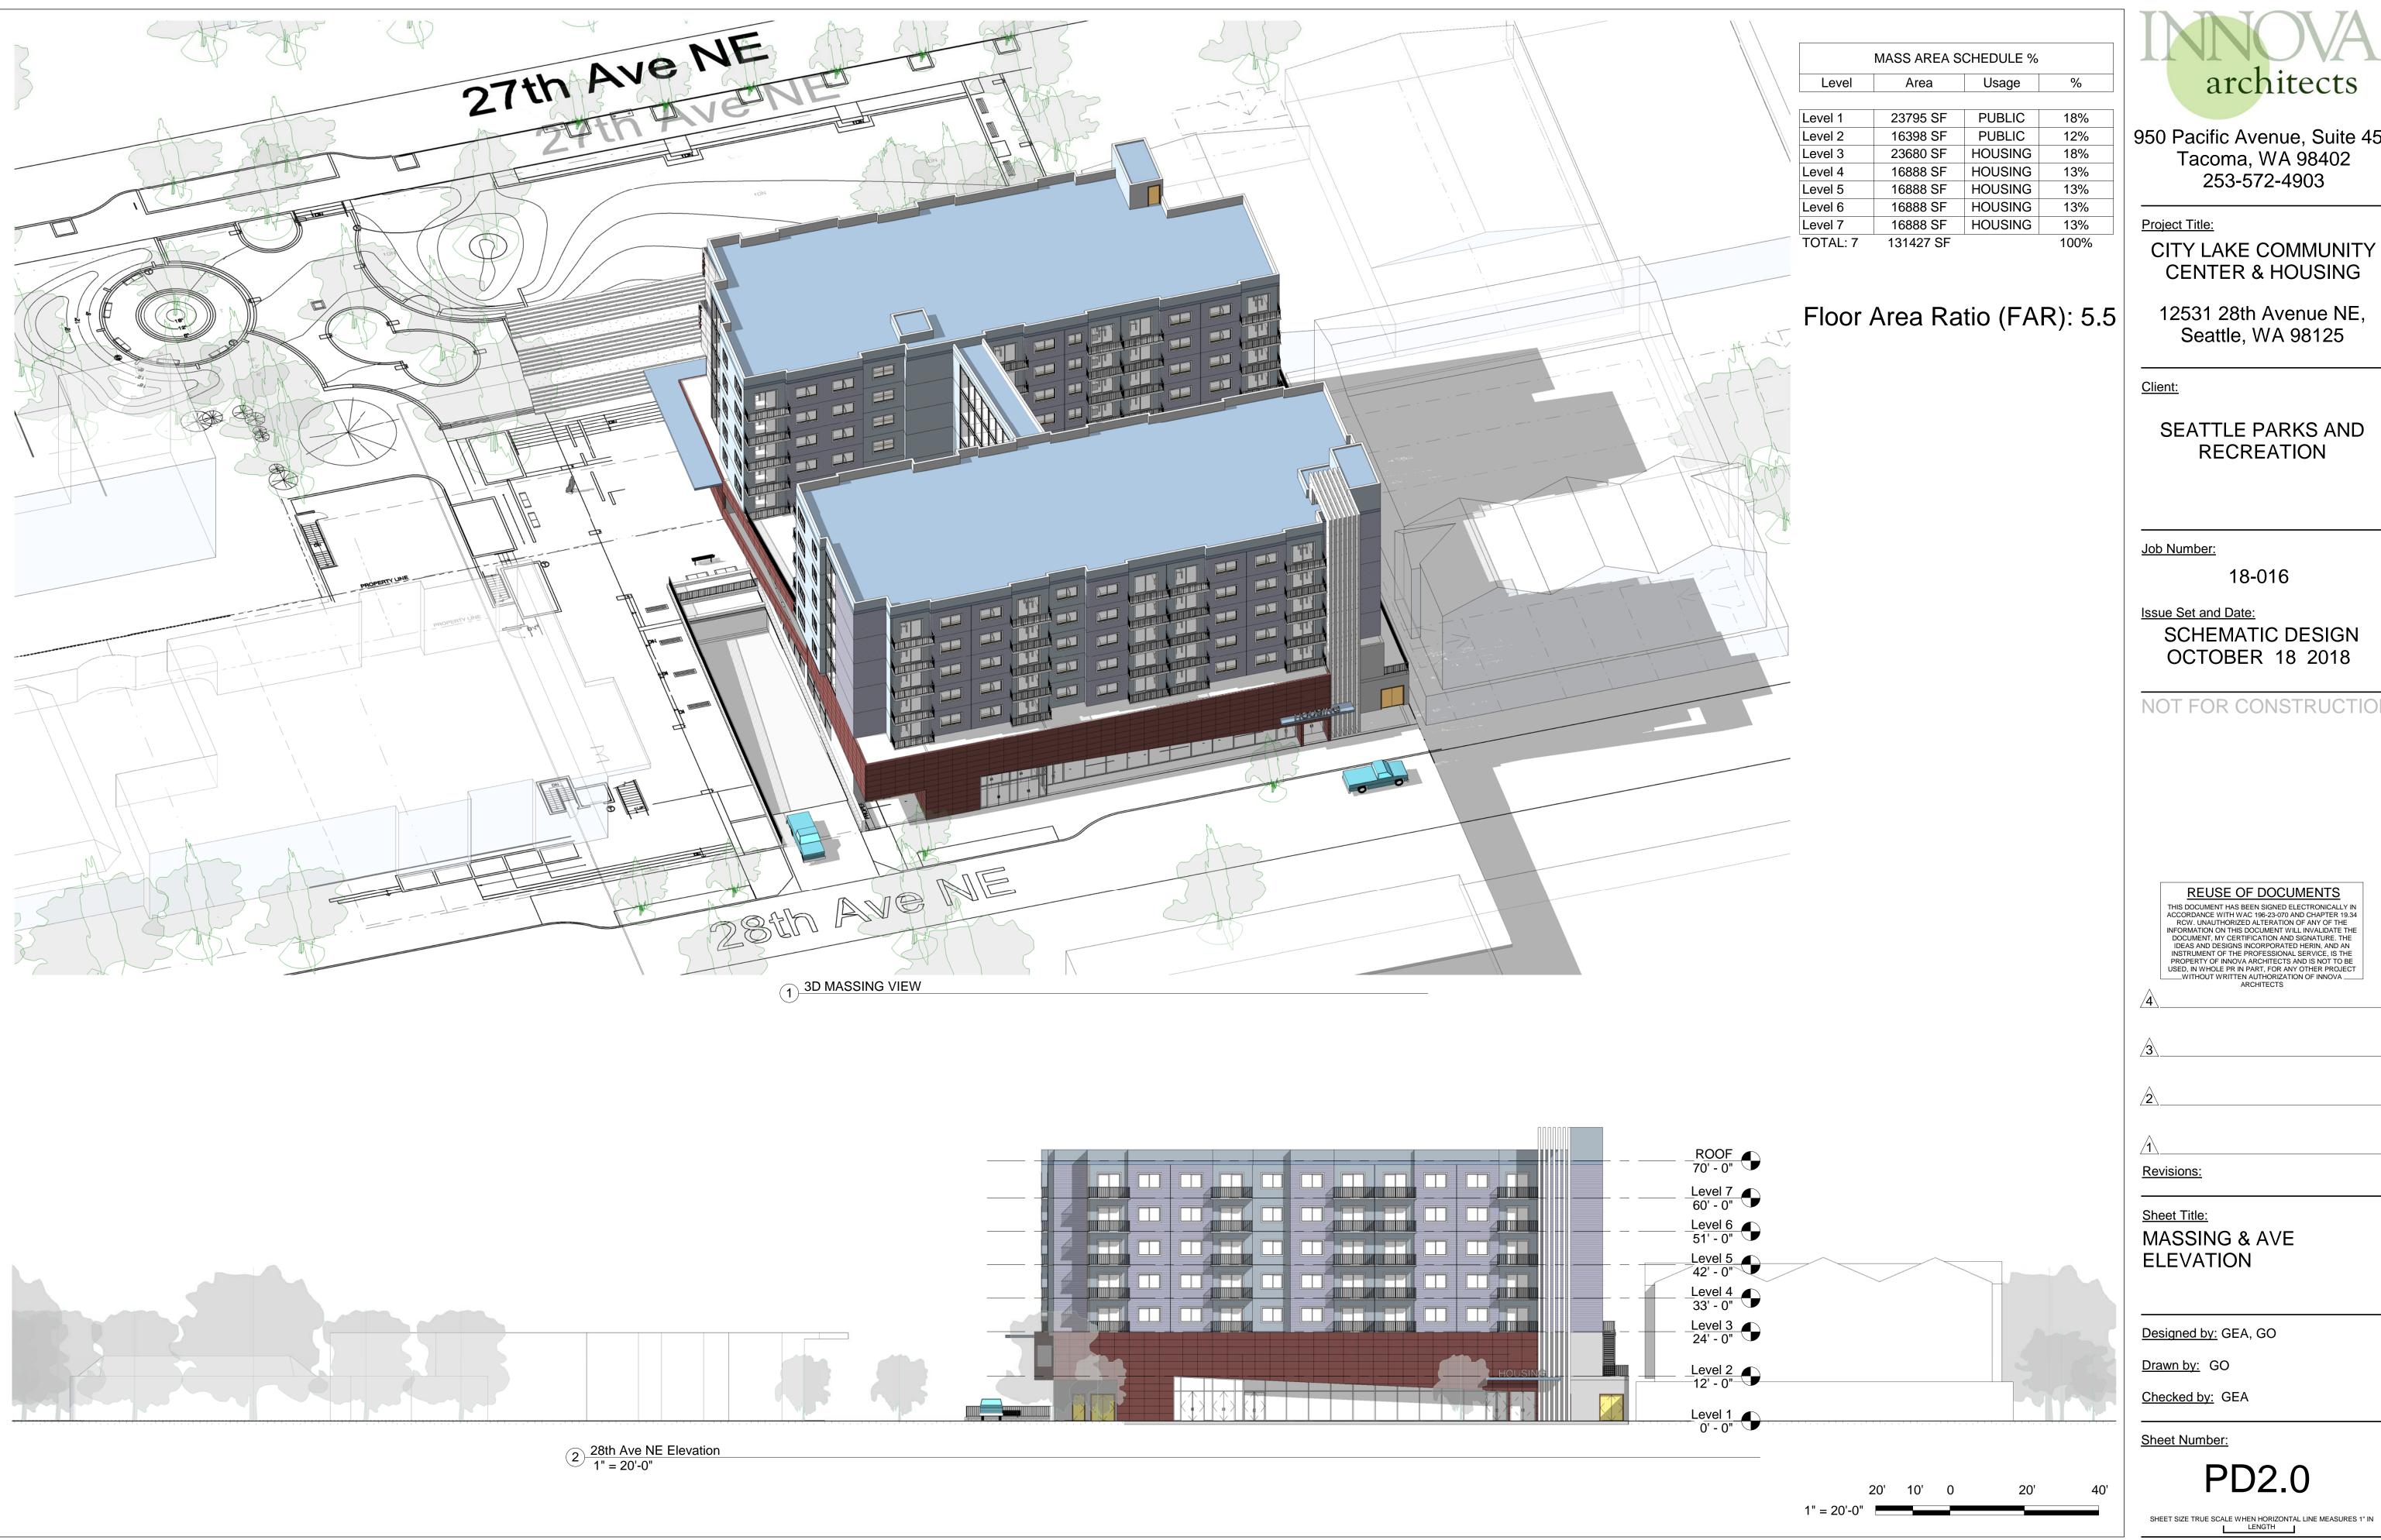
Designed by: GEA

Drawn by: GO

Checked by: GEA

Sheet Number:

PD1.0



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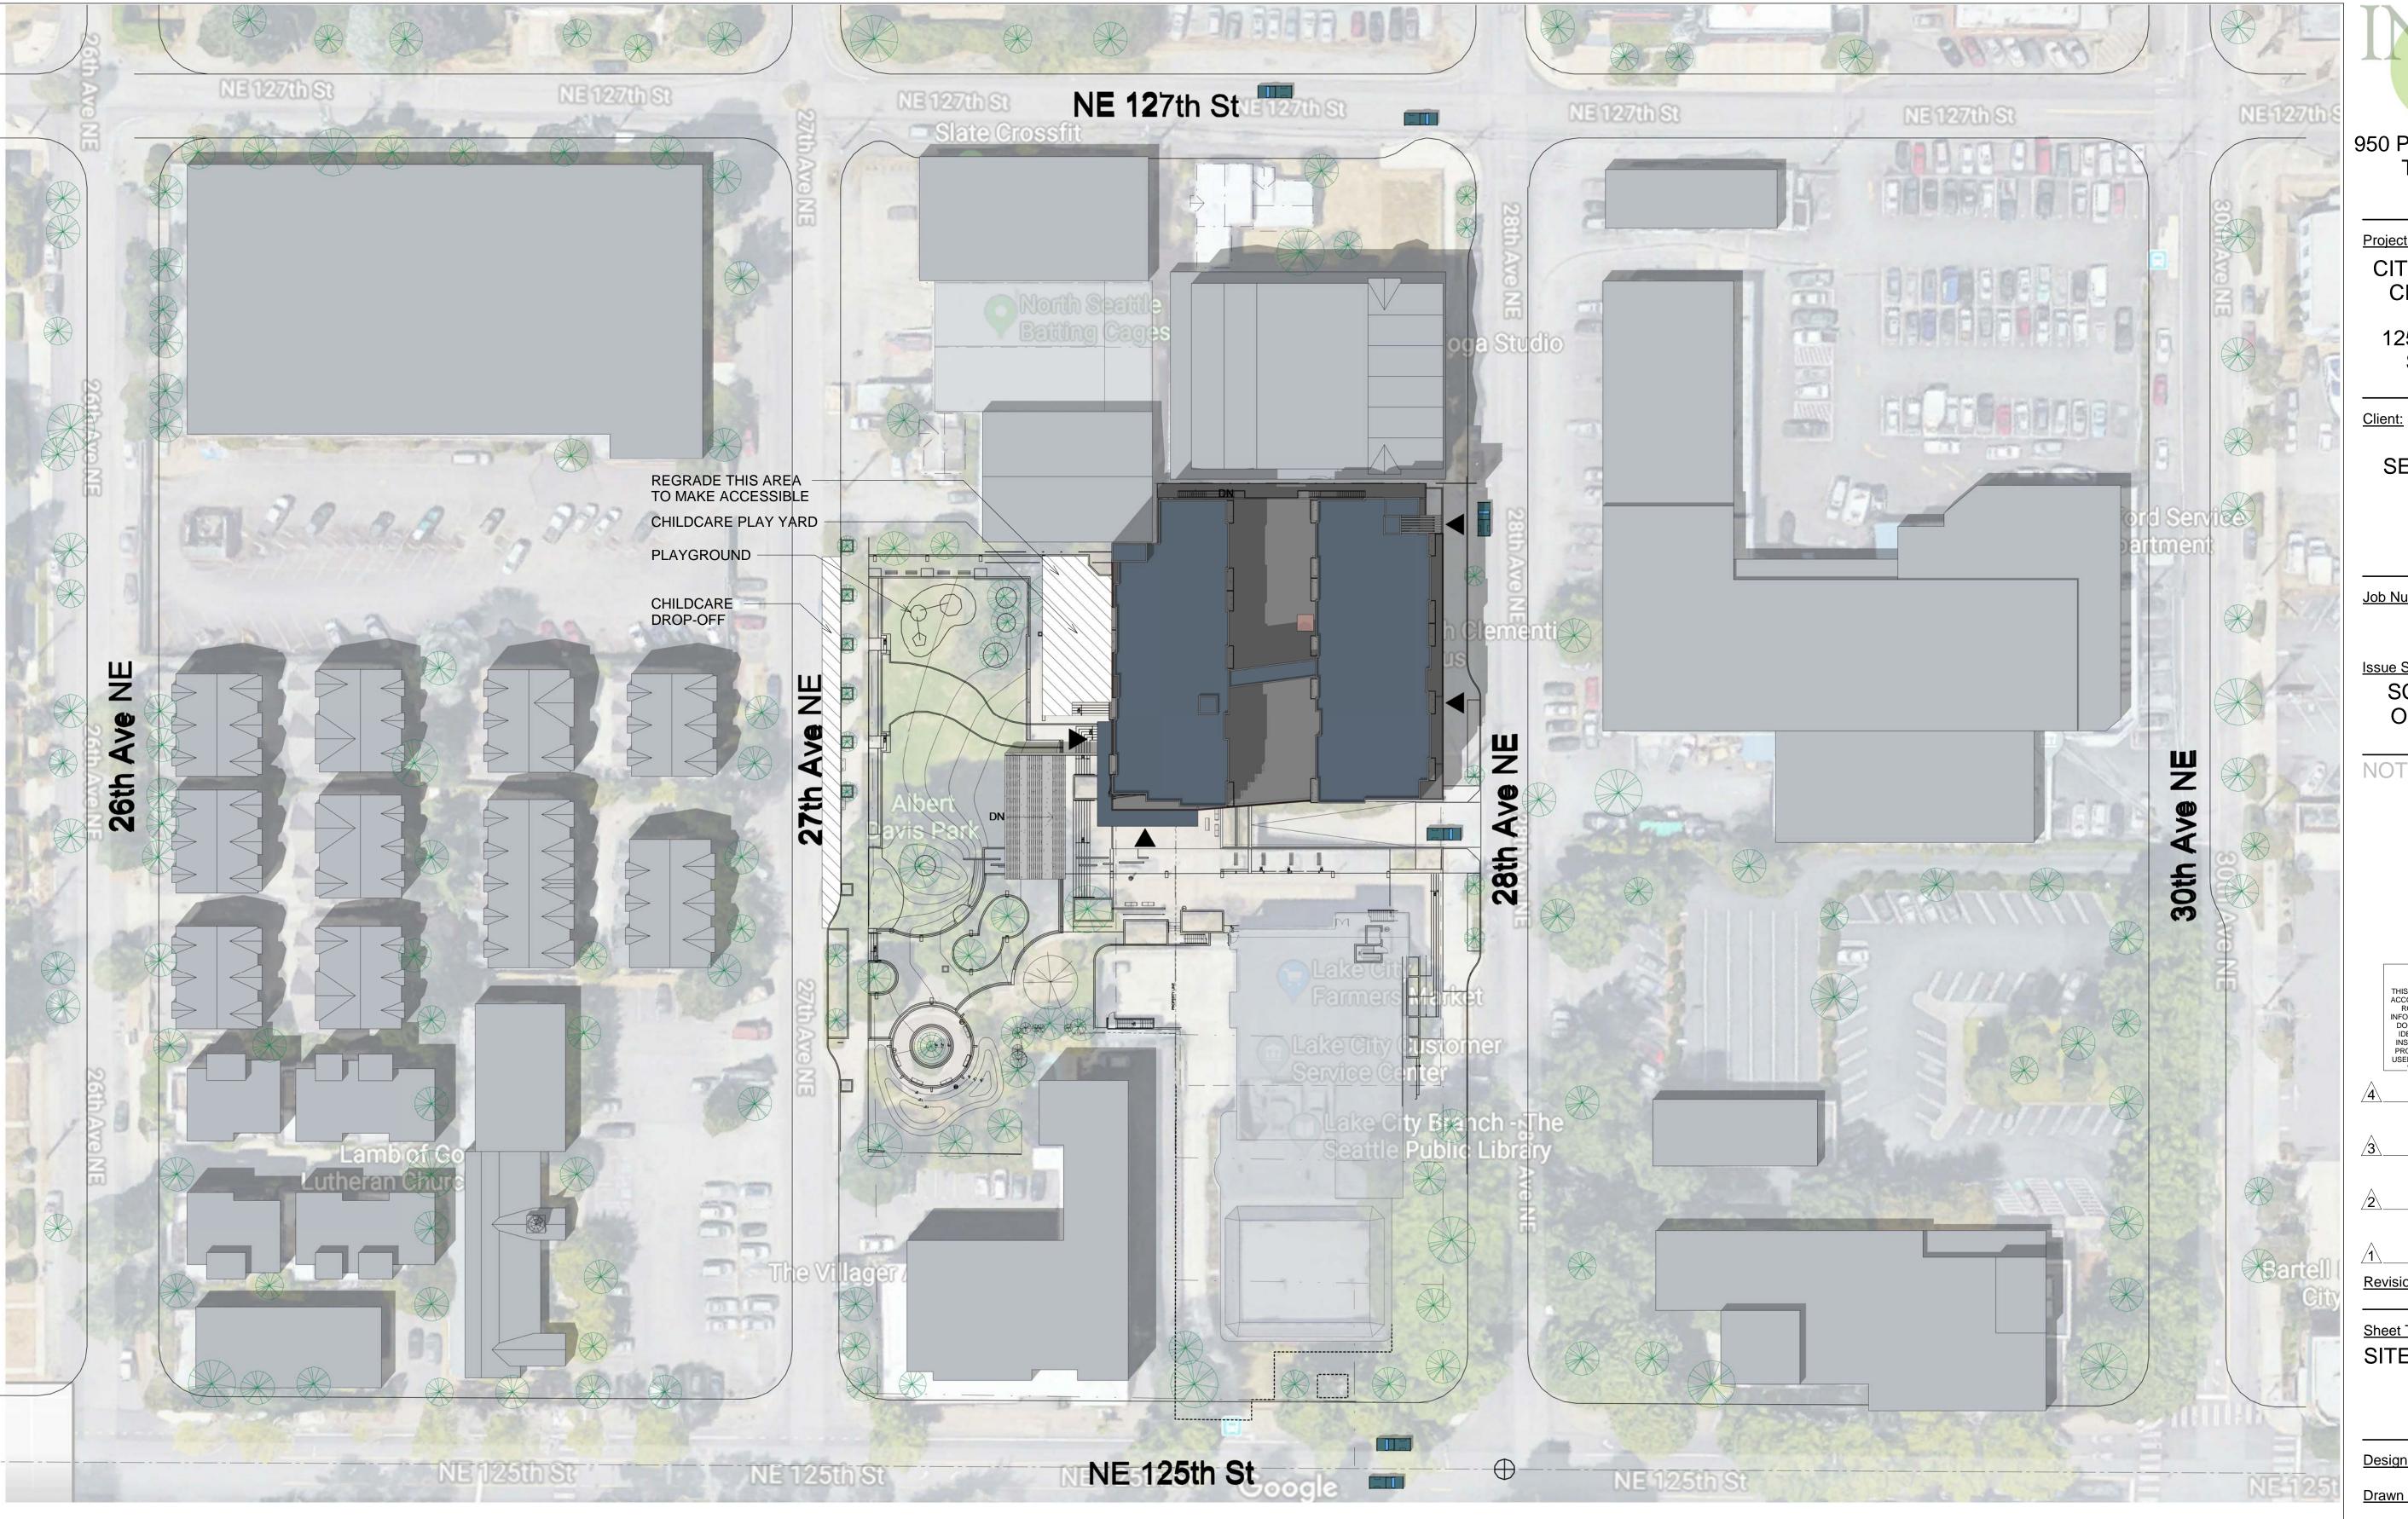
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Revisions:

Sheet Title: SITE PLAN

Designed by: GEA, GO

Drawn by: GO

Checked by: GEA

Sheet Number:

SD1.1

SHEET SIZE TRUE SCALE WHEN HORIZONTAL LINE MEASURES 1" IN LENGTH

1 SITE MAP 1" = 40'-0"



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1ST FLOOR -**COMMUNITY CENTER**

Designed by: GEA, GO

Checked by: GEA

Sheet Number:



18-016



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Revisions:

Sheet Title:

3RD FLOOR - HOUSING,
COURTYARDS

Designed by: GEA, GO

Drawn by: GO

Checked by: GEA

Sheet Number:

Λ1 12



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Revisions:

Sheet Title:

4TH - 7TH FLOORS -HOUSING

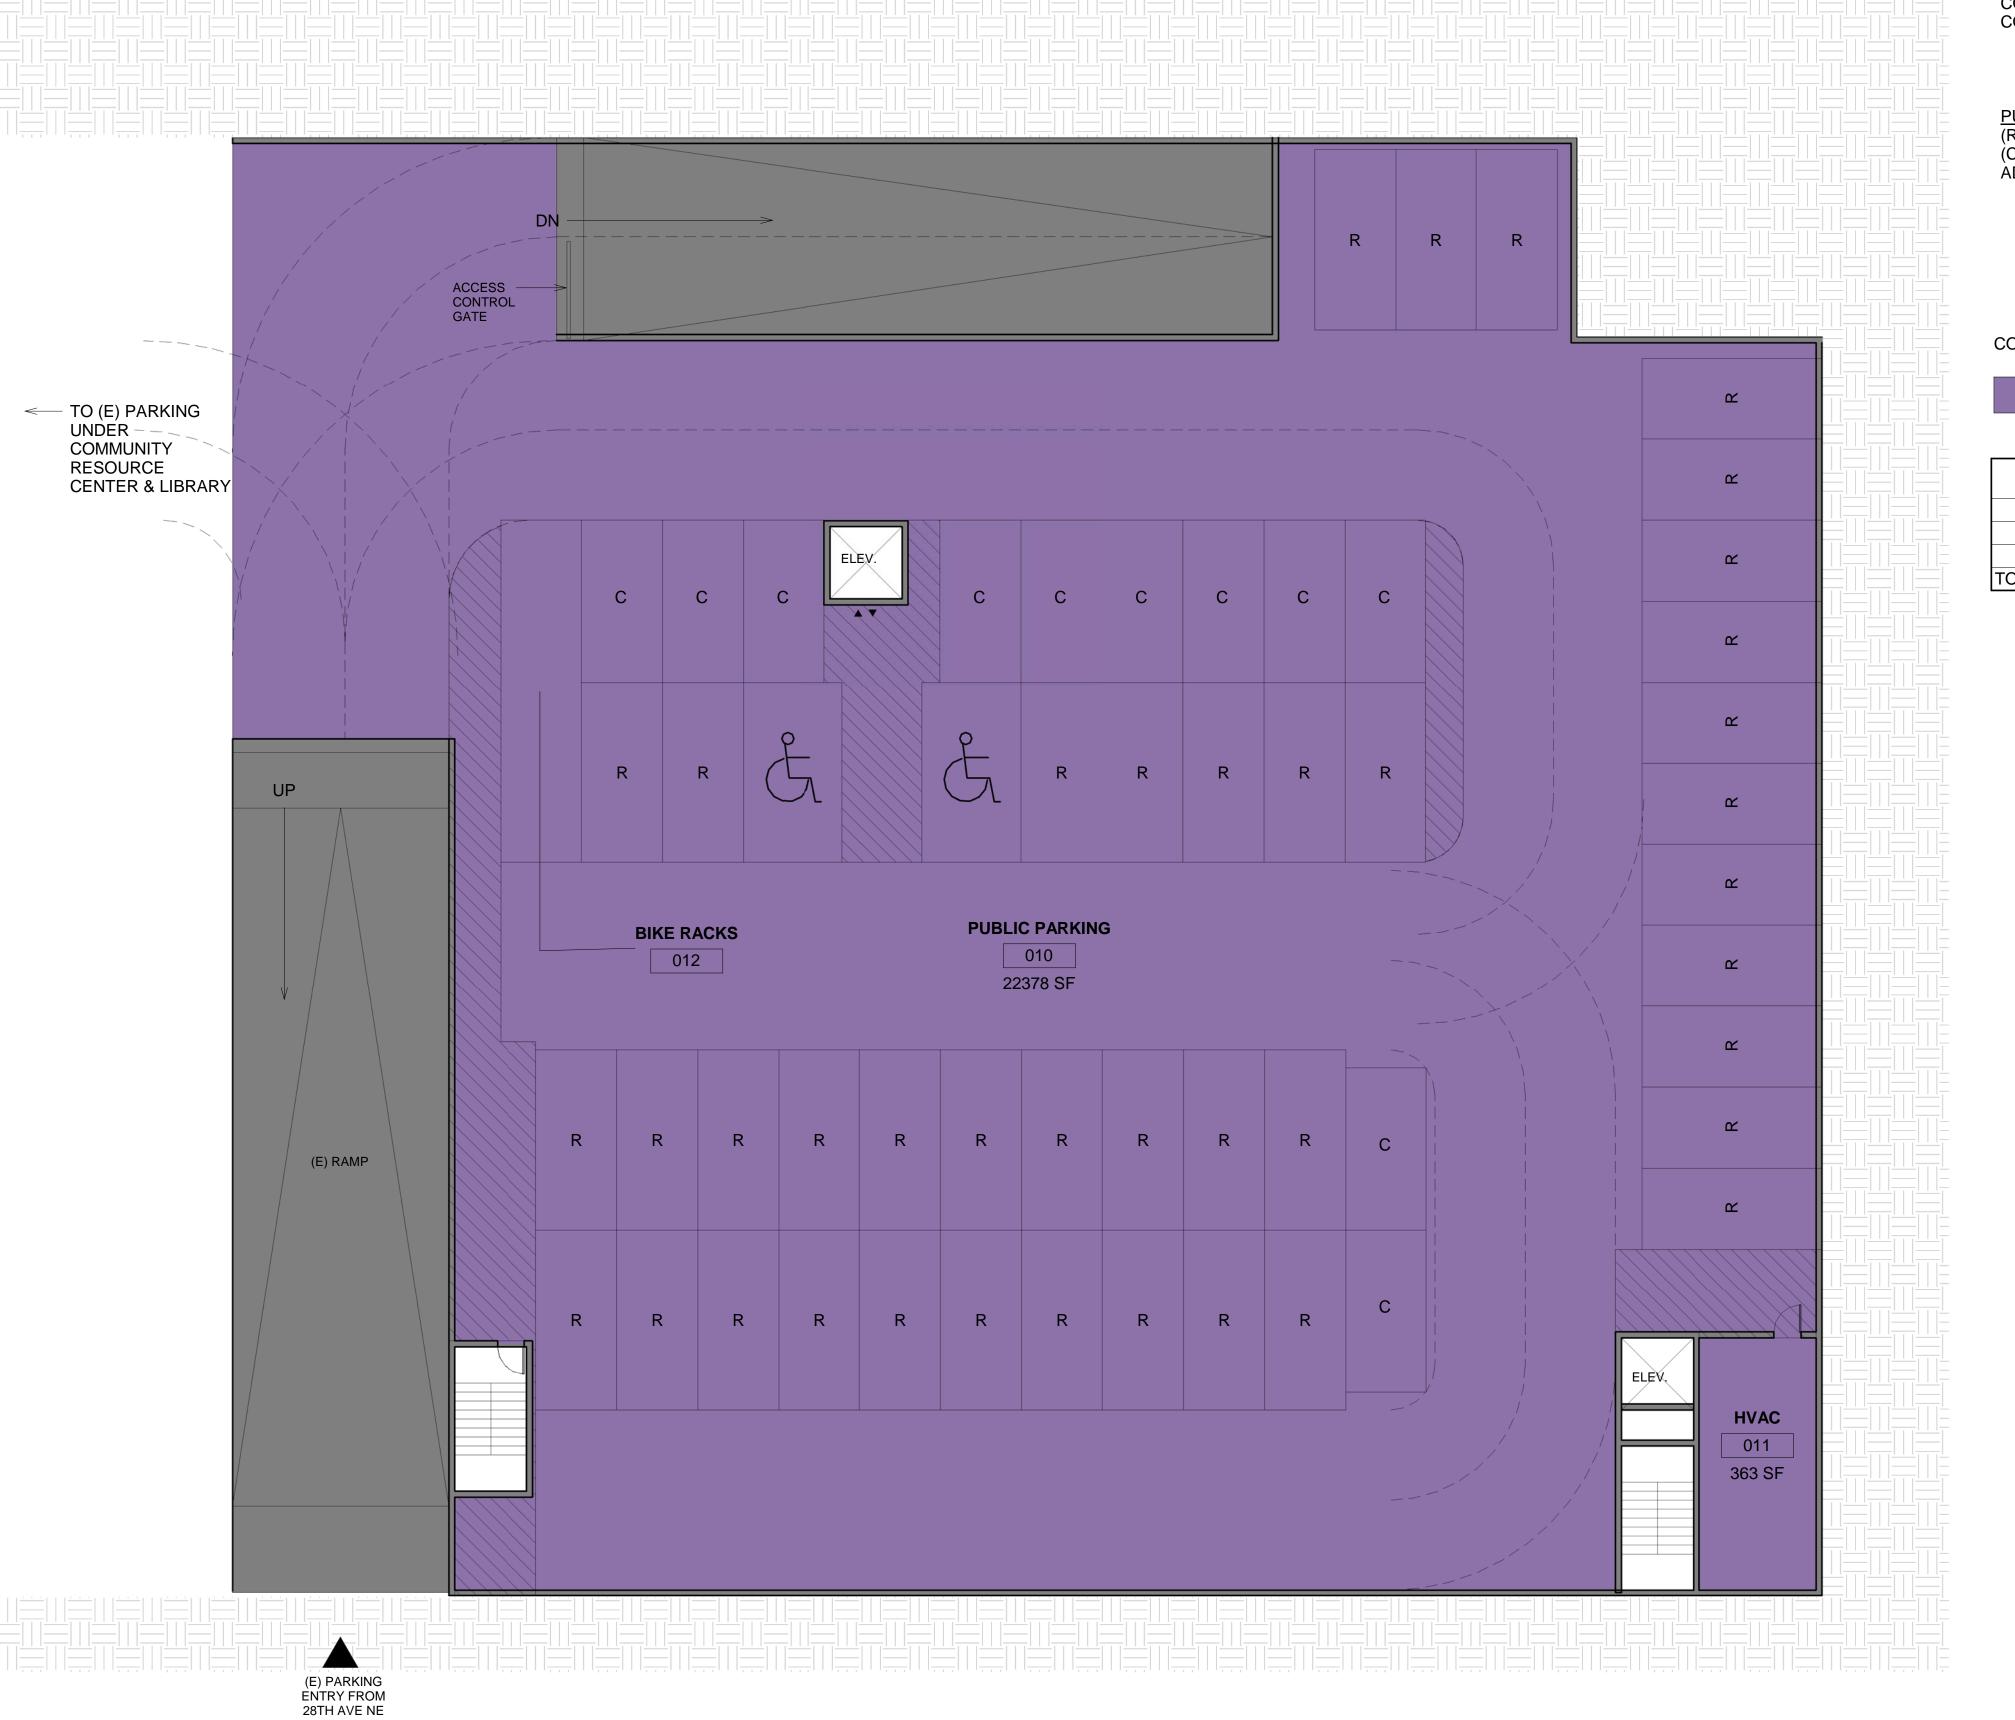
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A1 14



1 GARAGE FLOOR PARKING -1 3/32" = 1'-0"

PARKING REQUIREMENTS: COMMUNITY CENTER PARKING STALLS - 48; COMMUNITY CENTER BIKE RACKS - 26

PUBLIC PARKING STALLS: 54
(R) REGULAR 20'x9' = 41
(C) COMPACT 18'x9' = 11
ADA STALL 20'x11' = 2

COLOR SCHEME

Public Garage

GARAGE FLOOR - PARKING -1					
010	PUBLIC PARKING	22378 SF			
011	HVAC	363 SF			
012	BIKE RACKS	342 SF			
TOTAL PUB	LIC GARAGE AREA	23082 SF			

GARAGE LEVEL 1 GROSS AREA 25349 SF



950 Pacific Avenue, Suite 450 Tacoma, WA 98402 253-572-4903

Project Title:

CITY LAKE COMMUNITY CENTER & HOUSING

12531 28th Avenue NE, Seattle, WA 98125

Client:

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Job Number:

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GARAGE FLOOR

PARKING -1

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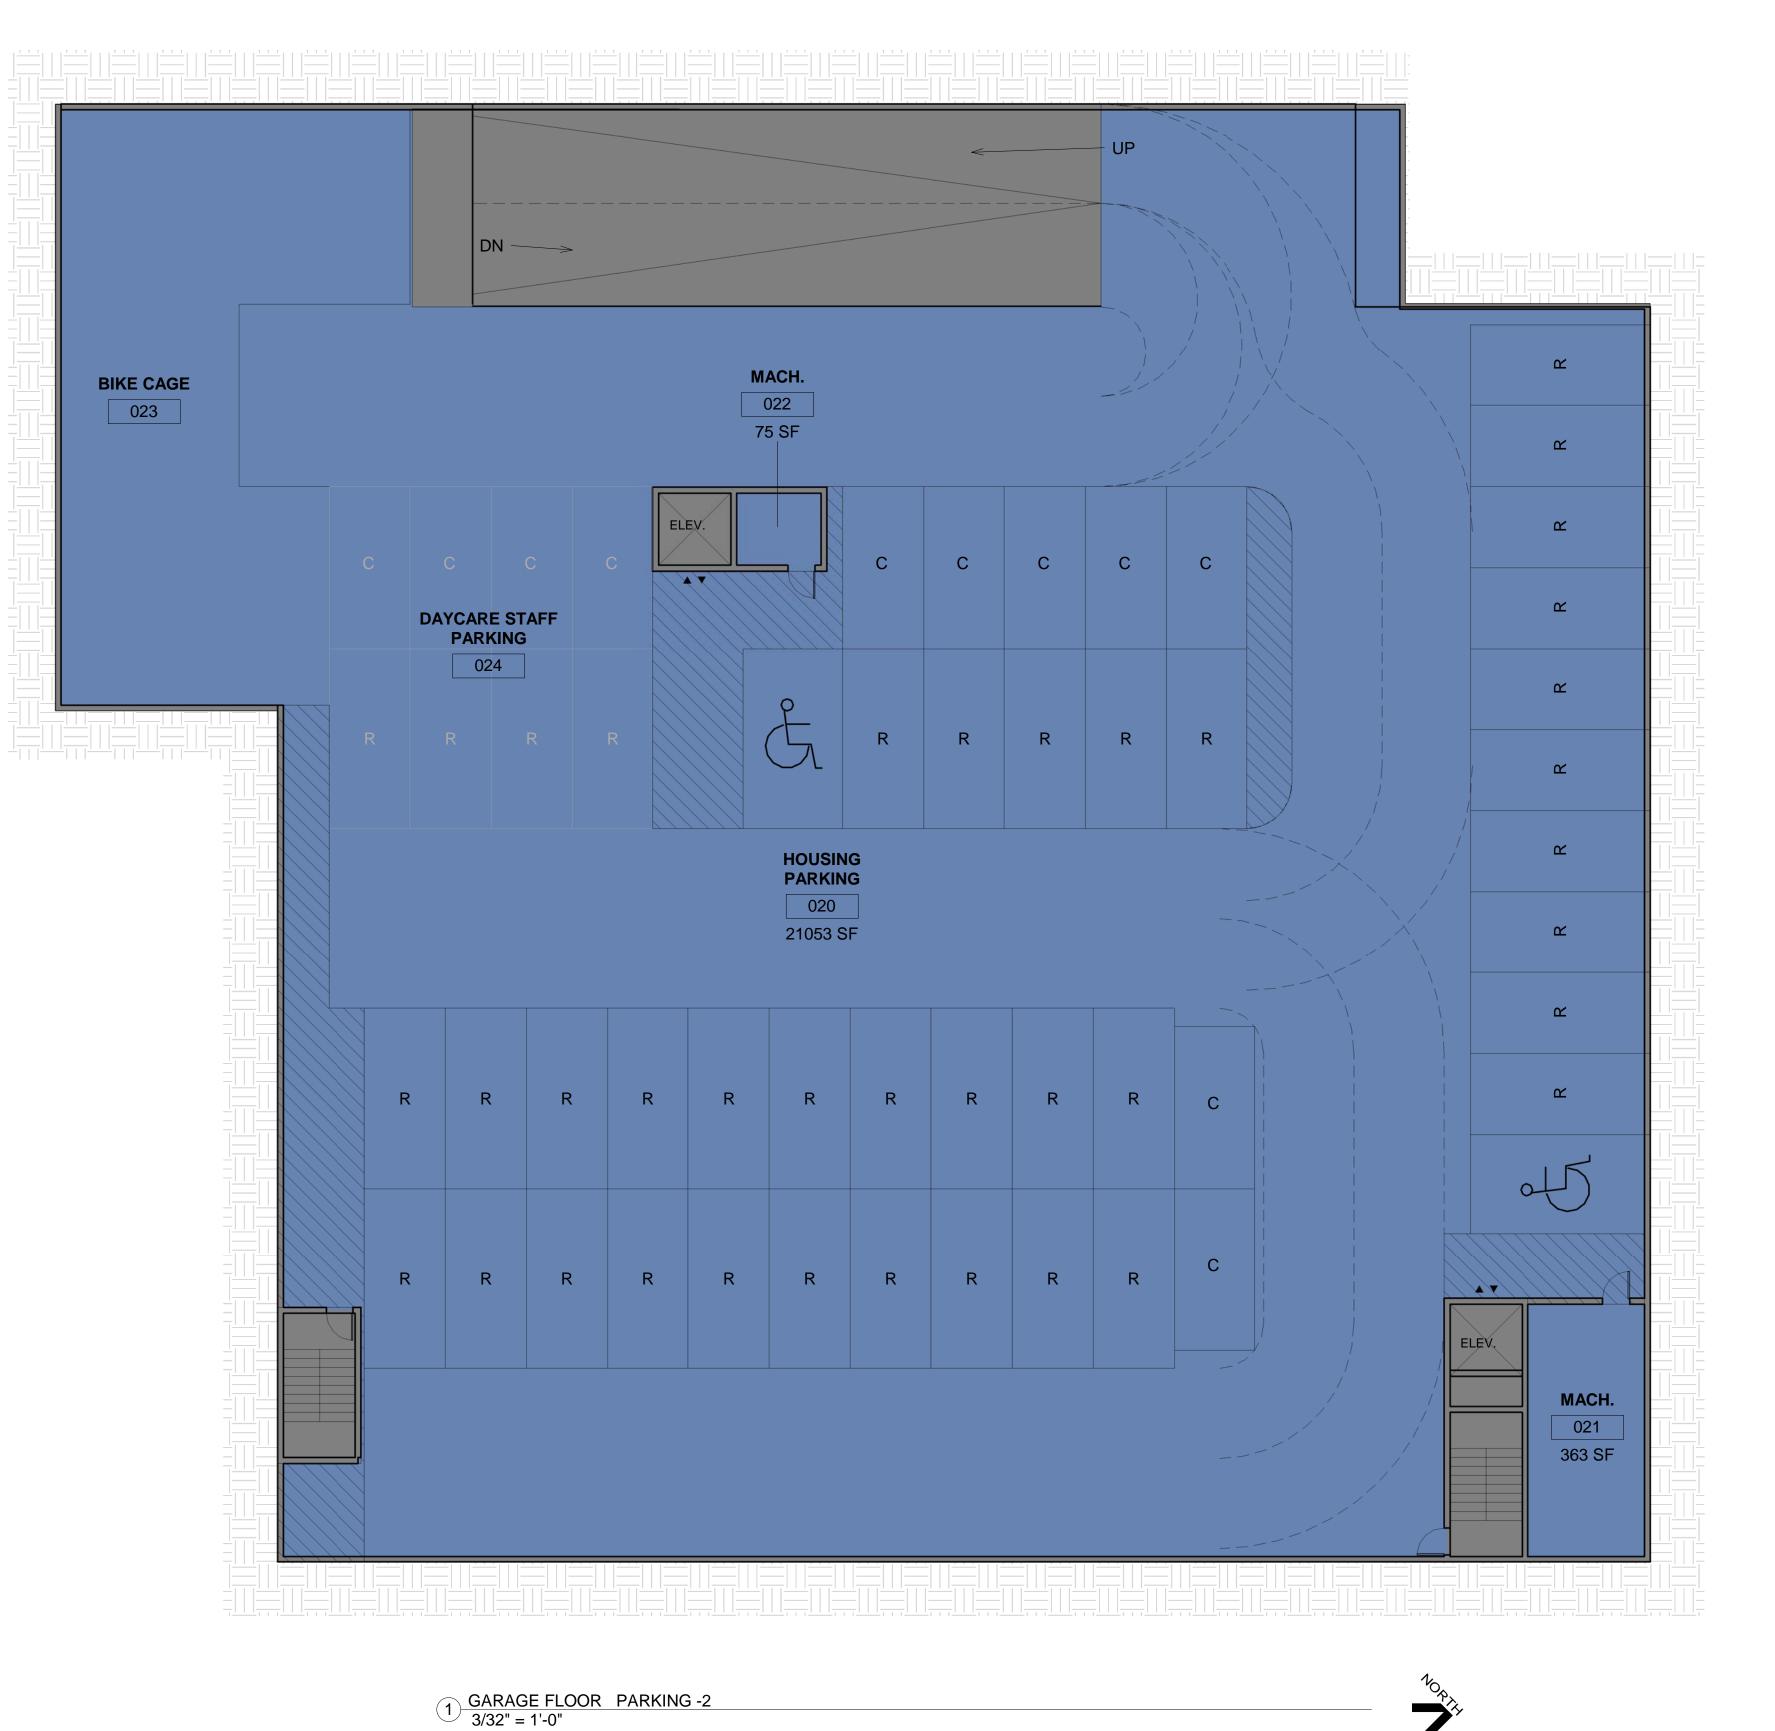
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Sheet Number:

A1 21

SHEET SIZE TRUE SCALE WHEN HORIZONTAL LINE MEASURES 1" IN LENGTH

3/32" = 1'-0"



PARKING REQUIREMENTS: HOUSING PARKING STALLS - 40 MAX; DAYCARE STAFF PARKING STALLS - 8; HOUSING BIKE RACKS - 100; DAYCARE STAFF BIKE RACK - 1.

HOUSING PARKING STALLS: 44
(R) REGULAR 20'x9' = 35
(C) COMPACT 18'x9' = 7 ADA STALL 20'x11' = 2

DAYCARE STAFF PARKING STALLS: 8 (R) REGULAR 20'x9' = 4 (C) COMPACT 18'x9' = 4

COLOR SCHEME

Housing Garage

	GARAGE FLOOR - PARKING -	-2
020	HOUSING PARKING	21053 SF
021	MACH.	363 SF
022	MACH.	75 SF
023	BIKE CAGE	1959 SF
024	DAYCARE STAFF PARKING	1368 SF
TOTAL HOL	JSING GARAGE AREA	24817 SF

GARAGE LEVEL 2 GROSS AREA 25349 SF



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SHEET SIZE TRUE SCALE WHEN HORIZONTAL LINE MEASURES 1" IN LENGTH

3/32" = 1'-0"





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ROOF PLAN

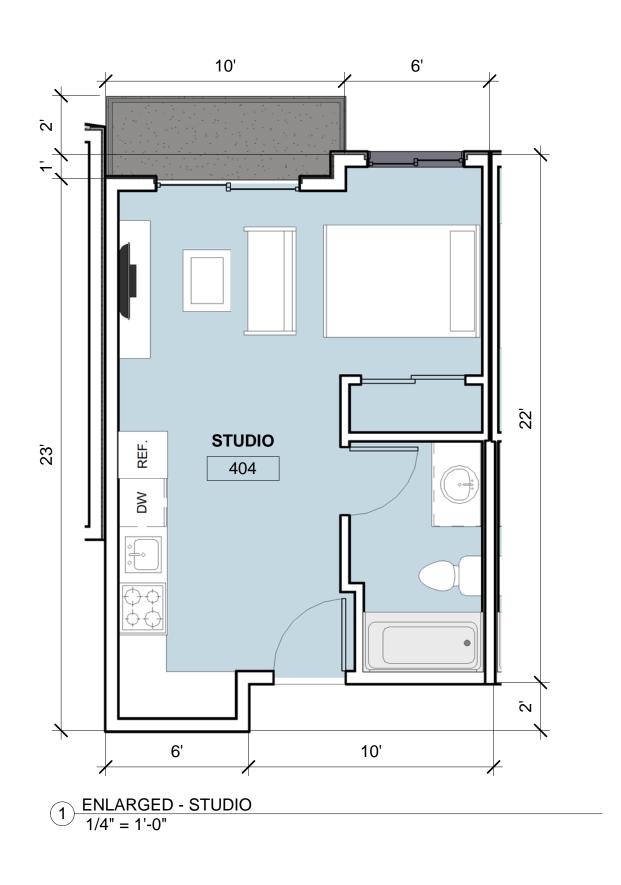
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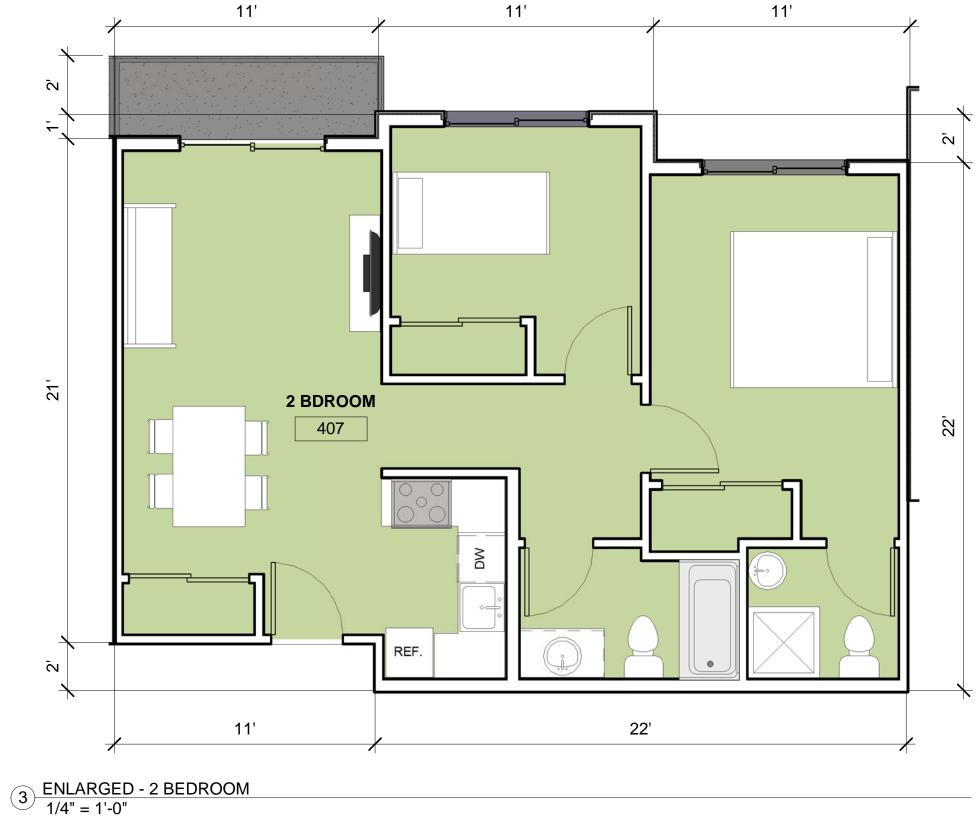
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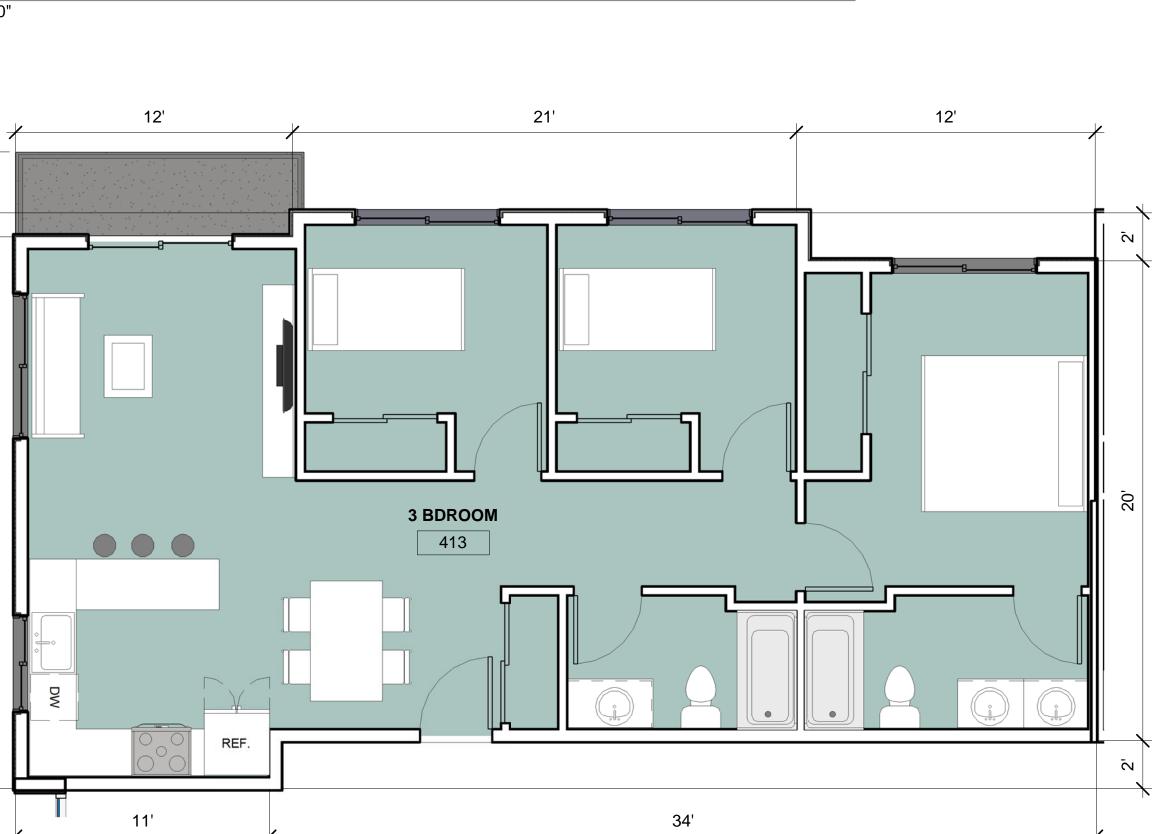
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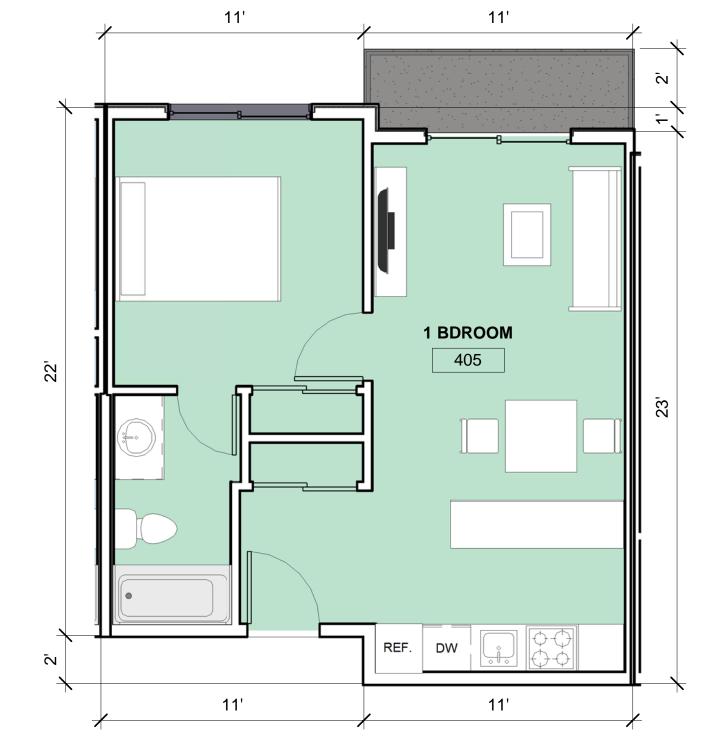
Sheet Number:

A1.3′









2 ENLARGED - 1 BEDROOM 1/4" = 1'-0"

4 ENLARGED - 3 BEDROOM 1/4" = 1'-0"

3' 2' 1' 0 2' 4' 8' 1/4" = 1'-0" architects

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Project Title:

STUDIO = 25 UNITS (25%) 1 BEDROOM = 50 UNITS (50%) 2 BEDROOM = 15 UNITS (15%) 3 BEDROOM = 10 UNITS (10%)

TOTAL:

100 UNITS (100%)

CITY LAKE COMMUNITY CENTER & HOUSING

12531 28th Avenue NE, Seattle, WA 98125

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Sheet Title:

ENLARGED UNIT PLANS

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Sheet Number:

A2 1



1 EAST ELEVATION 1/8" = 1'-0"



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Sheet Title:

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EAST ELEVATION

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A3.11



1 SOUTH ELEVATION 1/8" = 1'-0"

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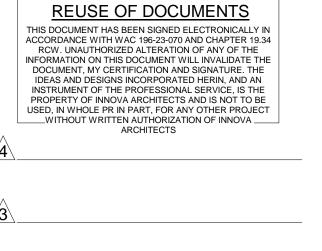
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Sheet Title:
SOUTH ELEVATION

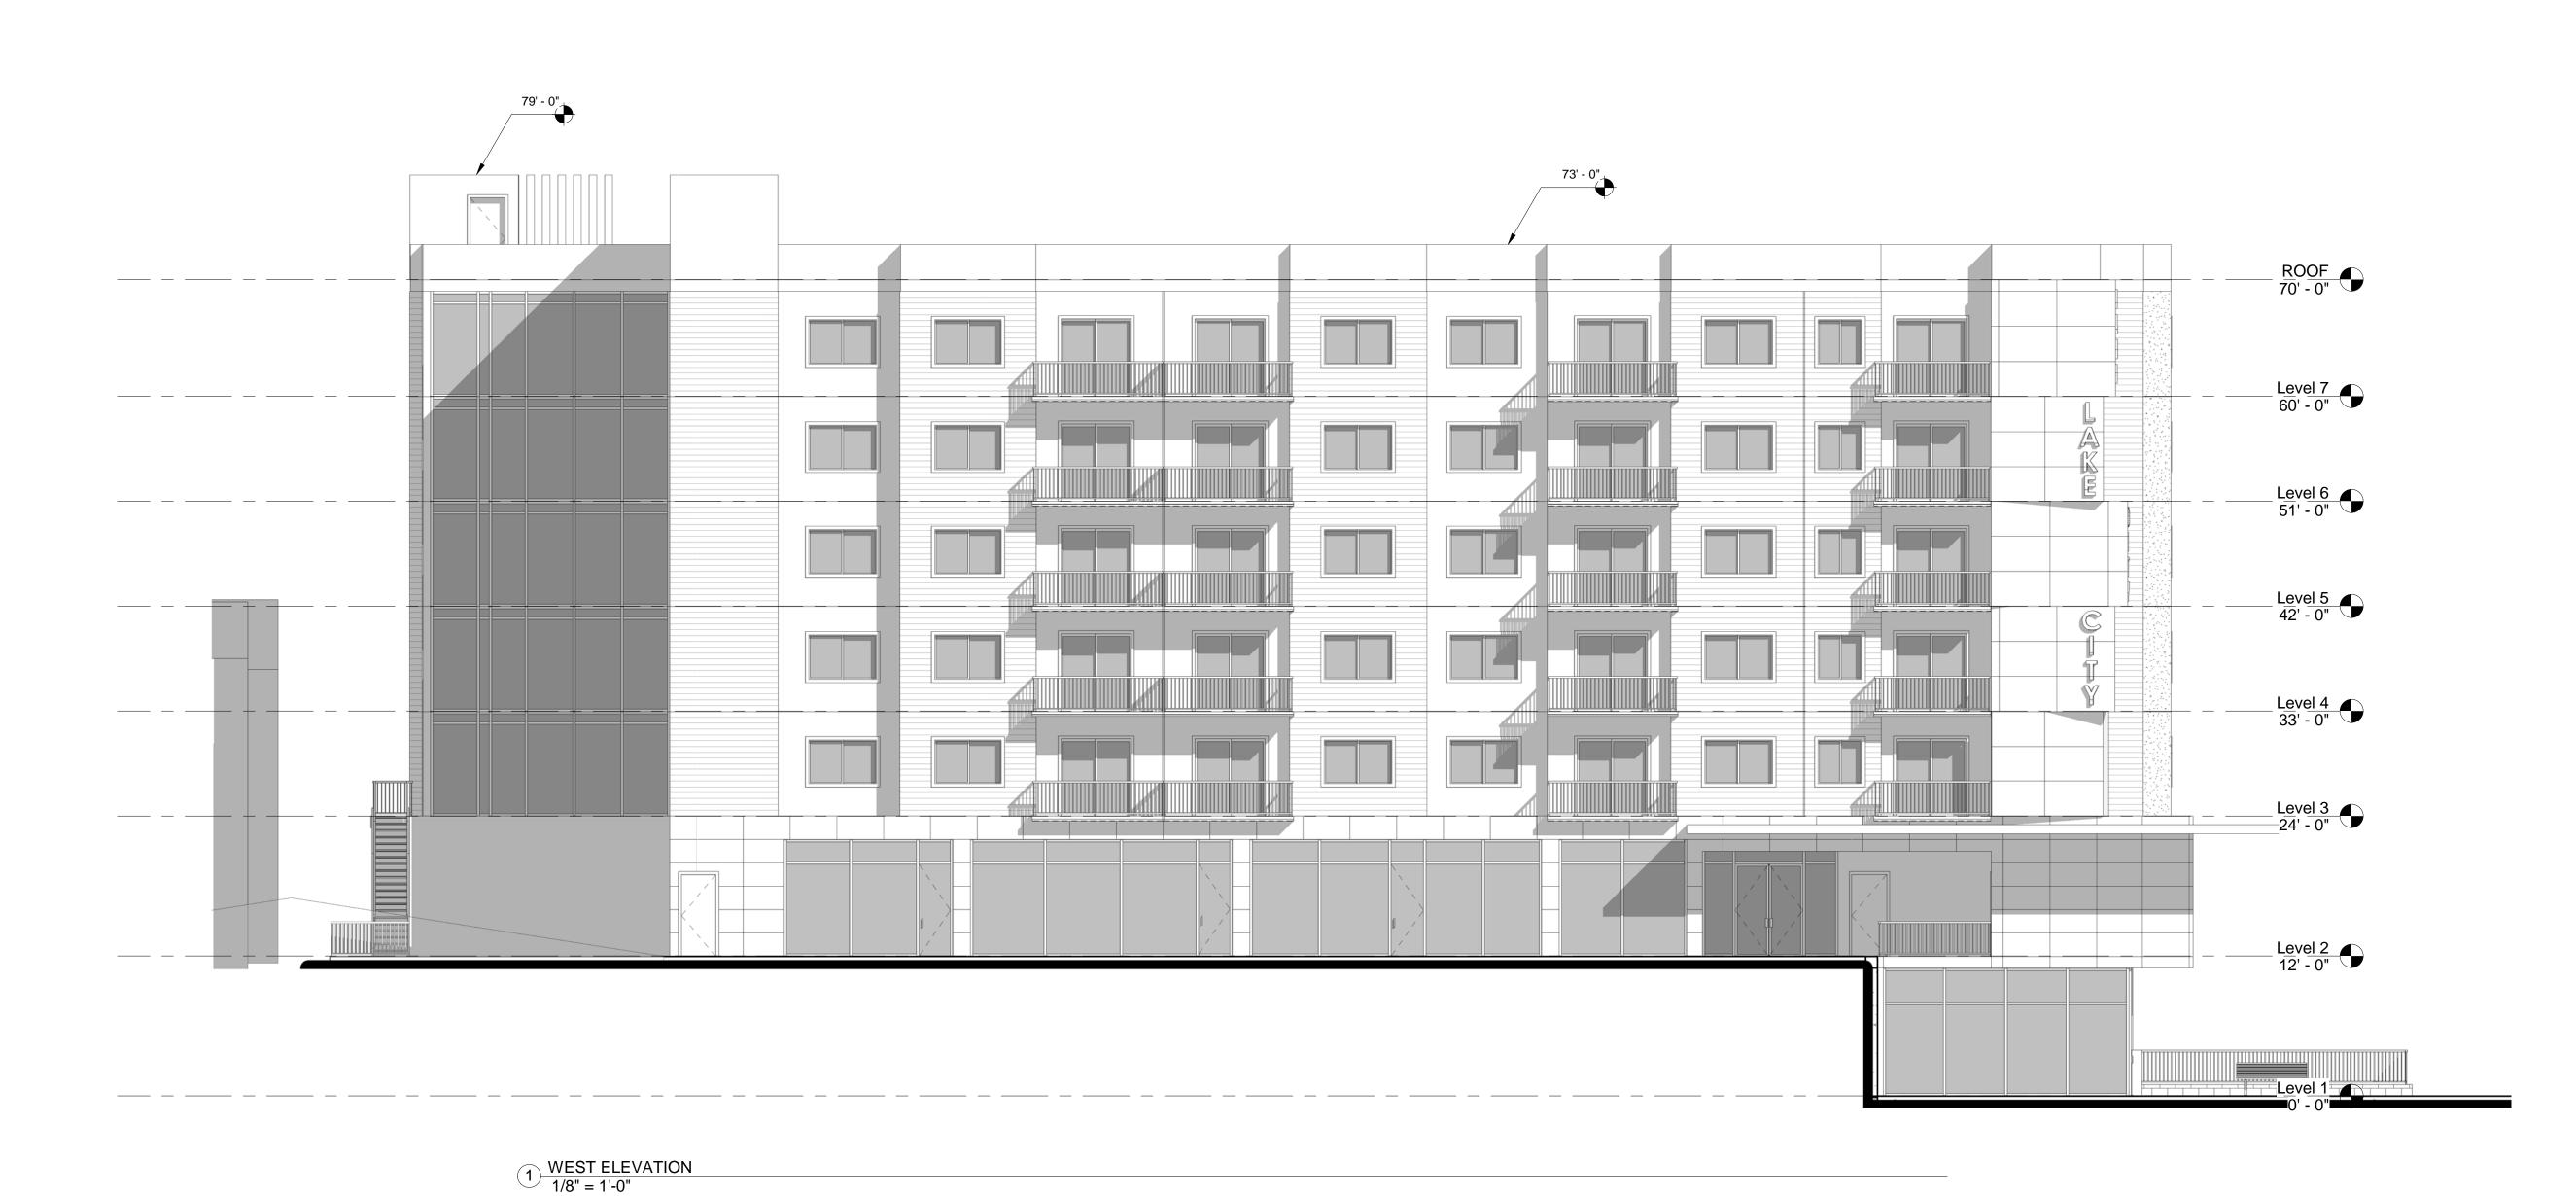
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WEST ELEVATION

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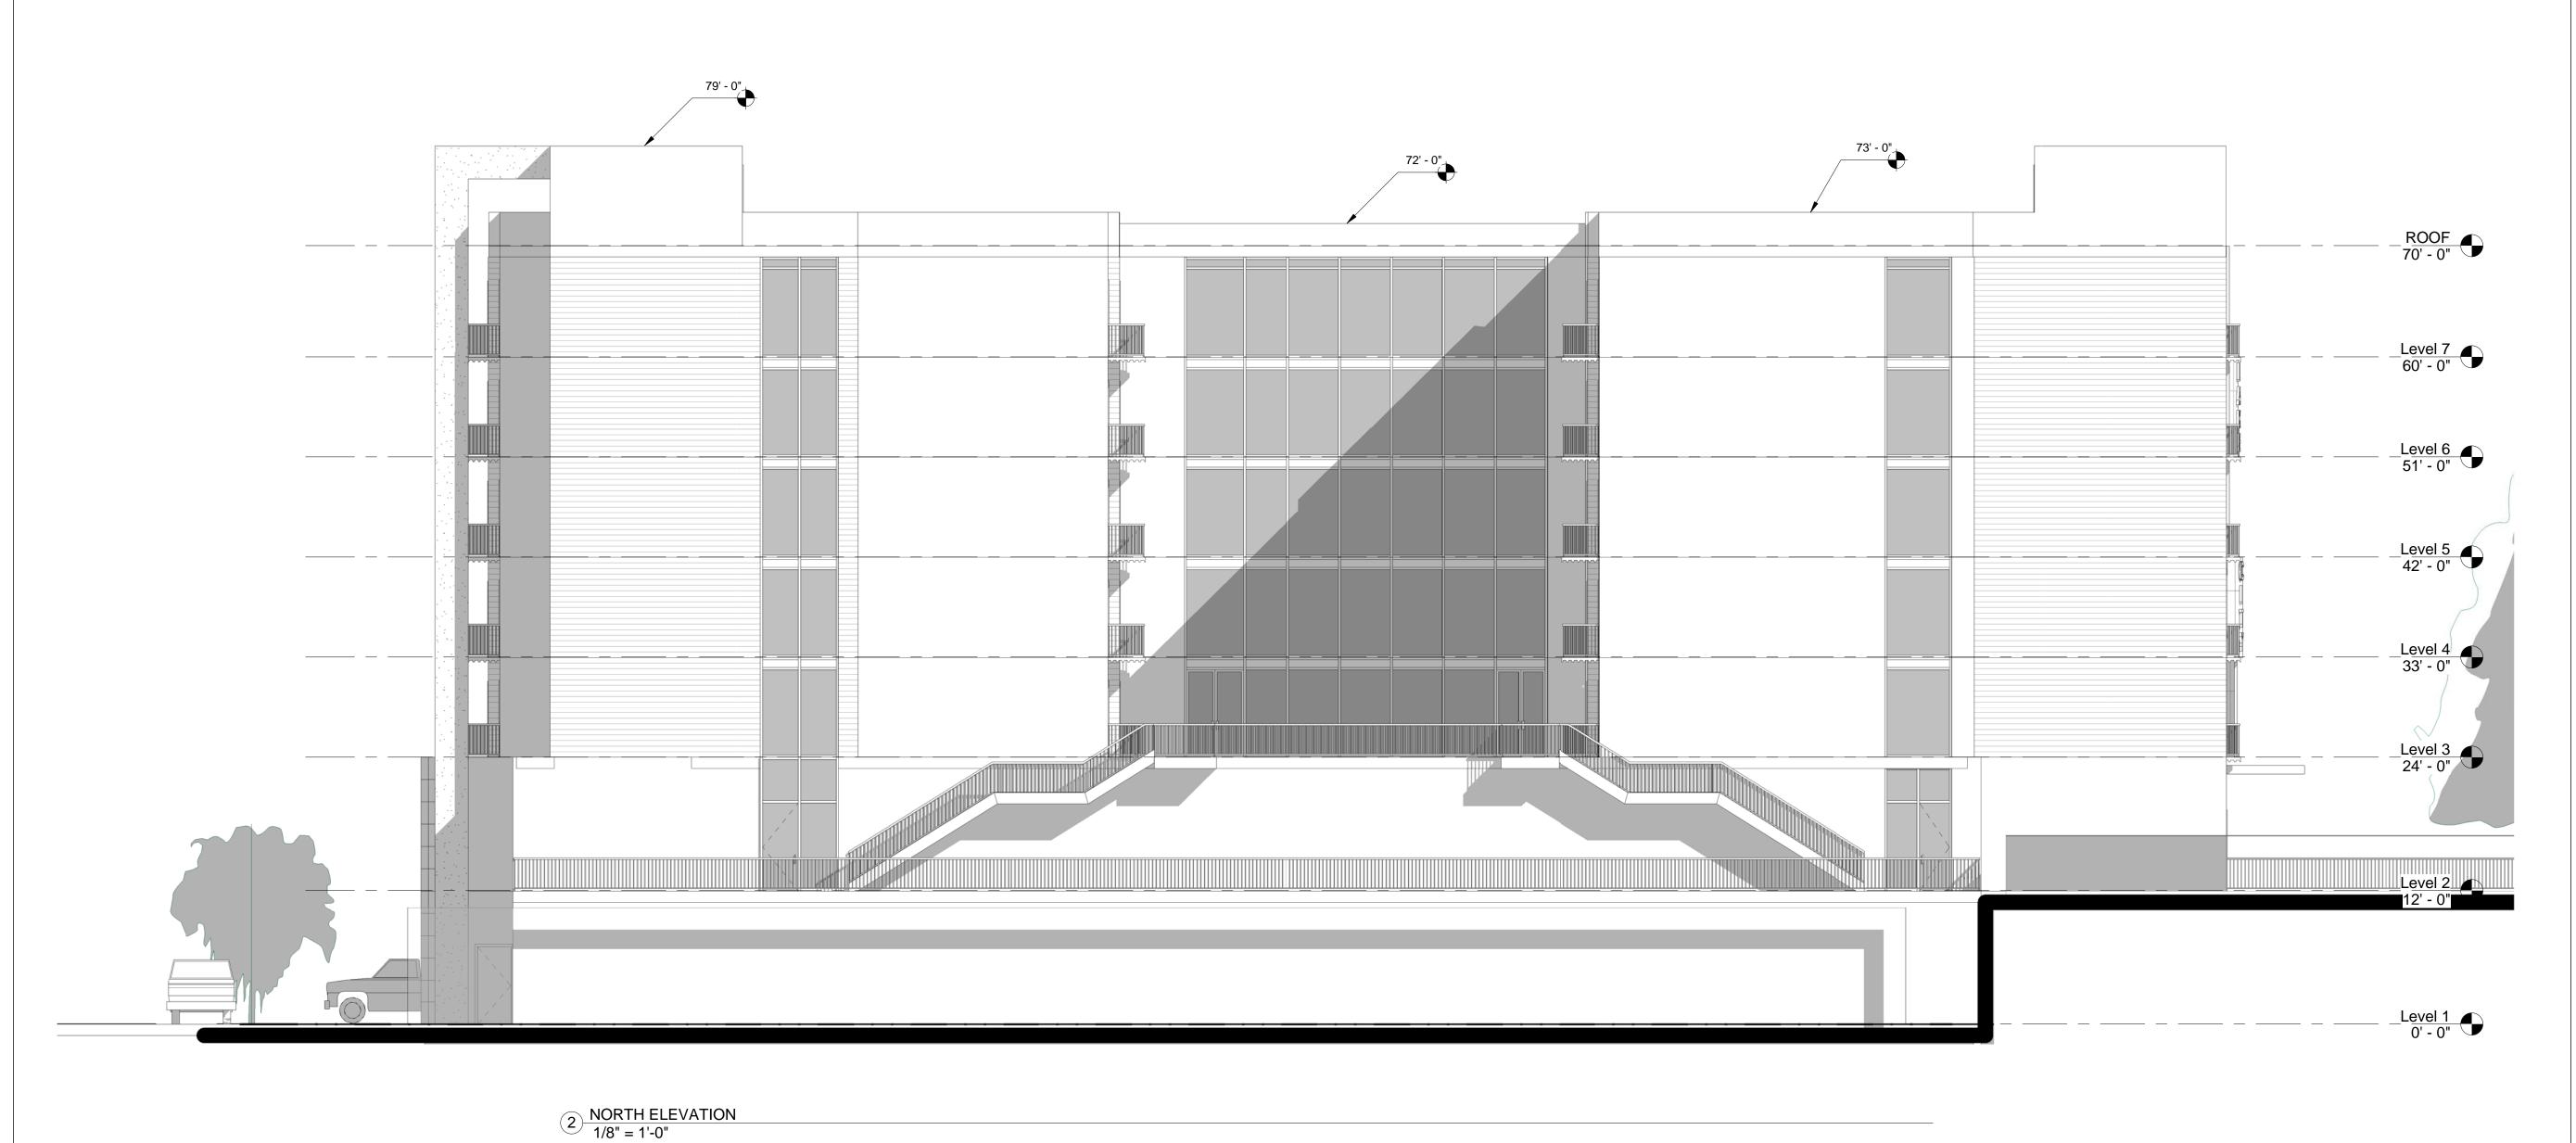
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Sheet Number:

A3.13

SHEET SIZE TRUE SCALE WHEN HORIZONTAL LINE MEASURES 1" IN LENGTH

8' 4' 0 8' 10' 1/8" = 1'-0"



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NORTH ELEVATION

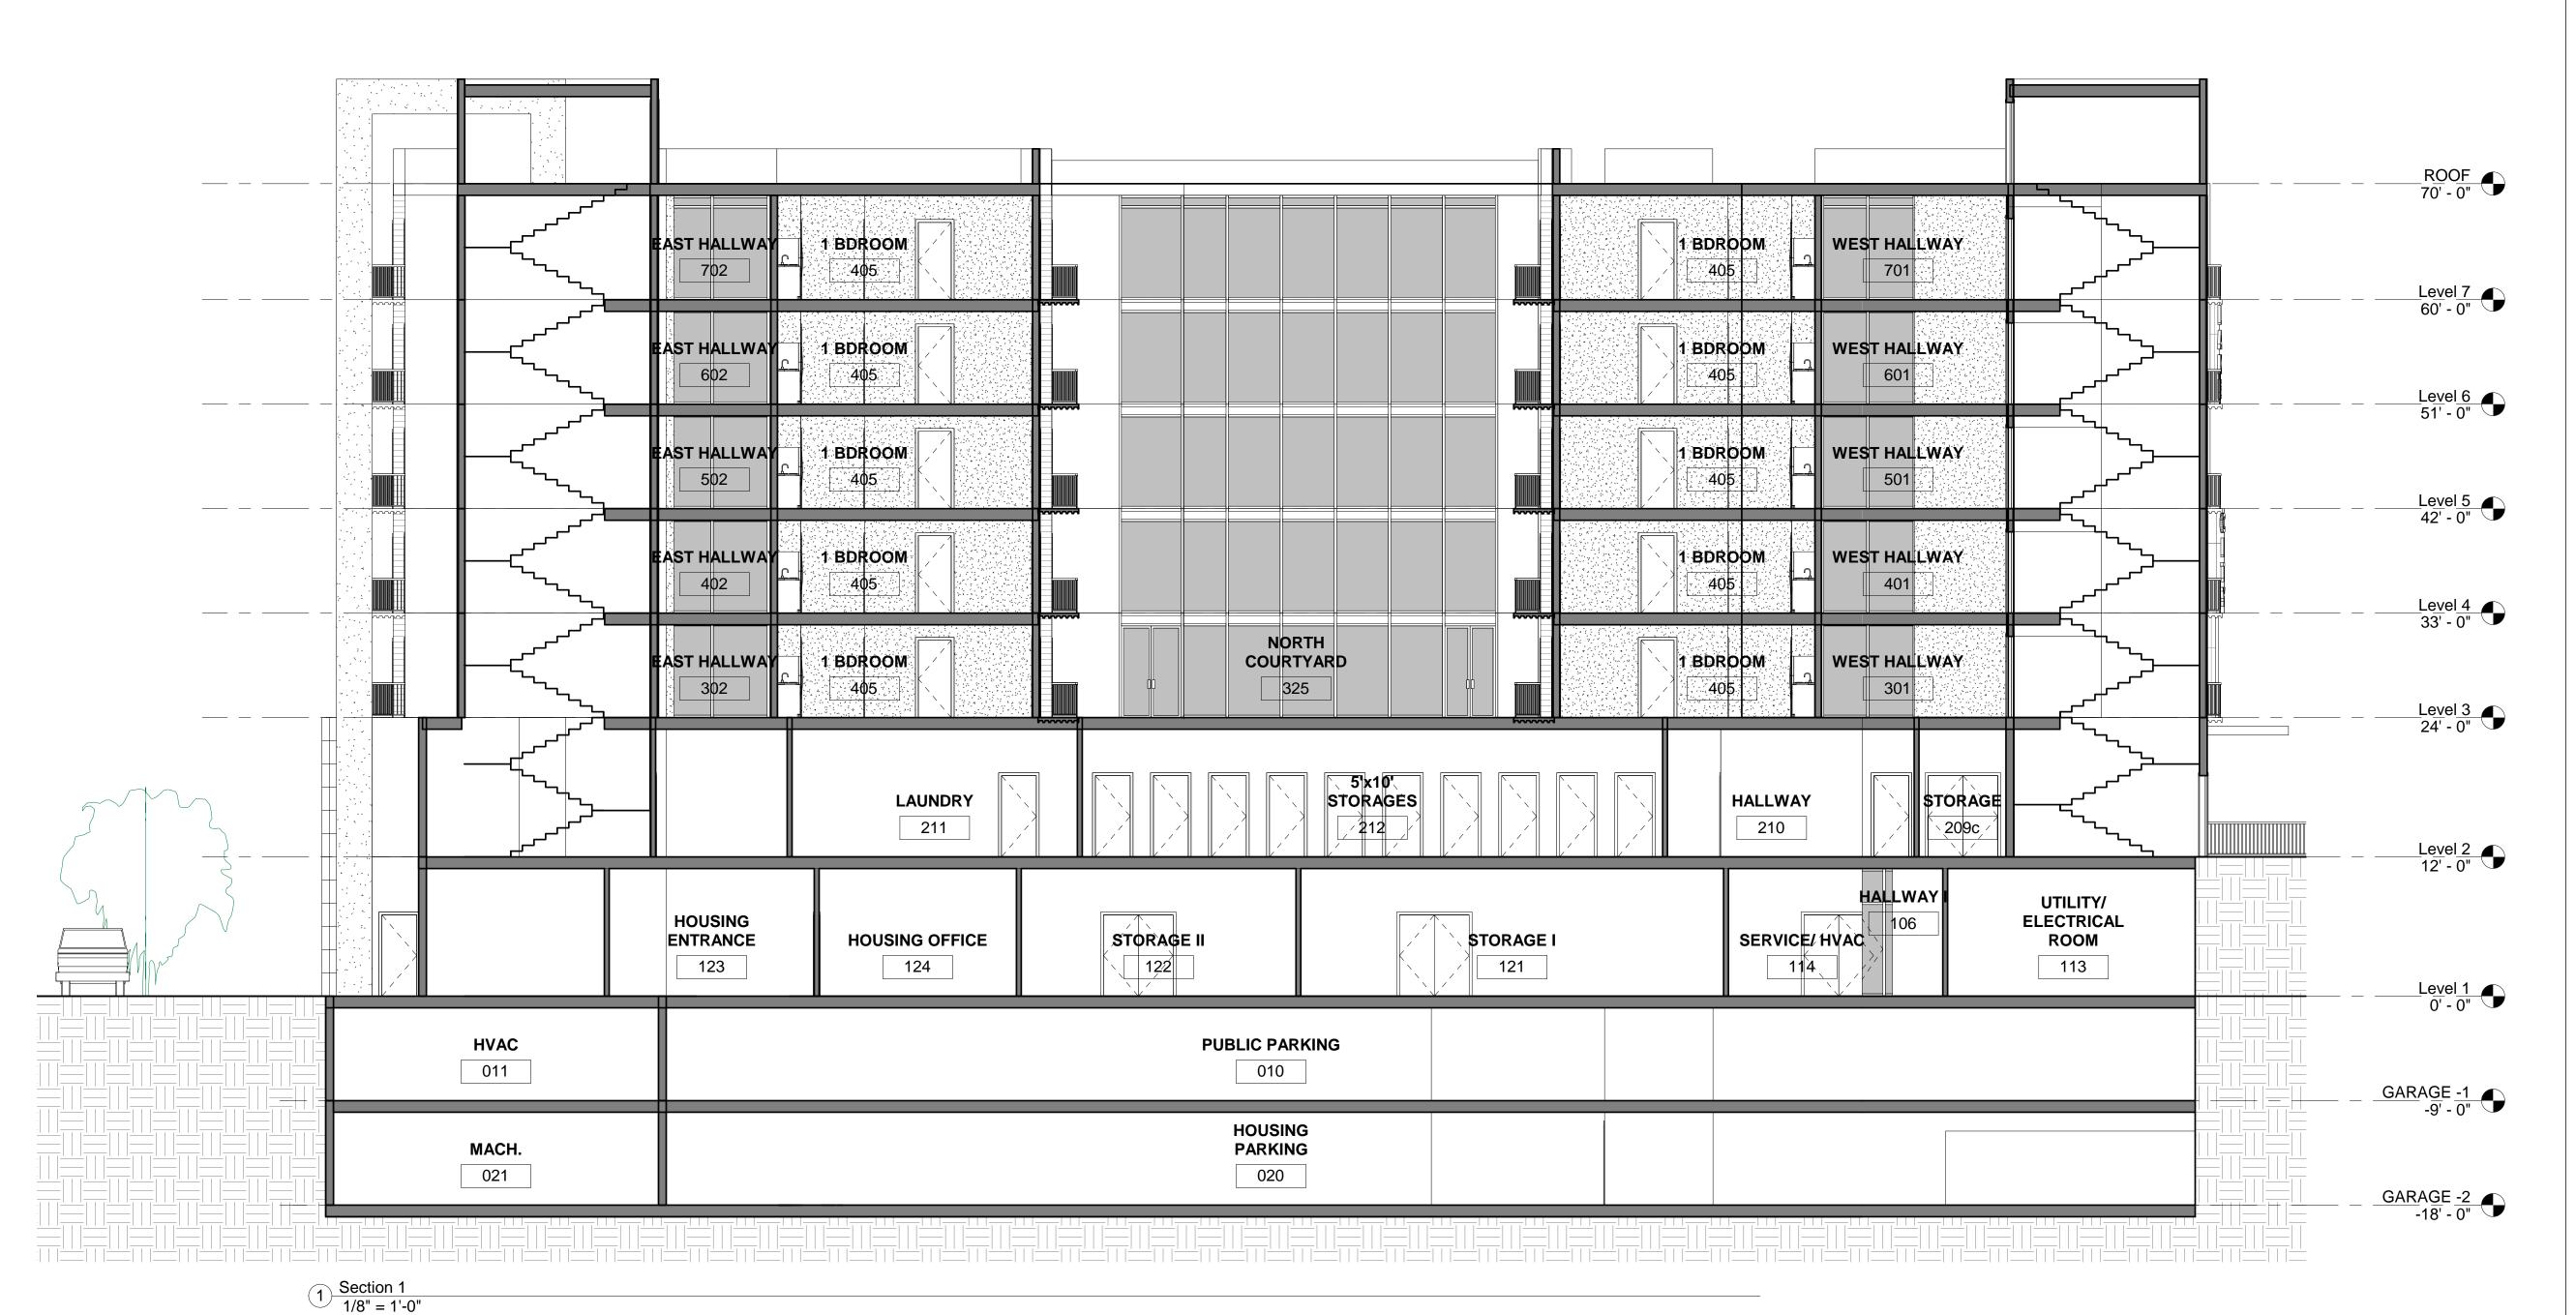
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<u>Revisions:</u>

Sheet Title:
BUILDING SECTION 1

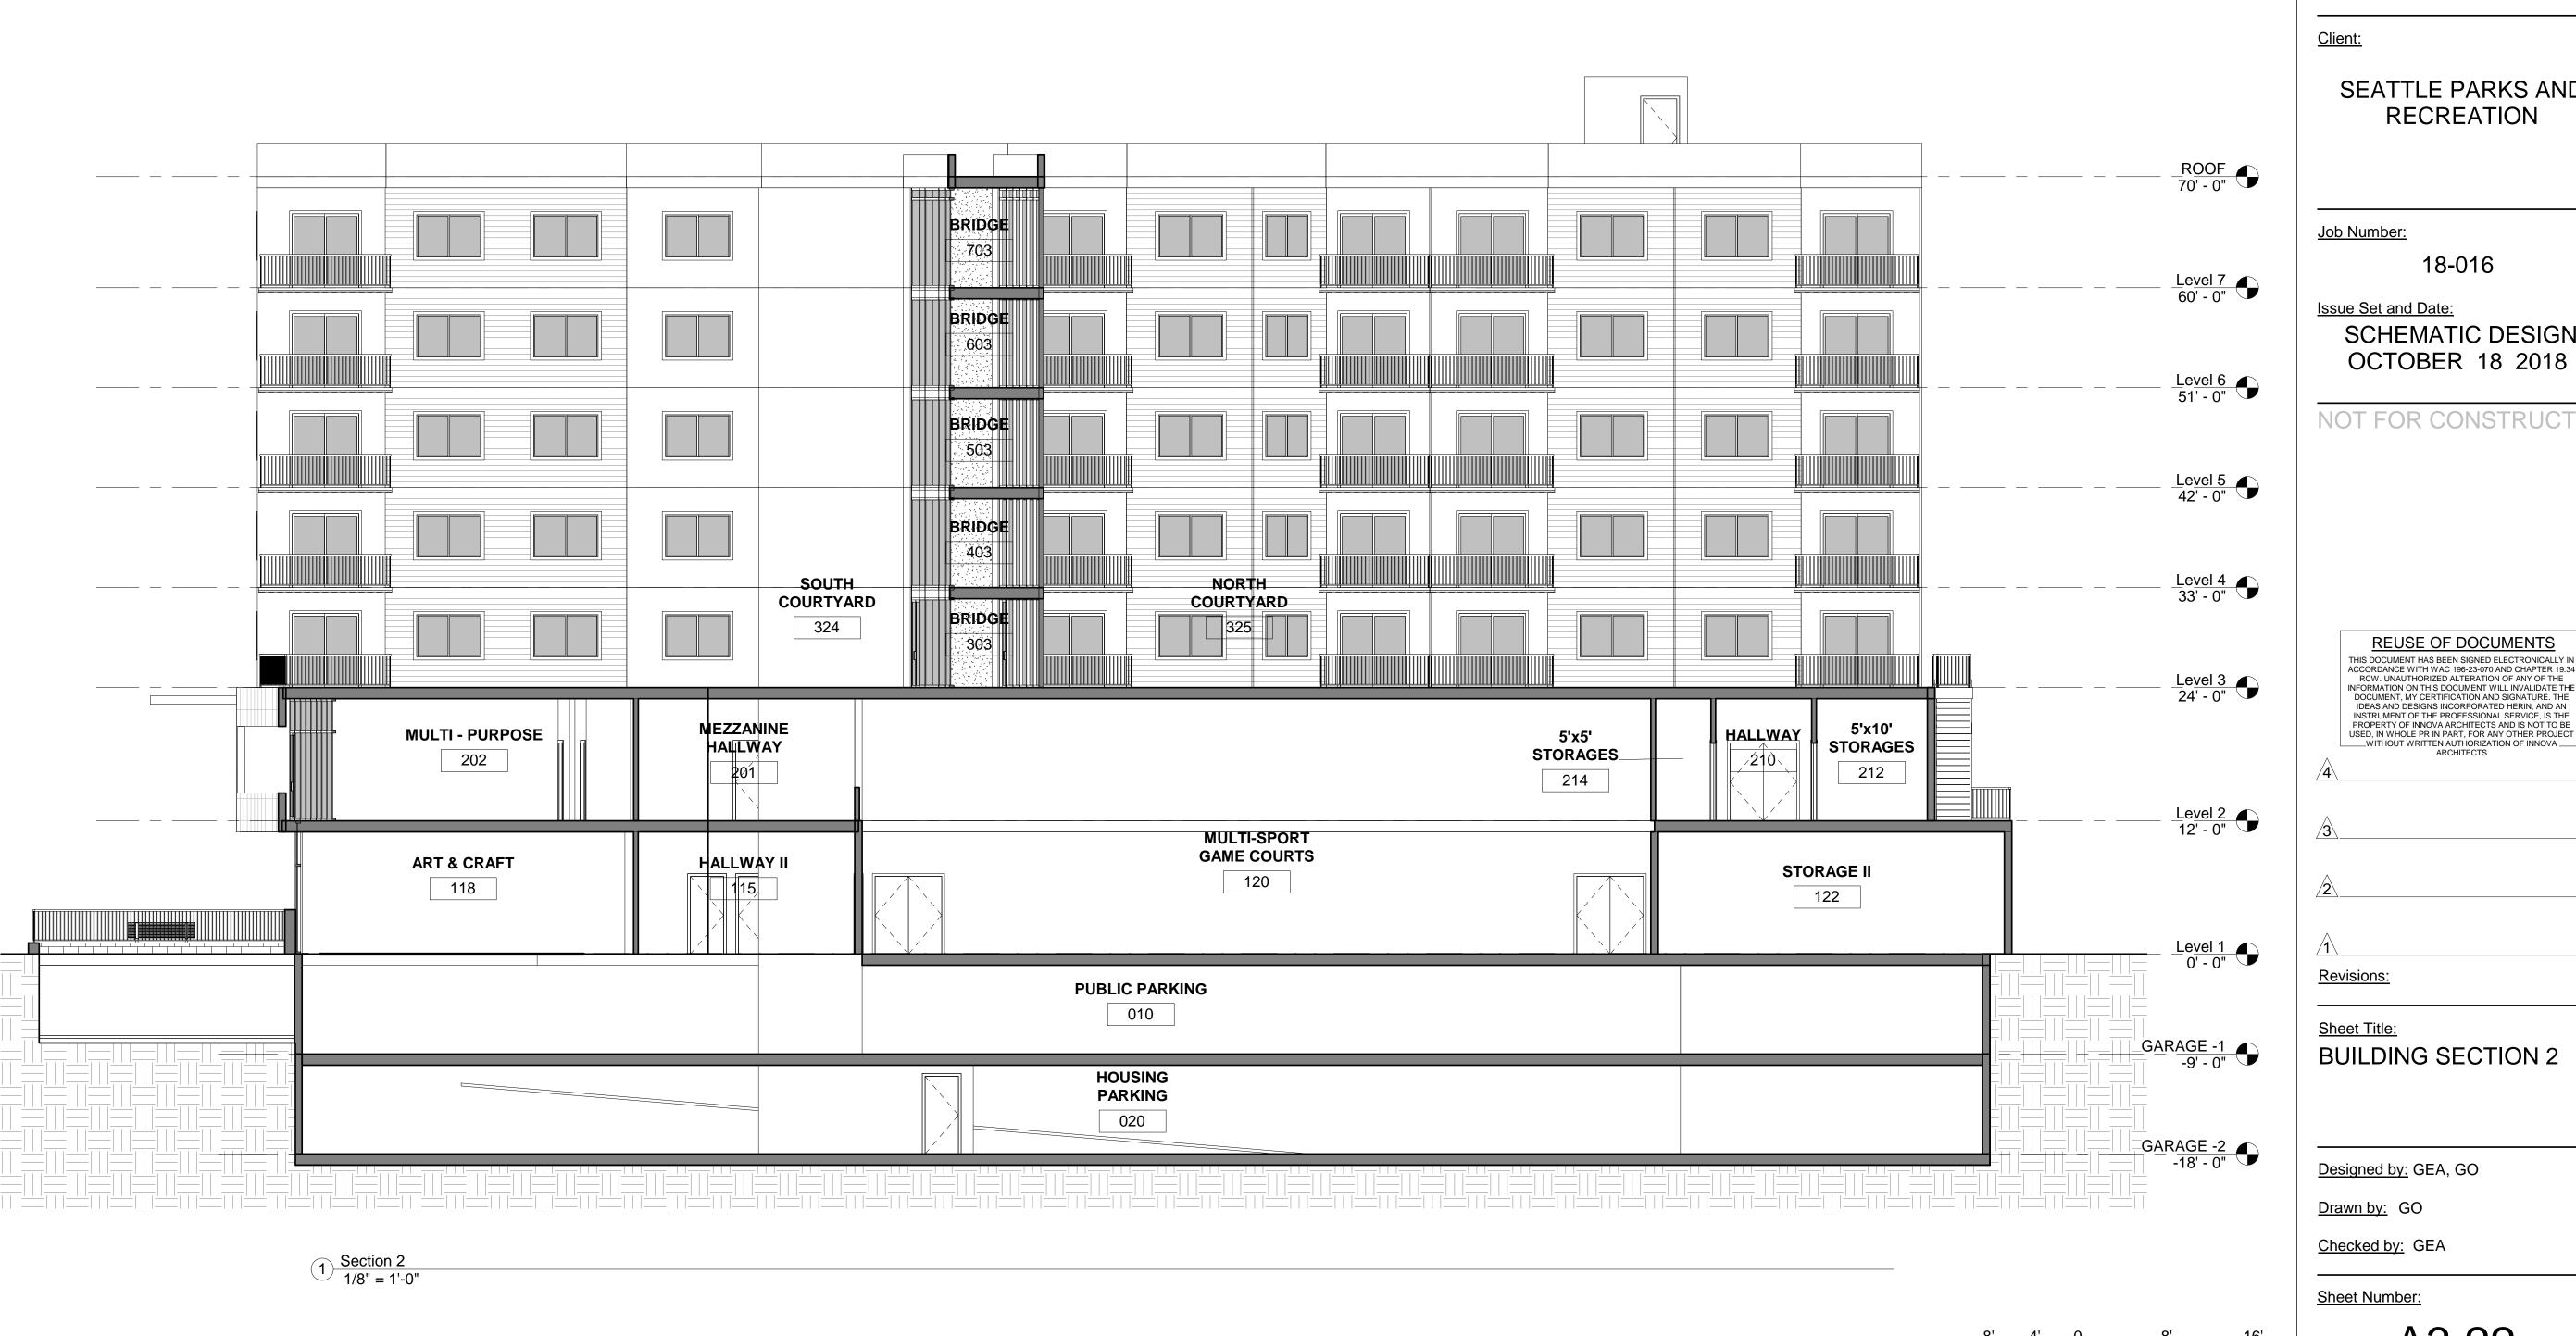
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Sheet Title: **BUILDING SECTION 2**

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2 28TH AVE PERSPECTIVE VIEW



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PERSPECTIVE VIEWS

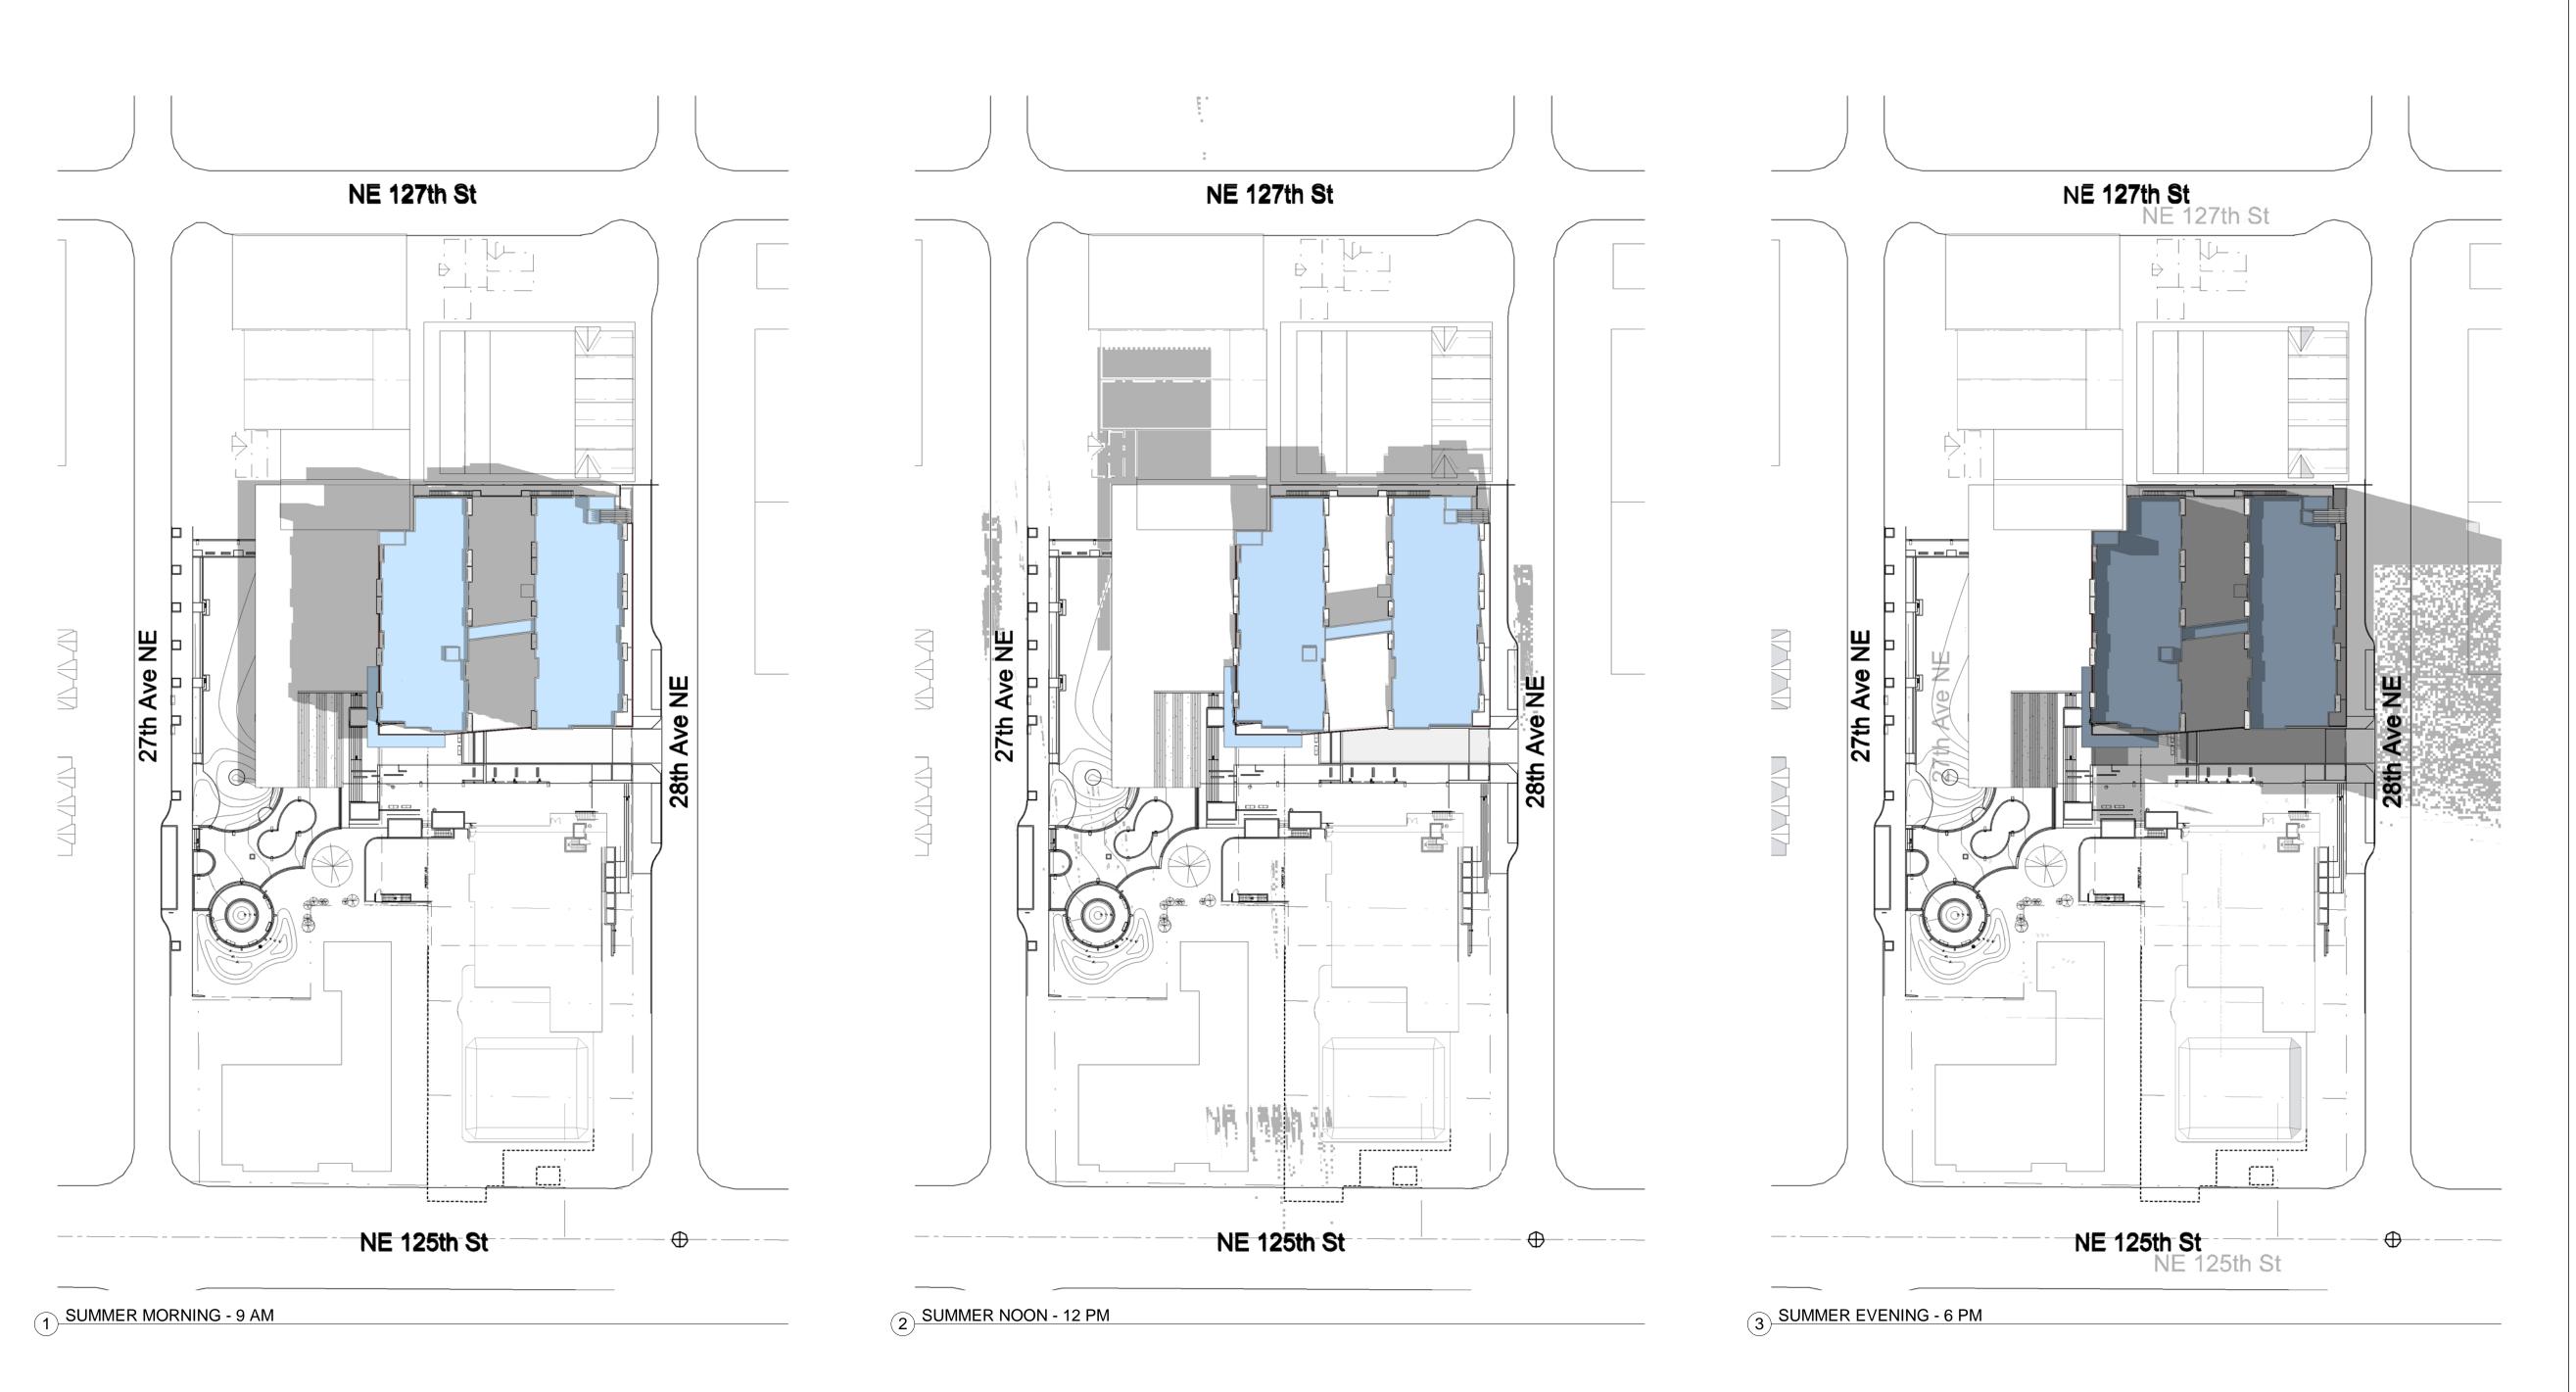
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SUN STUDY AT
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JUNE)

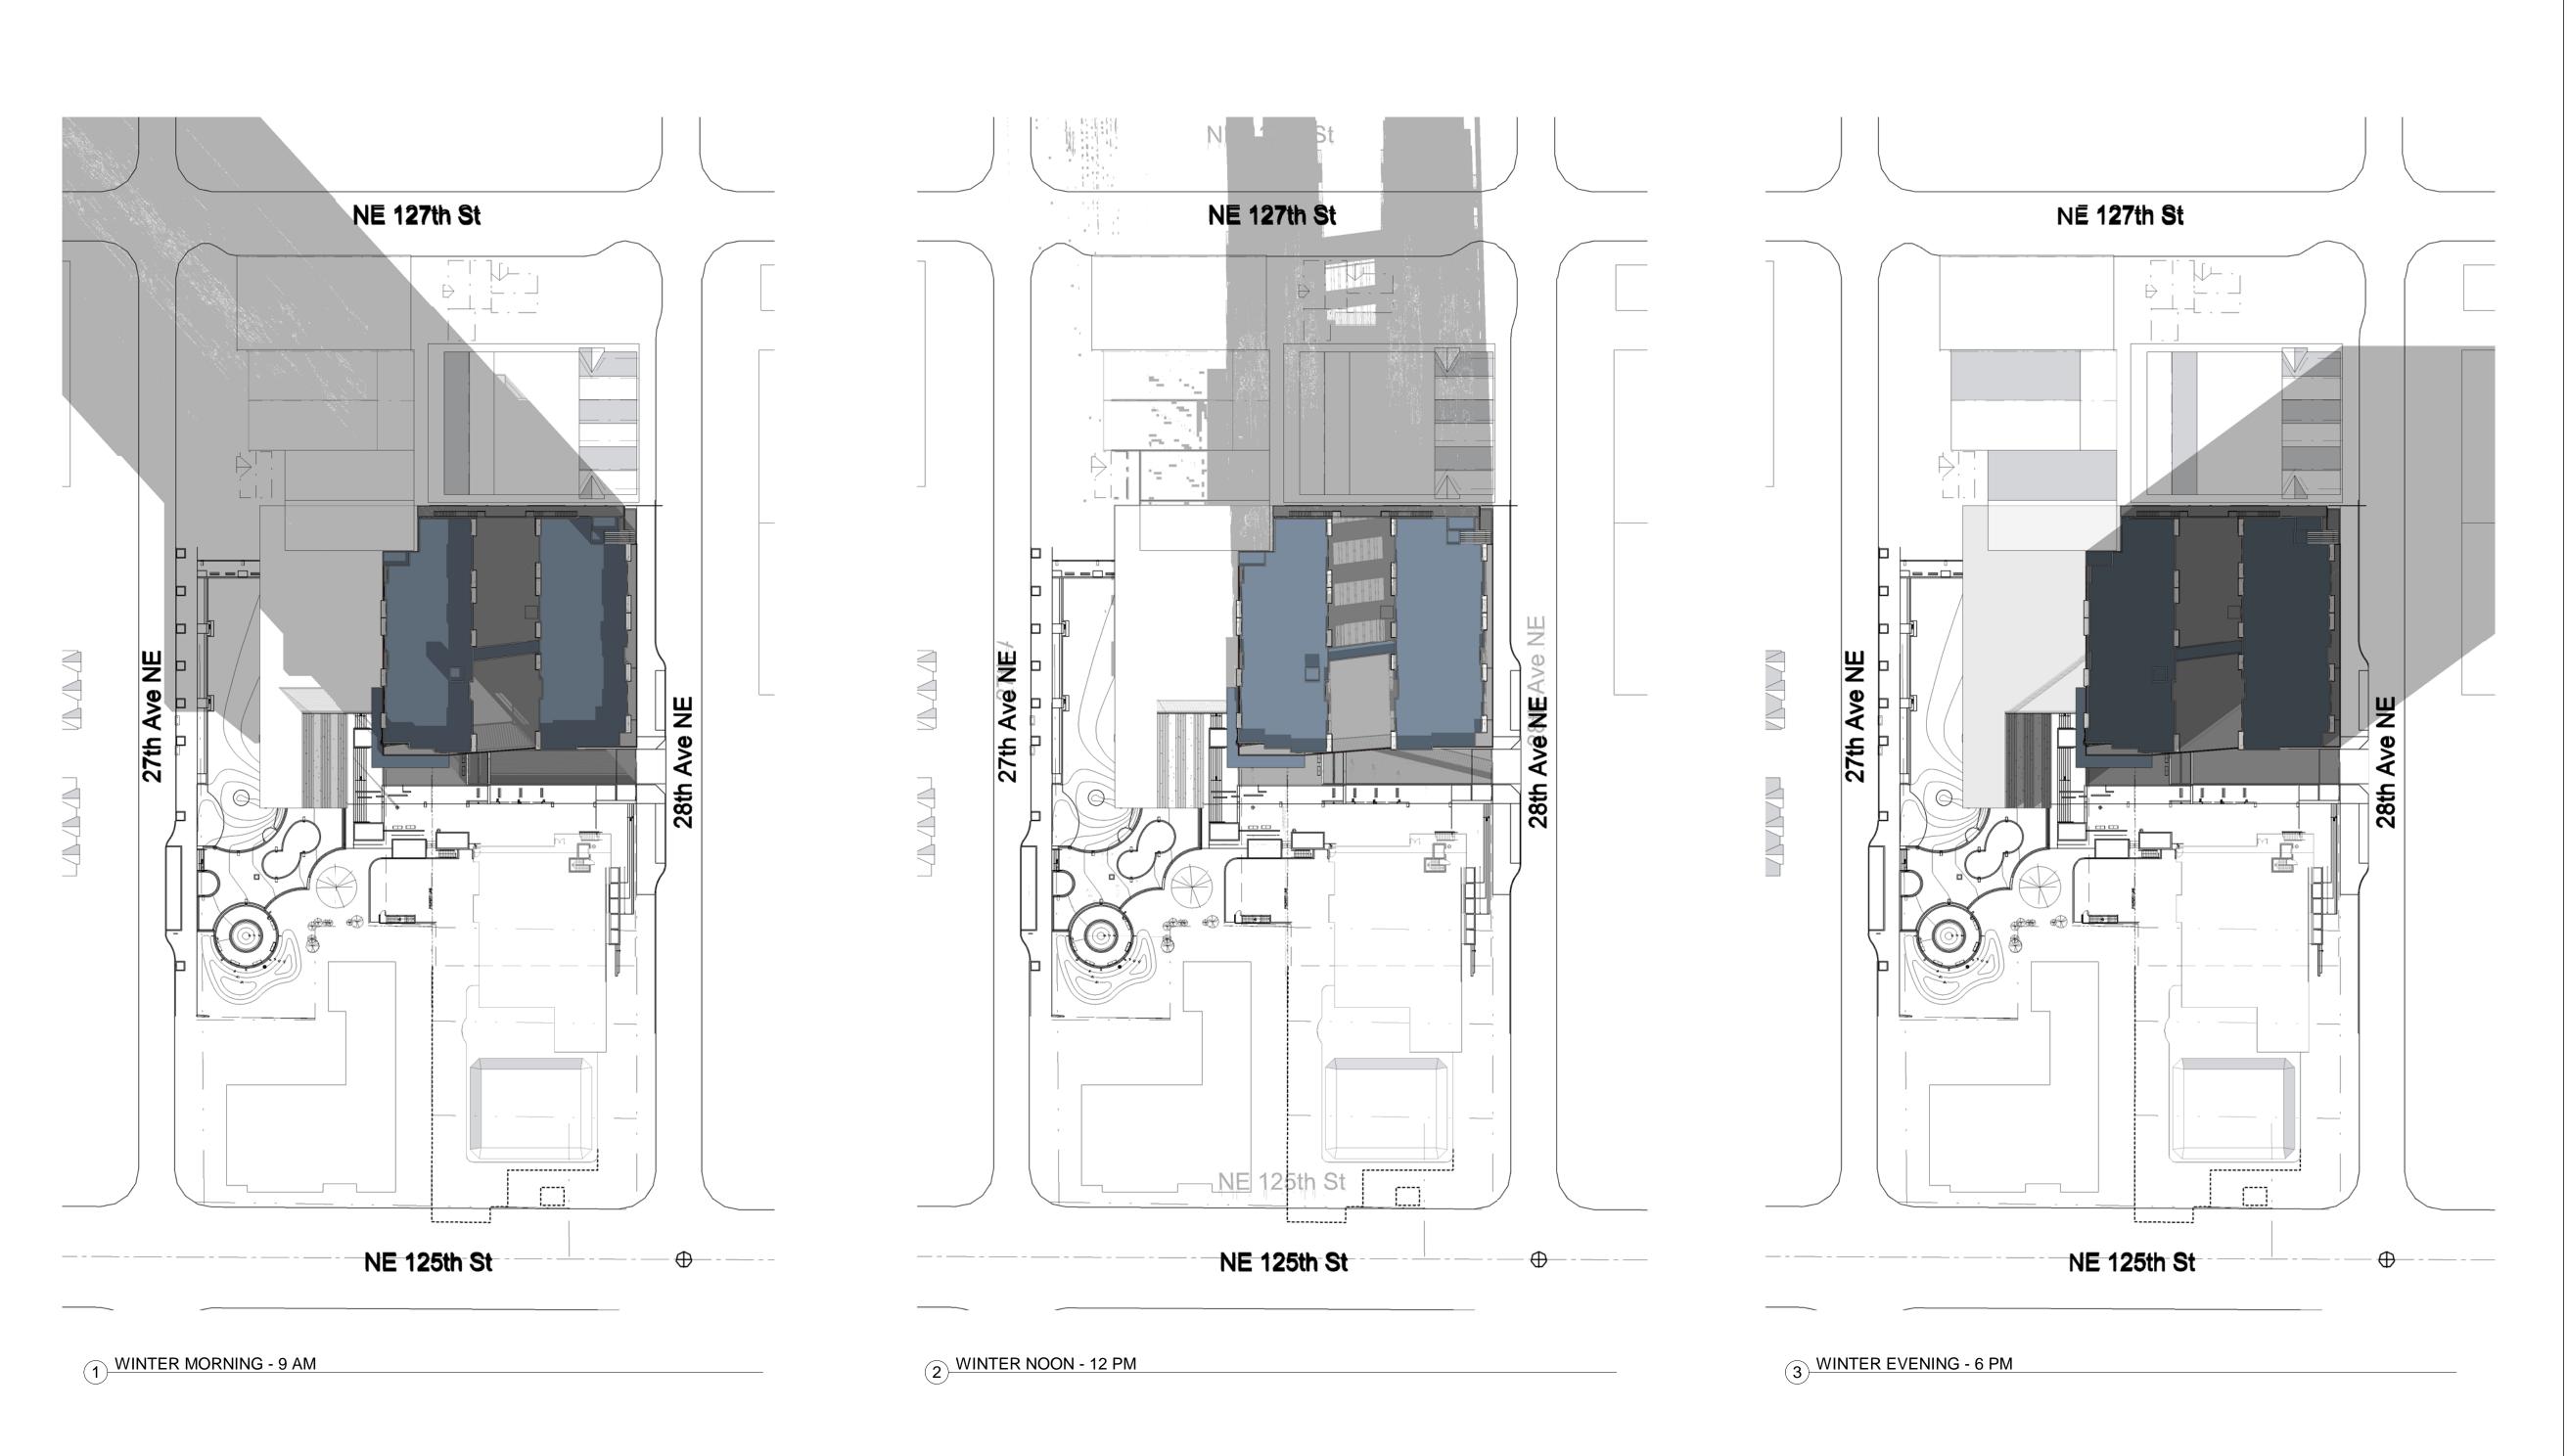
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SUN STUDY AT WINTER TIME (21TH DECEMBER)

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